

**CITY OF PALM BEACH GARDENS
CITY COUNCIL
Agenda Cover Memorandum**

Meeting Date: November 3, 2016
Resolution 65, 2016





Subject/Agenda Item:

Site Plan and Major Conditional Use

Public Hearing and Consideration for Approval: A request for site plan approval for a 360,203-square-foot commercial mixed-use retail center on a 40.8-acre site. This petition also includes a request for a Major Conditional Use approval for a restaurant with drive-through within the Town Center (Parcel C) of the Alton Planned Community Development (PCD). The Town Center is located on the northeast corner of the Donald Ross Road and Alton Road intersection, and the Alton PCD is generally located south of Donald Ross Road, north of Hood Road, and east and west of Interstate 95.

Recommendation to APPROVE

Recommendation to DENY

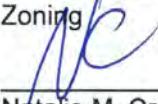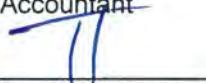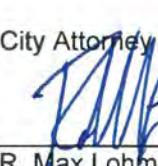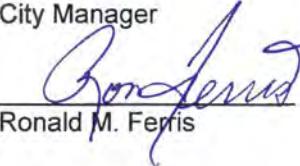Reviewed by: Director of Planning and Zoning  Natalie M. Crowley, AICP	Originating Dept.: Planning & Zoning: Project Manager  Peter Hofheinz, AICP Principal Planner	Finance: Accountant  Tresha Thomas	Council Action: <input type="checkbox"/> Approved <input type="checkbox"/> Approved w/ Conditions <input type="checkbox"/> Denied <input type="checkbox"/> Continued to: _____
Development Compliance and Zoning Manager  Bahareh Wolfs, AICP	<input checked="" type="checkbox"/> Quasi – Judicial <input type="checkbox"/> Legislative <input checked="" type="checkbox"/> Public Hearing	Funding Source: <input type="checkbox"/> Operating <input checked="" type="checkbox"/> Other N/A	Attachments: • Development Application • Project Narrative • Location Map • Resolution 65, 2016
City Attorney  R. Max Lohman, Esq.	Advertised: <input checked="" type="checkbox"/> Required <input type="checkbox"/> Not Required Date: 10/19/2016 Paper: Palm Beach Post	Budget Acct.#: N/A Contract/Agreement: Effective Date: N/A	
Approved By: City Manager  Ronald M. Ferris	Affected parties: <input type="checkbox"/> Notified <input checked="" type="checkbox"/> Not Required	Expiration Date: N/A	

EXECUTIVE SUMMARY

The subject petition is a request for site plan approval for the remaining vacant 40.80 acres of the Alton PCD Town Center District to construct the commercial retail portion of the Alton Town Center. The Alton Town Center District, identified as Parcel C on the PCD master plan, was approved to contain a mixture of uses that include commercial, office and residential. Two (2) projects previously approved by the City Council (Alton Neighborhood 1 and Atlantico) for the Town Center District were residential projects, and this petition seeks to fulfill the intent of the district through the provision of the commercial center.

The site plan consists of a 40.8-acre site with approximately 360,203 square feet of commercial retail development. Included within this commercial retail space is a grocery store, fitness center, a home improvement store, a gas station with a carwash, a variety of general retail uses, restaurant uses, a restaurant with drive-through (major conditional use) and a financial institution with a remote drive-through. The project's design is centered on the required Primary and Premier Streets incorporating the "main street" concept along with the central square designed for a multitude of pedestrian-oriented activities. The Applicant is requesting four (4) waivers. Staff is recommending approval of all four (4) waivers. A detailed analysis of the waivers and project is included in the following staff report.

Staff recommends approval of the Site Plan and Major Conditional Use.

BACKGROUND

On April 1, 2010, the City Council adopted Resolution 80, 2009, thereby approving the Application for Development Approval (ADA) for the Scripps Florida Phase II/Briger Tract Development of Regional Impact (DRI). The development program for the DRI consists of 2,600,000 square feet of industrial/research and development/biotech, 1,200,000 square feet of office, 300 hotel rooms, 500,000 square feet of retail development, and 2,700 dwelling units on approximately 681 acres located along the south side of Donald Ross Road, north of Hood Road, and east and west of Interstate 95.

On August 15, 2013, the City Council adopted Resolution 44, 2013, approving a Notice of Proposed Change (NOPC) to the DRI Development Order to modify three (3) conditions of approval related to intersection improvements: Donald Ross Road and Heights Boulevard Extension, and Donald Ross Road and the entrance to Florida Atlantic University, (FAU).

On April 3, 2014, the City Council adopted Resolution 21, 2014, approving modifications to utility easements, roadway cross-sections and buffers, lakes, open space, and revisions to conditions of approval.

On June 5, 2014, the City Council adopted Resolution 30, 2014, approving a site plan to allow the development of 360 townhome and single-family dwelling units within Parcel C – Town Center District.

On August 8, 2015, the City Council adopted Resolution 31, 2015, approving a Community Design Elements and signage package for the Alton PCD.

On October 8, 2015, the City Council adopted Resolution 44, 2015 and Resolution 45, 2015, approving a PCD conversion of four (4) multifamily dwelling units to three (3) additional apartment units for a total of 353 apartment units for the Atlantico at Palm Beach Gardens site plan within Parcel C – Town Center District.

On October 8, 2015, the City Council adopted Resolution 46, 2015, approving the site plan for a 241,400-square-foot Center for Intelligent Buildings Technology Complex within Parcel B of the Alton PCD.

On April 7, 2016, the City Council adopted Resolution 24, 2016, approving a site plan amendment to reduce the Center for Intelligent Buildings Technology Complex building square footage to 224,066 square feet, and to provide architectural, site, and landscape plan modifications in Parcel B of the Alton PCD.

On May 5, 2016, the City Council adopted Resolution 31, 2016, approving a site plan for a 3.5-acre community recreation and fitness facility to serve the residents of the Alton Community. The facility is located at the intersection of Alton Road and Grandiflora Road.

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LAND USE & ZONING

The land-use designation of the subject site, as shown on the City's Future Land Use Map, is Mixed Use (MXD) with a zoning designation of Planned Community Development (PCD) overlay with an underlying zoning designation of Mixed Use (MXD). The existing land uses and zoning designation of the properties surrounding the subject site are provided in the table below. This particular site is located within Parcel C of the PCD.

Table 1. Existing Zoning & Future Land-Use Designations

EXISTING USE	ZONING	LAND USE
<u>Subject Property</u> Alton DRI	Planned Community Development (PCD) / Mixed Use (MXD)	Mixed Use (MXD)
<u>North</u> Donald Ross Road Abacoa DRI (Town of Jupiter)	Mixed Use (MXD)	Mixed Use (MXD)
<u>South</u> Mandel Jewish Community Center	Planned Unit Development (PUD) / Mixed Use (MXD)	Mixed Use (MXD)
Westwood Lakes and Gardens	Planned Unit Development (PUD) / Residential Medium (RM)	Residential Medium (RM)
Trevi at the Gardens	Planned Unit Development (PUD) / Residential Medium (RM)	Residential Medium (RM)
Franklin Academy	Planned Unit Development (PUD) / Public/Institutional (P/I)	Mixed Use (MXD)
<u>East</u> Legends at the Gardens	Planned Unit Development (PUD) / Mixed Use (MXD)	Mixed Use (MXD)
San Michele	Planned Unit Development (PUD) / Residential Low Density 3 (RL-3)	Mixed Use (MXD)
Benjamin School	Planned Unit Development (PUD) / Public Institutional (P/I)	Residential Low (RL)
<u>West</u> East Pointe Country Club (Palm Beach County)	Mixed Use (MXD) Planned Community Development (PCD)	Mixed Use (MXD)

CONCURRENCY

Traffic

Traffic Concurrency has been reserved through the PCD/DRI approval process. The DRI utilized a Proportionate Share Agreement in order to meet the local traffic concurrency and address the impacts from the DRI. The Master Developer entered into a Proportionate Share Agreement with Palm Beach County, the Florida Department of Transportation, the Florida Turnpike Enterprise Authority, and the City of Palm Beach Gardens. The agreement addresses local traffic concurrency requirements and the specific traffic improvements that must be made to address the impacts of the DRI. The Proportionate Share Agreement contains a scheduled list of roadway improvements and payments that are required by the Applicant as the vehicle trip thresholds are triggered. The DRI has been phased based upon the permitted amount of trips, and once each trip threshold is triggered, the next Proportionate Share payment is required for building permits to be approved. In order to monitor the vehicle trips generated by the individual site plans proposed within the DRI and the required Proportionate Share payment, conditions of approval were included in Resolution 80, 2009 that require a trip generation analysis be performed prior to each site plan approval. The trip generation analysis for subsequent site plans are cumulative and must include all currently valid previous site plan approvals. If a trip generation analysis demonstrates that development of the site plan under consideration would generate any vehicle trips over the established vehicle trip threshold, then the subsequent Proportionate Share payment is required.

The Town Center (Parcel C) is permitted by the approved master plan to have a maximum of 450,000 square feet of retail use. The Applicant submitted a trip conversion analysis that utilized a conversion matrix and methodology included in the traffic analysis approved with the DRI to convert the 450,000 square feet of approved retail use to the specific development program proposed with this site plan.

The trip conversion analysis was reviewed by the City's traffic consultant to verify that the proposed development program will generate approximately 393 AM Peak-Hour trips, and 841 PM Peak-Hour trips. The maximum number of vehicle trips allowed under Phase 1 of the DRI include 1,369 AM Peak-Hour trips and 2,174 PM Peak-Hour trips. The proposed development program does not generate enough vehicle trips to go over the established threshold for Phase 1; therefore, the site plan is in compliance with the DRI/PCD and Proportionate Share Agreement.

Drainage

The drainage system for the project has been designed in accordance with the City's and South Florida Water Management District's requirements. The system consists of a series of interconnected catch basins and pipes that connect to the master storm water system for the PCD.

PROJECT DETAILS

The project is required to be designed based on the design concepts and principals outlined in the design guidelines approved with the PCD master plan via Resolution 1, 2010. These concepts and principals include the creation of pleasant and interconnected outdoor spaces and uses through the provisions of an integrated roadway network, building location to define public spaces, and the creation of a pedestrian-friendly environment with the provision of shelter or shade for comfort.

The site is located in the northern most section of the Town Center District adjacent to Donald Ross Road on the south side and directly north of the Town Center District lake and Atlantico project. The site plan design consists of 16 buildings that vary in size and footprint. The buildings are located along the required Premier Street ("Main Street"), Primary Street, and Secondary Streets identified in the design guidelines. The proposed development program consists of 221,561 square feet of general retail uses that include a grocery store, fitness center, personal services, specialty and quality restaurants, a 119,361-square-foot home improvement store (which includes a 19,379-square-foot garden center), 2,006 square feet of restaurant with drive-through, a 3,475-square-foot financial institution with drive-through, a gas station with a carwash, and approximately 13,800 square feet of outdoor seating area on a 40.80-acre site for a total of 360,203 square feet of development. The Applicant has identified the large anchor tenants to be within Building 'A' as a grocery store, Building 'S' as a fitness center, and Building 'T' as the home improvement store. The remaining buildings may contain a variety of commercial and retail uses consistent with the List of Permitted Uses for the Town Center District approved with the original PCD master plan.

Project Design

Overall Design Theme

It is important that the Town Center Commercial area has a level of design consistency and compatibility throughout the project as it relates to architectural style, building colors, construction materials, and architectural details. To this end, the Applicant has provided architectural building elevations, illustrations and details of common space elements and features, pavement treatments, and landscaping that have been reviewed by Staff to ensure that the overall design theme within the commercial area is carried out across all buildings and amenities. The Applicant is proposing a contemporary design theme utilizing linear and right-angular design elements. Many of the construction materials for the project's buildings, hardscape features, landscape species, roadway pavers, and site lighting either match or are designed to be compatible with many of the materials throughout the Alton PCD. These include corten steel, simulated porcelain tile wood product, paver bricks, Japanese Blueberry street trees, and consistent light fixture designs. Staff has determined that the overall design theme is consistent.

Interconnectivity within the Town Center District

A key design principal to facilitating and promoting a pedestrian friendly and oriented Town Center District is interconnectivity between individual projects and uses. The construction of the land bridge over the Town Center lake, the Premier Street, and Primary Street, as identified on the Alton master plan, will provide the necessary infrastructure for the residents living in the residential areas to the south (Neighborhood 1 and Atlantico) of the Town Center Commercial area via the land bridge and other local roads without having to travel along Alton Road.

Roadway Network

Access

The project has three (3) points of access from Donald Ross Road. The eastern and western most project access points along Donald Ross Road onto the project's Secondary Streets will be right-in and right-out only. The central project access point along Donald Ross Road onto the Premier Street will be aligned with the Florida Atlantic University (FAU) entrance and will provide full access and be signalized. The Applicant will be responsible for providing a surety bond for the traffic signal and issuing construction contracts for the removal of the median restriction on Donald Ross Road.

There will be two (2) project access points along Alton Road. The northern most access point onto the project's Secondary Street will be a right-in and right-out only. The southern access point onto the Primary Street will be full access. In addition, all of the access points along Donald Ross Road accommodate pedestrian access via the 12-foot pathway within the 55-foot-wide parkway buffer, and the Alton Road access points are interconnected into the Alton PCD's internal sidewalk network along Alton Road providing for significant pedestrian access.

Integrated Roadway Network

The Town Center Commercial area is based on a gridded design of roadways and driveways running parallel and perpendicular to each other. These roadways include the remaining north portion of the Premier Street, the completion of the Primary Street, and smaller Secondary Streets. Each street design includes minimum five-(5) foot-wide pedestrian sidewalks, and all the sidewalks along the Premier Street and Primary Street have wider eight-(8) to 15-foot wide sidewalks and pedestrian areas. To further facilitate and encourage pedestrian activities within the Town Center Commercial Area, the Applicant is providing a variety of hardscape shade features, including trellis and canopies with benches to provide comfort and relief to pedestrians. These features have been located strategically at midblock street crossings and various intervals along the project's streets. In addition, all entrances and exits from the project's buildings are connected by an integrated sidewalk system throughout the Town Center Commercial Area and ultimately connecting the Alton PCD wide sidewalk network.

Premier Street

The Premier Street runs north to south and begins at Donald Ross Road traveling south, splitting the Atlantico multifamily residential community in the middle, and completes at its intersection with the residential road Faulkner Terrace in Neighborhood 1. The remaining north portion of the Premier Street will be completed with this project. This section of the street will be constructed with paver bricks. The paver bricks will provide an enhanced street texture and aesthetics and identify that a person has entered a commercial area. The street features wide pedestrian sidewalks along both sides, hardscape amenities such as benches, decorative street lights, shade structures, shaded gathering areas and street trees to provide additional shade, and on-street parking. Pedestrian crosswalks are identified through the use of a contrasting paver brick color and style from the color and style used to construct the street, thus alerting drivers of the potential for pedestrians. The street successfully connects the Town Center Commercial Area, the multifamily and single-family neighborhoods of the Town Center District.

Primary Street

The Primary Street will provide east to west access from Alton Road to the Town Center Commercial Area and the Atlantico multifamily residential community, completing at its intersection with the Premier Street at the roundabout. The street provides access to the project's central plaza from Alton Road and divides the Alton Town Center Commercial Area from the Atlantico multifamily residential community. The Primary Street is designed with eight-(8) foot-wide pedestrian sidewalks on each side, on-street parking, bicycle lanes, decorative street lighting, pedestrian sitting areas, and small plazas, etc. The Applicant is also going to provide signature art pieces along this street.

Roundabout

The intersection of the Premier Street and Primary Street is identified by a roundabout that will be constructed with decorative concrete and paver bricks and features landscaping with an artistic 10-to 12-foot-tall fountain in the middle. The roundabout has been carefully designed and reviewed by Staff to provide an aesthetically pleasing viewing vista looking north or south along the Premier Street and looking east along the Primary Street. It is also visible from the Town Center Commercial Area's central plaza and the adjacent Atlantico multifamily apartments.

Secondary Streets

The project's Secondary Streets provide both east to west access from Alton Road through the project and north to south access from Donald Ross Road through the project. The northern most Secondary Street that runs east to west provides access to the buildings that front along Donald Ross Road and parking areas in the center of the project. The street includes five- (5) foot-wide sidewalks on each side constructed from paver bricks, a large quantity of Japanese Blueberry trees as street trees, and a low Podocarpus planting material to screen the vehicle parking areas that abut the north

and south sides of the street. The other two (2) Secondary Streets provide north to south access through the site, including five-(5) foot-wide sidewalks on each side constructed of paver bricks, on-street parking, triple trunk Montgomery Palms and Green Buttonwood trees. These Secondary Streets are designed to provide a comfortable experience for pedestrians.

Architecture

The design guidelines include architectural guidelines to ensure a level of consistency and compatibility to the overall architectural style and design within the commercial area of the Town Center District. The architectural guidelines allow for a degree of flexibility in their application of design components and planning principles for high-visibility locations versus less visible locations, thus establishing a gradation of design applicability. The architectural design guidelines contain nine (9) building design principles that include, but are not limited to, requiring buildings at street corners to be significant structures, enhancing public and semi-public spaces with buildings, relating buildings to streets, providing buildings that shelter pedestrians from the sun, and using massing and roof forms to emphasize the location of entries. In addition to these building design principles, there are architectural design requirements regarding façade/wall height transitions, design treatments (i.e., canopies, overhangs, ornamental details, decorative towers, articulated facades, etc.), preferred exterior wall finishes and roof materials, and specifics for corner lots. To this end, the Applicant's architectural design integrates the above building design principles and architectural design requirements.

The Applicant is incorporating a contemporary styled architecture for the project's buildings and overall design theme. The application of linear building design elements in conjunction with the street grid network and right angular open space areas and plazas all contribute to the contemporary atmosphere and theme of the project.

Architectural design elements include towers, building roof step backs, and vertical and horizontal scoring and application of building materials. Other design features and construction materials include horizontal roof overhangs, thin horizontal metal awnings, metal roof cornices, stone veneer, porcelain tile with a wood grain finish, smooth stucco building finishes, exterior metal panel systems, and other aluminum products with a corten steel finish. The application of building colors are intended to contrast against the above textured materials to give the project visual interest.

Orientation of Buildings

The site plan depicts the size, location, and orientation of the buildings throughout the project along with the identified Premier Street, Primary Street, and Secondary Streets. The Applicant is proposing to locate eight (8) of the project's 16 buildings adjacent to the Donald Ross Road parkway buffer. These include Buildings 'D', 'E', 'F', 'G', 'H', 'I', 'J', and 'K'. The master developer designed the parkway buffer to be pedestrian oriented through the inclusion of a 12-foot-wide meandering pathway, pedestrian scale lighting, and small pedestrian seating areas and plazas located at various locations.

Buildings 'L', 'M', 'O', 'P', 'Q', 'R', and 'S' have been oriented towards the Premier Street to create and define the streetscape. Buildings 'A', 'C', and 'T' are located on opposite sides of the project. These buildings are for the large format grocery store and home improvement store. Their locations anchor the east and west boundaries of the project. A brief description of these buildings and their anticipated uses is described below.

Moving from west to east on the project's site plan along Donald Ross Road, Building 'D' anchors the corner of Alton Road, and Donald Ross Road is anticipated to be a single-tenant restaurant user; Building 'E' is a multi-tenant building that includes the restaurant with drive-through use on the west side of the building; Buildings 'F' (single-tenant restaurant) and 'G' (multi-tenant) have been oriented to create a public plaza that can be accessed from the parkway buffer meandering pathway; Building 'H' (multi-tenant) and Building 'I' (single-tenant restaurant) are also oriented to create a second public plaza accessed from the parkway buffer meandering pathway; Building 'J' is anticipated to be a financial institution that provides a remote drive-through located within the parking area; and finally the eastern most building that is adjacent to the Florida Power & Light property is proposed to be a gas station with a carwash. With the locations of these buildings along the parkway buffer and four (4) of the buildings oriented to create public pedestrian plazas, the Applicant is achieving a key design principle identified in the design guidelines that is to locate buildings to clearly define public spaces.

Buildings 'L', 'M', 'O', 'P', 'Q', 'R', and 'S' are oriented to create and define the Premier Street streetscape. At the intersection of the Premier and Primary Street, at the roundabout, the ends of Buildings 'Q' and 'R' define the large 42,981-square-foot central plaza that is a main feature of this project. Across the Premier Street, Building 'S' anchors the east side providing building massing and definition to this public space.

Central Plaza

The design guidelines require the Town Center District to include a central square that is to be located adjacent to the Premier Street and designed for a multitude of pedestrian-oriented activities. The square is required to be a minimum of 20,000 square feet. Generally, the Applicant is proposing a central plaza in the northwest corner of the intersection of the Premier Street and Primary Street. The boundaries and space of the central plaza are defined by Buildings 'Q', 'R', and 'S'. The design of the plaza includes Wild Date Palms and Japanese Blueberry Trees in raised planters, a water wall, and other pedestrian-oriented hardscape features arranged to create energy and gathering areas. Buildings 'Q' and 'R' help to define the plaza space and are anticipated to be utilized by restaurant uses that include large covered outdoor patio seating. This collocation of uses will provide a pedestrian plaza fulfilling the intent of the design guidelines for this area.

Landscaping and Buffering

Landscape Buffers

The approval of the Alton PCD master plan established the required PCD buffers and road right-of-way buffers for the PCD's internal collector roads that include Alton Road, Grandiflora Road, and Pasteur Boulevard. The master developer has constructed both the 55-foot Donald Ross Road parkway buffer and 30-foot Alton Road right-of-way buffer adjacent to this project. The Donald Ross Road parkway buffer features a 12-foot meandering pathway, pedestrian amenities and lighting, and a landscape pallet of clusters of native trees and palms and understory plantings consisting of Live Oak Trees, Slash Pine Trees, Sabal Palm Trees, Dahoos Holly Trees, Way Myrtle Trees, in addition to a variety of shrubs and grasses. The Alton Road right-of-way buffer adjacent to this project includes signature specimen Date Palms, Live Oaks, and a variety of ground covers and grasses.

The contemporary design theme of this project based upon the gridded street format provides many opportunities for creating focal point views within the project. To this end, the Applicant is utilizing the Medjool Palm as a signature tree within the development. These trees have been located at all vehicle entry points into the project, vehicle parking areas, street intersections, and is also the primary landscape streetscape element along the Premier Street in addition to the Wild Date Palms to provide variety. The palm tree palette used to achieve the Applicant's desired landscape theme includes Medjool Date Palms, Christmas Palms, Wild Date Palms, Royal Palms, and triple Montgomery Palms. Along the Secondary Streets, the Applicant makes extensive use of the Japanese Blueberry Tree which can be found throughout the Alton development providing a level of cohesiveness and consistency among the projects. Finally, within the parking area landscape islands, the Applicant is utilizing Gumbo Limbo Trees, Green Buttonwood Trees, and Ligustrum Trees. The Primary Street that divides this project from the adjacent Atlantico residential project has been designed to include Live Oak Trees, to remain consistent with the streetscape design of Atlantico.

Primary Street Landscape Buffer

On the north side of the Primary Street beginning at Building 'A' and continuing to the central plaza, the Applicant is proposing a 22-foot to 39-foot landscape buffer to fully screen the back of store operations for Buildings 'A' and 'C' and 'O', 'P', and 'Q'. The landscape buffer is being planted with Live Oak Trees, Areca Palm Trees, clusters of Sabal Palm Trees, Ligustrum Trees, large Clusia hedges, and additional shrubs and ground cover; and behind all of the landscaping the Applicant is including a 12-foot-tall screen wall. This thick and heavily landscaped buffer will provide adequate screening of the back of house operations and uses for those buildings.

Parking

Vehicle Parking

Based on the Applicant's proposed development program, the project is required to have 1,723 parking spaces utilizing the Mixed Use/Shopping Center parking ratio of one (1) space per 200 square feet pursuant to Section 78-345 of the City's Code. The site plan is providing a total of 1,679 parking spaces that are 9.5-foot by 18.5-foot in size. The proposed 1,679 parking spaces are less than the total required amount of parking spaces by 44 spaces. The Applicant is requesting a waiver for a reduction in the required number of parking spaces. Please see Waiver Section.

Bicycle Parking

The Applicant is providing 84 bicycle parking spaces in 20 individual bicycle racks in various locations around the project. This total of 84 spaces is consistent with the design guideline requirement that the number of bicycle spaces provided be five percent (5%) of the total gross number of parking spaces. The location of the bicycle racks was chosen based on convenience and accessibility for people riding bicycles. For example, bicycle racks were located between two (2) buildings, close to building entrances, and around the central plaza.

Lighting

The design guidelines require project lighting to utilize decorative lamp posts and lighting fixtures to serve pedestrian and multimodal areas and be consistent with lighting requirements set forth in Section 78-182 of the City's Code. To this end, the Applicant has submitted photometric plans that have been reviewed by Staff. The Applicant is including pedestrian scale lighting poles and fixtures that are consistent with the other pedestrian lighting found throughout the Alton project. This will provide a cohesive design and compatibility throughout the Town Center District and PCD. The photometric plans also contain details on the parking area lighting. Staff has reviewed these poles and fixtures and found them to be compatible with the proposed development. In addition to this project lighting, the Applicant will be providing building accent lighting and up lighting in the project's common and open space areas and to accent the project's signature hardscape features and plazas.

Signage

The Applicant is required to provide a master signage plan, as a separate application, to be reviewed and approved by the Development Review Committee (DRC), the Planning, Zoning, and Appeals Board (PZAB), and the City Council for this project. The master signage plan will include monument signs, wall signs, directional signs, etc.

MAJOR CONDITIONAL USE ANALYSIS

A Conditional Use Analysis has been provided as part of the application in accordance with Section 78-52(d), *Conditional uses*, of the Land Development Regulations for the proposed restaurant with drive-through use.

The following is Staff's analysis based on the criteria set forth in Section 78-52(d), *Conditional Uses*:

(1) Comprehensive Plan. The proposed use is consistent with the comprehensive plan.

The comprehensive plan designation for this site is Mixed Use Development District (MXD). The use is consistent and compatible with the comprehensive plan.

(2) Chapter requirements. The proposed use is consistent with all applicable requirements of this chapter.

The proposed use is consistent with all applicable requirements of Chapter 78 of the City's Code.

(3) Standards. The proposed use is consistent with the standards for such use as provided in Section 78-159.

The proposed use is in compliance with the requirements set forth in Section 78-159 of the City's Code based on the requested waivers approved by City Council.

(4) Public welfare. The proposed use provides for the public health, safety, and welfare by:

a) Providing for a safe and effective means of pedestrian access;

The proposed project provides for pedestrian sidewalks along the south part of the building.

b) Providing for a safe and effective means of vehicular ingress and egress;

The site has adequate access and includes a vehicle bypass lane as required.

c) Providing for an adequate roadway system adjacent to and in front of the site;

The project includes an adequate roadways system adjacent to and in front of the site.

d) Providing for safe and efficient onsite traffic circulation, parking, and overall control; and

The proposed site plan addresses all safety concerns and provides efficient on-site vehicle circulation and pedestrian access.

- e) **Providing adequate access for public safety purposes, including fire and police protection.**
The site has been designed to address all comments and concerns from both the fire and police departments.
- (5) **Screening and buffering.** The proposed use utilizes such techniques as landscaping, screening, buffering, site or building design, or business operation procedures to mitigate impacts on surrounding properties, including such impacts as:
 - a) **Noise;**
The proposed restaurant with drive-through is required to meet all noise requirements outlined in the City's Performance Standards (Section 78-661 of the City Code). The building that includes the drive-through use is located within the Town Center Commercial Area, and is over 600 feet from the nearest residential building in the adjacent residential project.
 - b) **Glare;**
No activities will be conducted outside that would create any glare and the site's lighting is consistent with the City's lighting regulations.
 - c) **Odor;**
The site design provides the required number of dumpsters and trash compactors. Waste management will regularly pick up waste. Solid waste collection for commercial typically occurs bi-weekly.
 - d) **Ground-, wall-, or roof-mounted mechanical equipment;**
All ground- wall- and roof-mounted mechanical equipment will be screened, consistent with the standards found in the City's Land Development Regulations.
 - e) **Perimeter, interior, and security lighting;**
The proposed project will meet the lighting standards of the City's Land Development Code.
 - f) **Signs;**
The Applicant will be providing a master signage program under separate cover at a later date.
 - g) **Waste disposal and recycling;**
Waste disposal and recycling will be regularly picked up by the waste management system, consistent with other businesses with the Town Center Commercial Area.
 - h) **Outdoor storage of merchandise and vehicles;**
No outdoor storage of merchandise or vehicles is proposed with this use.

i) Visual impact; and

The project's setbacks and proposed landscape buffers will mitigate some of the visual impact the proposed use may create. In addition, the Applicant is exceeding the required architectural standards to further mitigate the visual impact.

j) Hours of operation.

The proposed retail and restaurants will hold normal business hours. No 24-hour restaurants are proposed. A condition of approval will be included in the development order restricting the hours of operation to ensure no 24-hour restaurants will operate.

(6) Utilities. The proposed use minimizes or eliminates the impact of utility installation, including underground and overhead utilities, on adjacent properties.

The proposed use will be part of a new large commercial development that will feature new underground utilities constructed to serve this use and all other uses.

(7) Dimensional standards. The proposed use meets or exceeds all dimensional requirements required by the chapter.

The proposed use is located within a commercial multi-tenant building that meets the dimensional standards of this chapter.

(8) Neighborhood plans. The proposed use is consistent with the goals, objectives, policies, and standards of neighborhood plans.'

Not applicable.

(9) Compatibility. The overall compatibility of the proposed development with adjacent and area uses, and character of area development.

The Town Center Commercial Area is part of the Town Center District within the Alton Mixed Use PCD and approved for commercial, residential, and other non-residential uses. The development of this area as a commercial development was previously planned and anticipated.

(10) Patterns of development. The proposed use will result in logical, timely, and orderly development patterns.

The development of the Town Center Commercial Area is consistent with the original intent and approval of the Alton Mixed Use PCD. The two (2) other projects approved within the Town Center District are residential projects, and the development of the commercial area completes the anticipated development pattern. The drive-through use will not be visible from Donald Ross Road.

(11) Purpose and intent. The proposed use will be in harmony with the general purpose and intent of this chapter and the goals, objectives, and policies of the city.

The proposed uses are consistent with the list of permitted uses approved with Resolution 1, 2010 that approved the Alton Mixed Use PCD; therefore, they are

consistent with the intent of this chapter and the goals, objectives, and policies of the City.

(12) Adverse impact. The design of the proposed use and structures will minimize any adverse visual impacts or impacts caused by the intensity of the use.

The proposed use and the associated drive-through lanes are being significantly screened from public view along Donald Ross Road. In addition, the use is located along a Secondary Street and not the project's main street, further mitigating the potential impacts.

(13) Environmental impact. The design of the proposed use minimizes any adverse impacts that may be created, including impacts on environmental and natural resources including air, water, stormwater management, wildlife, vegetation, and wetlands.

The environmental impacts associated with the development of this project have been previously mitigated and shall comply with the approval of the DRI and PCD development order in 2010.

Waiver Request/Staff Analysis

The Applicant is requesting four (4) waivers with this petition.

	Design Guidelines Section	Requirement	Proposed	Waiver	Staff Support
1	Section B.5.c.(7)(b): Primary Street Setbacks	Building located within ten (10) feet of street build-to-line	None	No building	Approval
2	Section B.5.c.(7)(b): Primary Street Setbacks	80% of building elevation located within ten (10) feet of streets build-to-line	None	No building elevation	Approval
3	Section B.5.c.(7)(c): Secondary Streets	Provide five-(5) foot bicycle lane and On-Street Parking	Removal of bicycle lane and on-street parking on north-south Secondary Streets only	No bicycle lane and no on-street parking on east-west Secondary Street	Approval
4	Section B.5.c.(4): Parking Regulations	Total parking spaces required = 1,723	Total parking spaces proposed = 1,679	44 parking spaces or 2.5%	Approval

- 1) The Applicant is requesting a waiver from design guidelines Section B.5.c.(7)(b), *Primary Streets*, which requires buildings to be located within ten (10) feet of the build-to-line along the Primary Street. The Primary Street, as identified on the PCD master plan, and discussed in the sections of this Staff report, connects Alton Road to the Town Center Commercial Area and the Atlantico residential community, and

terminates at the intersection with the Premier Street in a roundabout. Build-to-lines are a line at which construction of a building is to occur. The Applicant is seeking relief from this requirement to provide for the necessary back-of-store operations that include loading, unloading, trash and refuse storage, etc., for Buildings A/C and O/P/Q. Access to the rear of these buildings will be from the service alleyway that runs parallel to the Primary Street. To mitigate, buffer, and screen these back-of-store operations the Applicant has designed a landscape and hardscape buffer that varies in width from 22 feet to 39 feet in some locations. The landscape portion of this buffer will be thickly planted with Live Oak Trees, Areca Palms Trees, clusters of Sabal Palm Trees, Ligustrum Trees, large Clusia hedges, and additional shrubs and ground cover; and behind all of the landscaping, the Applicant is including a 12-foot-tall screen wall. In addition, in order to continue to "activate" the street for pedestrians and fulfill the intent of the required build-to-lines, the buffer includes an eight-(8) foot-wide meandering pathway, decorative pedestrian street lighting, seating areas with signature shade structures, and locations for future outdoor art. Staff has worked with the Applicant to ensure that the view corridors of these rear service areas from the pedestrian level street views and from the adjacent Atlantico residential project are sufficiently screened. *Staff recommends approval.*

- 2) The Applicant is requesting a waiver from design guidelines Section B.5.c.(7)(b), *Primary Streets*, which requires 80% of building elevations to be located within ten (10) feet of the Primary Street's build-to-line. As discussed above, the Applicant is seeking relief from this requirement in order to provide for the necessary back-of-store operations for buildings A/C and O/P/Q via the service alleyway. The Applicant is mitigating, buffering, and screening these back-of-house operations and implementing design strategies and techniques to "activate" the street as described above. *Staff recommends approval.*
- 3) The Applicant is requesting a waiver from design guidelines Section B.5.c.(7)(c), *Secondary Streets*, which requires Secondary Streets to incorporate bicycle lanes and on-street parking spaces. The Applicant is seeking relief from the requirement for bicycle lanes along the project's Secondary Streets. Right-of-way size constraints are a factor, along with the function of these streets. These facilities function more like driveways than as streets. The Applicant is designing the Secondary Streets to be low speed to allow the shared use of the vehicle travel lane with bicycles. To achieve this shared use, the Secondary Streets will be constructed of paver bricks, pedestrian crosswalks constructed with contrasting paver brick designs and colors, providing street trees located less than 20 feet on center, and hardscape features like benches and shade structures all designed to slow vehicle speeds. The Applicant is also seeking relief from the requirement for on-street parking spaces along the east-west Secondary Street. Due to size constraints, the provision of on-street parking had a significant impact on the size and quantity of landscaping that could be located within the street. In lieu of providing on-street parking spaces along this roadway, the Applicant is providing additional landscaping and wider tree lawns. The Applicant is providing on-street parking along the north-south Secondary Streets. *Staff recommends approval.*

- 4) The Applicant is requesting a waiver from design guidelines Section B.5.c.(4), *Parking Regulations*, which requires projects within the Town Center District to adhere to the City's parking requirements in Section 78-345 of the City's Code. The Applicant's site design includes approximately 1,679 parking spaces distributed throughout the site in both traditional parking fields and on-street parking. The project is required to provide 1,723 parking spaces calculated using a parking ratio of one (1) space per 200 square feet of development that is the parking rate permitted for Mixed Use/Shopping Center in the City's Code. Staff supports the Applicant's waiver request. The Town Center Commercial Area project is part of the larger Town Center District within the Alton PCD. It is being designed as an urban project that promotes and encourages people to walk and bike to the project and is consistent with industry standards. The project includes a variety of synergistic uses that require parking at different times. As previously discussed in this Staff report, the Town Center District has been designed to provide vehicular and pedestrian connectivity throughout the Mixed Use District. This will facilitate and promote the residents residing in the two (2) residential projects to the south of the Town Center Commercial Area the ability to walk or ride a bicycle to utilize the many convenient uses within the Town Center Commercial Area. In addition, the future residential neighborhoods in Alton PCD Parcels D, E, and F will be interconnected via the Alton PCD's extensive sidewalk network through the neighborhoods and along the PCD's collector road system (i.e., Alton Road, Grandiflora Road, and Pasteur Boulevard). *Staff recommends approval.*

PLANNING, ZONING, AND APPEALS BOARD (PZAB)

On August 9, 2016, the PZAB recommended approval of the subject petitions to the City Council by a vote of 7 to 0.

STAFF RECOMMENDATION

Staff recommends APPROVAL of Resolution 65, 2016 as presented.

CITY OF PALM BEACH GARDENS **DEVELOPMENT APPLICATION**

Planning and Zoning Department
CITY OF PALM BEACH GARDENS
10500 North Military Trail
Palm Beach Gardens, FL 33410
(561) 799-4243 Fax (561) 799-4281

Request:

- | | |
|--|--|
| <input type="checkbox"/> Planned Community Development (PCD) | <input type="checkbox"/> Annexation |
| <input type="checkbox"/> Planned Unit Development (PUD) | <input type="checkbox"/> Rezoning |
| <input type="checkbox"/> Amendment to PCD, PUD or Site Plan | <input checked="" type="checkbox"/> Site Plan Review |
| <input type="checkbox"/> Conditional Use | <input type="checkbox"/> Concurrency Certificate |
| <input type="checkbox"/> Amendment to the Comprehensive Plan | <input type="checkbox"/> Time Extension |
| <input type="checkbox"/> Administrative Approval | <input type="checkbox"/> Miscellaneous |
| <input type="checkbox"/> Administrative Appeal | <input type="checkbox"/> Other _____ |

Date Submitted: **July 17, 2015**

Project Name: Alton Town Center

Owner: NADG/Brock (Alton PBG) LP

Applicant (if not Owner): NADG/Brock (Alton PBG) LP

Applicant's Address: 400 Clematis St., #210, West Palm Beach Telephone No. (561) 578-8700

Agent: Ken Tuma @ Urban Design Kilday Studios

Contact Person: Ken Tuma or Marty R.A. Minor E-Mail: ktuma@udkstudios.com

Agent's Mailing Address: 610 Clematis Street, Suite CU-02, West Palm Beach, FL 33401

Agent's Telephone Number: (561) 366-1100

FOR OFFICE USE ONLY

Petition Number: _____

Date & Time Received: _____

Fees Received

Application \$ _____

Engineering \$ _____

Receipt Number: _____

Architect: GliddenSpina and Partners

Engineer: Kimley-Horn and Associates

Planner: Urban Design Kilday Studios

Landscape Architect: Urban Design Kilday Studios

Site Information: **Note: Petitioner shall submit electronic digital files of approved projects. See attachment for details.**

General Location: Southeast corner of Donald Ross Road and Alton Road

Address: _____

Section: 26 Township: 41 South Range: 42 East

Property Control Number(s): 52424126010030030

Acreage: 40.8 Current Zoning: PCD (MXD) Requested Zoning: PCD (MXD)

Flood Zone B Base Flood Elevation (BFE) – to be indicated on site plan _____

Current Comprehensive Plan Land Use Designation: MXD

Existing Land Use: Vacant Requested Land Use: _____

Proposed Use(s) i.e. hotel, single family residence, etc.: Commercial Town Center

Proposed Square Footage by Use: 192,778 commercial center

Proposed Number and Type of Dwelling Unit(s) i.e. single family, multifamily, etc. (if applicable):
Not applicable

Justification

Information concerning all requests (attach additional sheets if needed.)
{Section 78-46, Application Procedures, Land Development Regulations.}

1. Explain the nature of the request: See Project Narrative

2. What will be the impact of the proposed change on the surrounding area?

See Project Narrative.

3. Describe how the rezoning request complies with the City's Vision Plan and the following elements of the City's Comprehensive Plan - Future Land Use, Transportation, Housing, Infrastructure, Coastal Management, Conservations, Recreation and Open space, Intergovernmental Coordination and Capital Improvement.

This request is for Site Plan Approval and not a rezoning. This question does not apply to this request.

4. How does the proposed project comply with City requirements for preservation of natural resources and native vegetation (Section 78-301, Land Development Regulations)?

Preservation requirements were addressed with the approval of the Alton PCD.

5. How will the proposed project comply with City requirements for Art in Public Places (Chapter 78-261, Land Development Regulations)?

The applicant will address the Art in Public Places requirement prior to the issuance of the first Certificate of Occupancy.

6. Has project received concurrency certification?

Concurrency certification was granted with the adoption of the Alton PCD development order.

Date Received: April 1, 2010

Legal Description of the Subject Property

(Attach additional sheets if needed)

Or see attached deed for legal description.

Location

The subject property is located approximately 0 mile(s) from the intersection of Donald Ross Road and Alton Road, on the north, east, south, west side of the intersection _____ (street/road).

Statement of Ownership and Designation of Authorized Agent

Before me, the undersigned authority, personally appeared William Johnson who, being by me first duly sworn, on oath deposed and says:

1. That NADG/Brock (Alton PBG) LP is the fee simple title owners of the property described in the attached Legal Description.
2. That he is requesting a Site Plan Approval within the Town Center District of the Alton Planned Community Development in the City of Palm Beach Gardens, Florida.
3. That he appointed Ken Tuma of Urban Design Kilday Studios to act as authorized agent on his/her behalf to accomplish the above project.

Name of Owner: NADG/Brock (Alton PBG) LP

Signature of Owner

(561)578-8700

Telephone Number

Jeff W. Preston, Manager

Name/Title

(561)598-6612

Fax Number

400 Clematis Street, Suite 201

Street Address

jwpreston@nadg.com

E-mail Address

West Palm Beach, FL 33401

City, State, Zip Code

Sworn and subscribed before me this 14th day of July 2015.

Elizabeth Nasuti
Notary Public

My Commission expires:

2/28/16



Applicant's Certification

I/We affirm and certify that I/we understand and will comply with the land development regulations of the City of Palm Beach Gardens, Florida. I We further certify that the statements or diagrams made on any paper or plans submitted here with are true to the best of my/our knowledge and belief. Further, I/we understand that this application, attachments, and application filing fees become a part of the official records of the City of Palm Beach Gardens, Florida, and are not returnable.

Applicant is:


Signature of Applicant

Owner

Ken Tuma

Print Name of Applicant

Optionee

610 Clematis Street, Suite CU-02

Street Address

Lessee

West Palm Beach, FL 33401

City, State, Zip Code

Agent

(561) 366-1100

Telephone Number

Contract Purchaser

(561) 366-1111

Fax Number

Ktuma@udkstudios.com

E-Mail Address



Palm Beach Gardens Planning and Zoning Department
10500 North Military Trail, Palm Beach Gardens, FL 33410
561-799-4243


Permit # _____

Financial Responsibility Form

The owner understands that all City-Incurred professional fees and expenses associated with the processing of this application request are ultimately the responsibility of the owner. A security deposit shall be deposited in an interest-bearing account with any accrued interest to be retained by the City of Palm Beach Gardens.

The owner and/or designee shall be invoiced on a monthly basis for professional fees such as, but not limited to, consultant engineering services, legal services, advertising costs, and/or any other costs attributable to the processing of the permit for which the City incurred during the previous month. The owner and/or designee shall reimburse the City within thirty (30) days from date of invoice. If payment is not received, the City may utilize the security deposit for re-imbursement purposes. All activities related to the pending permit(s) will cease until any outstanding invoices are paid.

The owner/designee further understands that transfer of this responsibility shall require a completed form, signed and notarized by the responsible party, and delivered to the City's Planning and Zoning Department if the name and/or address of the responsible party changes at anytime during the application review process.

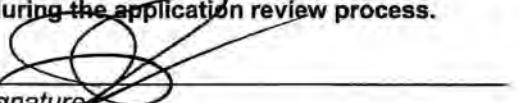
Owner signature

7/14/15


Date

Jeff W. Preston, Manager; NADG/Brock (Alton PBG) LP
Owner printed name

Property Control Number

DESIGNEE/BILL TO:

NADG/Brock (Alton PBG) LP

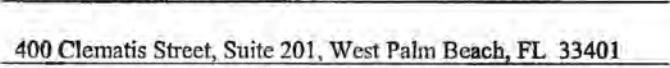
Designee Acceptance Signature


400 Clematis Street, Suite 201, West Palm Beach, FL 33401

NOTARY ACKNOWLEDGEMENT

STATE OF Florida

COUNTY OF Palm Beach

I hereby certify that the foregoing instrument was acknowledged before me this 14th day of July, 2015, by Jeff W. Preston. He or she is personally known to me or has produced _____ as identification.

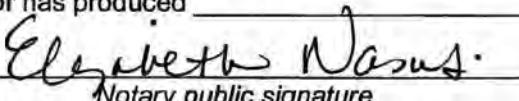
Elizabeth Nasuti
Notary public signature

Elizabeth Nasuti
Printed name

State of Florida at-large

My Commission expires: 2/28/16



ALTON TOWN CENTER

Site Plan Application

Project Narrative

September 15, 2016



Requests

On behalf of the Applicant, NADG/Brock (Alton PBG) LP, please accept this request for a Site Plan Approval for the Alton Town Center commercial district on 40.8 acres within the Town Center District of the Alton Planned Community Development (PCD). The Alton PCD is approximately 681 acres in size and is located south of Donald Ross Road, north of Hood Road and east and west of Interstate 95. The subject site is located within the northern portion of the Town Center District at the southeast corner of the intersection between Donald Ross Road and Alton Road and is currently vacant.

The attached site plan depicts the 40.8-acre Town Center development, which will consist of 360,203 square feet of commercial space. Within this space, the applicant is proposing a grocery, fitness center, restaurants with and without drive-throughs, a financial institution with a drive-through, a gas station with car wash and general retail uses. With this request, the applicant is seeking 13,800 square feet of outdoor seating area with service. This 13,800 square feet has been included within the project's traffic equivalency statement. In addition to the site plan approval request, we are seeking a Major Conditional use for a restaurant with a drive-through and a Minor Conditional Use for a Convenience Store with gas sales. Also, this request includes a Metes and Bounds Subdivision application.

Consistent with the approved PCD Master Plan and Design Guidelines, the proposed site plan includes the required "Premier" and "Primary" Streets, which will intersect at the southern portion of the site. On-street parking is provided along these streets. At this intersection, the applicant is proposing a one acre "Central Square," which is more than twice the size of the Design Guidelines requirement. The location of the Central Square is adjacent to the entry to the Atlantico at Palm Beach Gardens apartment community, which recently received site plan approval. With enhanced sidewalks on both sides of each street and the large plaza, the proposed Alton Town Center will have more area devoted to pedestrian space than any other commercial development within the City.

In addition to the Premier and Primary streets, Secondary streets have been added to create a grid-like network of streets within the center. Consistent with the Design Guidelines requirements, commercial buildings have been located along the Premier and Primary Street frontages with parking located behind the buildings. In the areas where a building is not provided along these streets, landscaped open spaces with pedestrian amenities have been provided. The buildings will be one-story in height with some two-story features. Sidewalks have been provided throughout the site along the Premier, Primary and Secondary streets.

However, there are some features of the provided site plan which deviate from the Design Guidelines. The deviations largely concern the treatment of the Primary Street, the design of the Secondary Streets and architectural treatments. However, the commercial district has been and will continue to be designed to balance the needs and safety of pedestrians and motorists visiting the site. In fact, pedestrian activity will be created along the Donald Ross Road frontage for the first time.

Urban Planning and Design
Landscape Architecture
Communication Graphics

610 Clematis Street
Suite CU02
West Palm Beach, FL 33401
561.366.1100 561.366.1111 fax
www.udkstudios.com
LCC000035

Location

The 40-acre site is located within the northern portion of the 133-acre Town Center District of the Alton PCD. The site is located immediately north of the proposed 13-acre Atlantico at Palm Beach Gardens apartment community and an 18-acre lake, which will provide drainage retention for the Town Center District including the subject site.

Land Use & Zoning

As the subject site is approximately 30% of the overall Town Center District area, the Future Land Use Designation of MXD (Mixed Use) and zoning of Mixed Use with a Planned Community Development Overlay (MXD/PCD) applies to the subject site and all surrounding properties.

As stated above, the subject site is located within the Parcel C – Town Center District. The site is bounded by the future FPL substation and upland preserve to the east, the future Atlantico neighborhood to the south and Parcel A – Scripps Campus District and Alton Road to the west. To the north of the proposed Alton Town Center is Donald Ross Road and the Abacoa DRI in the Town of Jupiter. For context, the zoning and land use designations of properties adjacent to the Alton PCD are as follows:

ZONING CLASSIFICATION & LAND USE DESIGNATIONS OF ADJACENT PROPERTIES

EXISTING USE	ZONING	LAND USE
<u>Subject Property</u> Alton Town Center within the Town Center District of Alton PCD	Mixed Use (MXD) Planned Community Development (PCD)	Mixed Use (MXD)
<u>North</u> Donald Ross Road Abacoa DRI (Town of Jupiter)	Mixed Use (MXD)	Mixed Use (MXD)
North Palm Beach Heights (Town of Jupiter)	Residential -1 (R-1) & Residential-2 (R-2)	Residential High (RH)
<u>South</u> Hood Road Westwood Gardens/ Westwood Lakes	Planned Unit Development (PUD) Residential Medium (RM)	Residential Low (RL)
Jewish Community Center PUD	Planned Unit Development (PUD)	Mixed Use (MXD)
Robert Frances	Planned Development Area (PDA)	Mixed Use (MXD)
Danny Baily		
<u>East</u> San Michele neighborhood	Planned Unit Development (PUD)	Residential Low (RL)
Legends at the Gardens	Planned Unit Development (PUD)/ Mixed Use (MXD)	Mixed Use (MXD)
Benjamin School	Planned Unit Development (PUD)/ Public /Institutional (P/I)	Residential Low (RL)
<u>West</u> Eastpointe neighborhood	RE (Residential Estate)	LR-2 (Low Residential-2)

(Palm Beach County)		
Franklin Academy	(MXD/PUD)	Mixed Use (MXD)

Access

Access to the site will be from Donald Ross Road and the future Alton Road. Along the six-lane divided Donald Ross Road, one full access entry at the northern terminus of the Premier Street. Two right-in, right-out entrances are proposed to the east and west of the main entrance along Donald Ross Road. Along the future Alton Road, entrance to the subject site is provided by the Primary Road and a right-in, right-out entrance. Numerous pedestrian connections will be provided from the extensive internal sidewalk network within the center to the adjacent pedestrian pathways along the 55-foot wide Donald Ross Road Parkway buffer and 30-foot wide Alton Road buffer.

Site Analysis

SITE ANALYSIS: Alton Town Center			
	Alton PCD Design Guidelines and City's LDRs	Proposed Site Plan	Consistent
<i>Development Area</i>	5 acre	40.80 acres	Yes
<i>Open Space</i>	Minimum 15%	21.1%	Yes
<i>Lot Coverage</i>	Maximum 70%	19.4%	Yes
<i>Setbacks</i>			
Front	55 feet from Donald Ross Road	55 feet from Donald Ross Road	Yes
Side	10 feet from site plan property line	11 feet from side property line	Yes
Side Street	30 feet along Alton Road	40 feet along Alton Road	Yes
Rear	15 feet	125 feet	Yes
<i>Building Height</i>	4 floors or 50 feet	1 floor/37 feet	Yes
Parking	1 space per 200 s.f. (1 space per 1,000 s.f. for garden center) + 13,800 of outdoor seating with service/patio area = 1,723 spaces required	1,691 spaces	Yes, for interior building area. Parking waiver request for a portion (44 spaces) of outdoor seating parking requirement.
Parking Space Size	9' x 18.5' with 26' drive aisle	9.5' x 18.5' with 25' drive aisle and 10' x 18.5' angled parking with 18' drive aisle	Yes
Landscaping	54,453 Points Required	84,423 Points Provided	Yes

Site Plan Features

The Applicant is requesting site plan approval for a pedestrian-focused, upscale Town Center for the Alton community. The proposed site plan for the Alton Town Center will contain 16 proposed commercial

buildings located on a grid of pedestrian-oriented streets. The proposed uses include retail, personal services, grocery, fitness center, specialty restaurants with and without drive-through, quality restaurants, financial institutions, and a home improvements store. The home improvement store is proposing a limited amount of outdoor sales during store hours. An exhibit showing the locations, limits of display area and materials to be sold is attached for your review. In addition, the updated traffic impact analysis indicates traffic concurrency for 13,800 square feet of outdoor seating area. This area has been identified as patio area on the submitted site plan.

Architecture

Alton Town Center is designed as contemporary styled project. To make contemporary designs work, they need to be based in straight forward design themes. The theming of this contemporary project is a study in contrast, which can best be termed as creating an "edgy" design sensibility.

The arrangement of the massing is asymmetrical as a rule. Also the use of linear design elements set against more massive straight forward right angular architecture creates visual tension, which helps creates architectural energy. This contributes to the contemporary atmosphere.

Architectural elements, such as tower elements with large horizontal roof overhangs, thin sleek horizontal metal awnings, feed this energy further. Special attention is paid to utilizing differing materials with textures.

The materials used are clean smooth white stucco for basic massing; colors are tonal and set in contrast against the varied textured materials. These are wood looking porcelain tile, brushed aluminum, Corten steel, glass store fronts and a clean off white stone. Contrast is derived from the interplay of materials and textures set against the bright tonal nature of the project. It is this contrast which brings the project to life, giving it a lively crisp and clean design dynamic.

There are several courtyards and a pedestrian park which leads to a main plaza. This area is dynamic people place with fountains, sculptures, art, benches, which incorporates the materials used in the buildings to reiterate the contemporary energy of the project.

The project will be an architecturally interesting and enjoyable people oriented place to shop and enjoy.

Landscaping

Donald Ross Road Buffer

The landscape design concept is to create a multi-modal 12' path that meanders along this parkway at the same grade as the cross walks, and finish floor elevations of the buildings fronting the parkway.

This universal design is proposed to encourage the 55' parkway to be utilized as both an active recreational amenity, and as passive park uses. With the elevations of the walks and buildings all at the same level persons of all activity levels can utilize these paths, without the challenges of slopes and elevation changes. This will allow and encourage pedestrian activity along the parkway.

The landscape design concept for this area is to create "Native Clusters" of native trees and palms and understory planting. Live Oaks, Slash Pine, Sabal Palms, Dahoosie Holly trees, Wax Myrtle, and a variety of native shrubs and grasses replicate the natural habitat and ecosystem of a Mesic Oak and Pine Flatwood plant communities. These Trees and Palms are up lit with LED lighting to create dramatic night time effects.

Landscape Design Concept Hierarchy

The Medjool Palm is utilized in the landscape design as creating focal points, and as way finding elements. These specimen palms are proposed at the vehicular entry points, off of Donald Ross Road and Alton Road. They are also proposed at the major streetscape intersections along the Premier, Primary and Secondary Streets internal to the Town Center. The Medjool Date Palms will provide a larger shade pattern than other types of palms. These major intersections have specialty paving hardscapes. Minor intersections have large Royal Palms proposed at the corners.

The Premier Street features a diverse collection of specimen palms, including Medjool Date Palms, Christmas Palms, Wild Date Palms, Royal Palms and triple Montgomery Palms. The Primary Street will be lined with large Live Oaks. The Secondary Streets will feature triple Montgomery Palms and Japanese Blueberry trees. These palms are proposed to be planted in between the road and the pathways. These landscape areas along the streets have podocarpus hedges proposed to buffer the pedestrian from vehicular traffic. Gumbo Limbo Trees, Green Buttonwood Trees, and Tree Ligustrum Trees are proposed for the parking area landscape islands. The Primary Street in between the Town Center and Atlantico Multi-Family consists of a Live Oak Tree lined street. The thematic Medjool Palm is proposed at the entry point off Alton Road.

Please note that the east-west Secondary Street will be lined with Japanese Blueberry trees, which are consistent with the overall Alton landscape theme.

Alton Road Landscape Buffer Concept

This landscape buffer consists of the formal design of equally spaced specimen Medjool Palms, Live Oak trees, and Bizmark Palms. These Trees and Palms are up lit with LED lighting to create dramatic night time effects, consistent with the Alton Road landscaping treatment.

Signage

The Applicant is preparing a Master Signage Program for Alton Town Center. This Master Signage Program, which will be provided under a separate cover, will govern all signage within the project.

Pedestrian-Orientation

Consistent with the adopted Design Guidelines for the projects, the proposed Alton Town Center provides for a grid of Premier, Primary and Secondary Streets. With enhanced sidewalks on both sides of each street and the large Central Plaza, the proposed Alton Town Center will have more area devoted to pedestrian space than any other commercial development within the City. More than 3 miles of sidewalks are provided within the project. Please note that signature shade structures have been provided along the Premier, Primary and Secondary Streets.

Premier Street

The Premier Street, as indicated on the PCD Master Plan and consistent with the Design Guidelines, connects Donald Ross Road to Alton Road. The street connects the commercial, multi-family and single family neighborhoods of the Town Center District. Within the subject site plan, the Premier Street extends approximately 970 linear feet from the Donald Ross Road right-of-way line south to the northern property line of the future Atlantico multi-family neighborhood.

The Premier Street features two 11-foot wide travel lanes, in addition to 2-foot wide valley gutters and 7-foot wide parallel parking spaces. On each side of the Premier Street, a 15-foot wide pedestrian area is provided. This pedestrian area feature a minimum 8-foot wide "clear path" for multiple pedestrian to pass each other simultaneously. The pedestrian area also features pavers, shade-providing landscaping,

benches, decorative street lights and other street furniture. Pavers are provided at the intersections along the Premier Street and with the cross walks.

Along the streetscape will be a variety of large palms, which meet and exceed the Design Guideline standards for taller trees and palms. Medjool Date Palms, Wild Date Palms, triple Montgomery and Christmas palms will line various portions of the Premier Street.

At the southern end of the Premier Street within the Alton Town Center will be a one acre Central Square, which is more than twice the size of what is required by the Design Guidelines. The plaza will feature pavers/stamped concrete, seating areas, artwork and landscaping.

South of the plaza is the intersection of the Premier and Primary streets. This intersection will be a roundabout, which reduces traffic speeds in this pedestrian-oriented area. South of the roundabout is the northern vehicular entrance to the proposed Atlantico at Palm Beach Gardens multi-family community.

Primary Street

Consistent with the approved PCD Master Plan, the Primary Street connects the Alton Road to the approximate midpoint of the Premier Street. The Primary Street also divides the Alton Town Center from the Atlantico neighborhood and the central lake feature within Parcel C. The Primary Street will feature two, 11-foot wide vehicle travel lanes as well as two designated bicycle lanes. In addition, an 8-foot wide sidewalks are provided on both sides of the street. These sidewalks connect to the 8-foot sidewalks along the central Town Center lake and along Alton Road.

On the northern side of the Primary Roadway, the applicant is proposing a heavily landscaped meandering sidewalk. This meandering sidewalk, with pavers, will wind its way through enhanced and shade-producing landscaping and artwork locations. The Applicant will be seeking a waiver from the Design Guideline standard with regards to commercial buildings fronting on the Primary Street. As the proposed Town Center district will be providing numerous services geared toward the local Alton residents, these services require loading and service areas. The service area for the proposed grocery and fitness center buildings have been separated from the Primary Street by a 12-foot high wall, 22 to 39 feet of lush landscaping and the proposed artwork. This shaded walk along the Primary Street also leads to the central plaza.

Secondary Streets

The Secondary Streets within the proposed Town Center site plan run east to west and north to south. The secondary streets all feature 11-foot wide drive lanes as long as 5-foot wide sidewalks on both sides of the street. All of the proposed north-south Secondary Streets feature on-street parking. The east-west Secondary Street does not feature on-street parking as it was desired, from a design standpoint, to provide additional street trees, 14' Japanese blueberry trees, along this corridor. A waiver is being sought to not provide bicycle lanes.

Lighting

Decorative streetlights, consistent with the streetlights used throughout the Town Center district, will be provided along Premier, Primary and Secondary Streets. In addition, these decorative lights will be used within the Central Square plaza and the pedestrian pavilion along the Premier Street. Within the parking area, a 25-foot high light fixture is proposed, consistent with City Code standards. In addition, accent and up-lighting will be provided within the Central Square plaza area, the water wall feature, the pedestrian

pavilion along the Premier Street, shade structures, public artwork and fountains, and architectural features on the proposed buildings.

ANALYSIS OF CONFORMANCE WITH ALTON DESIGN GUIDELINES

Below is an analysis of the proposed Alton Town Center site plan and its compliance with the PCD's Design Guidelines. The analysis will determine what waivers will be needed to achieve the requested site plan.

Premier Street Frontage

	Design Guidelines Requirement	Proposed Site Plan	Waiver?
ROW or Easement Width	40 feet	40 feet	No
Build-To Lines	70 feet – up to 84 feet with 10% permitted variation	75 feet where buildings are located (not including buildings at wider entry feature)	No
Block Length	250 feet minimum 500 feet maximum	450 feet maximum on Premier Street	No
Block Perimeter	1800 linear feet	Maximum of 1800 linear feet	No
% of Buildings at Build-to line	90%	100%	No
Maximum Lot Coverage	50%	19%	No
On-Street Parking	Required	Provided	No
Parallel On-Street Parking	Required	Provided	No
Parking Space Size	On Street – 7' x 23' with 2' F curb Regular Space – 9' x 18.5'	On Street – 7' x 23' with 2' F curb Regular Space – 9' x 18.5'	No
Parking Lot along Street Frontage	Prohibited	Not Provided within 50 feet of street frontage	No
Pedestrian Area	15 feet on each side of street	15 feet	No
Sidewalk Clear Area	8 feet	8 feet	No
Pedestrian Covering, i.e. awnings, balconies, arcades, etc.	60%	54 to 65%	Yes
Central Plaza provided	20,000 square foot plaza to be provided adjacent to Premier Street	43,017 s.f. provided at northwest and northeast corners of intersection of Premier and Primary Roads	No
Pedestrian Crossings	Decorative surface/pavers for crosswalks,	Streets, intersection, crosswalks, sidewalks and central plaza to	No

	intersections, public spaces	have decorative pavers and/or stamped concrete.	
Tenant frontage size	Tenants less than 25,000 square feet in size may not occupy more than 120 feet of Premier Street frontage. Tenants greater than 25,000 square feet shall not occupy more than 300 feet of Premier Street frontage.	In Compliance with tenant standard for Premier Street.	No
Bicycle Lanes	No	No	No
Elevation features windows, doorways, and openings	60% of the length of the elevation	45 - 60% provided	Yes
Pedestrian Benches	Bench every 300 feet	A minimum on one bench per 300 feet	No
Street Light Poles	Decorative Lights required	Decorative street lights (Chateau fixture) provided	No
Landscaping	Street trees located every 30 feet of frontage. Minimum heights 18 feet – trees 22 feet – palms	Palms 18 to 26 feet in height	No

Primary Street frontage

The Primary Street is located at the southern boundary of the site west of the Premier Street and the following requirements apply:

	Design Guidelines Requirement	Proposed Site Plan	Waiver?
ROW or Easement Width	50 feet	50 feet	No
Build-To Lines	80 feet – up to 84 feet with 10% permitted variation	130 feet *Where buildings are provided	Yes
Block Length	250 feet minimum 500 feet maximum	425 feet & 440 feet	No
Block Perimeter	1800 linear feet	Maximum of 1800 linear feet	No
% of Buildings at Build-to line	90%	0%	Yes
Maximum Lot Coverage	50%	19%	No

Parallel On-Street Parking	Required	Provided	No
Parking Lot along Street Frontage	Prohibited	Not Provided	No
Pedestrian Area	15 feet on each side of street	15-22 feet	No
Sidewalk Clear Area	8 feet	8 feet	No
Pedestrian Covering, i.e. awnings, balconies, arcades, etc.	25%	0%	Yes
Pedestrian Crossings	Decorative surface/pavers for crosswalks, intersections, public spaces	Crosswalks to have decorative pavers	No
Bicycle Lanes	Required	Provided	No
Elevation features windows, doorways, and openings	25% of the length of the elevation	0%	Yes
Street Light Poles	Decorative Lights required	Decorative Lights (Chateau fixture) provided	No
Landscaping	Street trees located every 30 feet of frontage. Minimum heights 16 feet – trees 18 feet – palms	16-foot high Live Oaks provided	No

Secondary Streets

	Design Guidelines Requirement	Proposed Site Plan	Waiver?
ROW or Easement Width	26 to 50 feet	26 to 50 feet	No
Build-To Lines	72 to 83 feet – up to 100 feet with 10% permitted variation	72-75 feet where buildings are located	No
Block Length	250 feet minimum 500 feet maximum	Maximum of 450 feet	No
Block Perimeter	1800 linear feet	1,800 linear feet	No
% of Buildings at Build-to line	65%	100% of affected buildings	No
Maximum Lot Coverage	50%	19%	No
On-Street Parking	Optional	Provided	No
Pedestrian Area	11 feet on each side of street	12 feet minimum	No
Sidewalk Clear Area	5 feet	5 feet	No

Bicycle Lanes	Provided	Not Provided	Yes
Pedestrian Benches	Shaded sitting area every 330 feet of parking lot frontage	Trellis and benches provided at midblock crossing locations.	Yes
Street Light Poles	Decorative Lights required	Decorative Light (Chateau fixture) provided	No
Landscaping	Street trees located every 30 feet of frontage. Minimum heights 14 feet – trees and palms 5-feet of landscaping between secondary road pedestrian area and parking lot	22 feet of clear trunk and 26 feet for overall height of Montgomery Palms provided.	No

Waiver Summary Table

	Design Guideline Section	Requirement	Proposal	Waiver?
1	Section B.5.c.(7)(b): Primary Street Setbacks	Building located within 10 feet of street build-to-line	None	No buildings front on Primary Street
2	Section B.5.c.(7)(b): Primary Street Setbacks	80% of building elevation located within the 10 feet of streets build-to-line	None	No buildings front on Primary Street
3	Section B.5.c.(7)(c): Secondary Street -	Provide five (5) foot bicycle lane and on-street parking	Removal of bicycle lane and on-street parking on north-south Secondary Streets only	No bicycle lane and no on-street parking on the east-west Secondary Street
4	Section B.5.c.(4): Parking Regulations	Total parking spaces required = 1,723	Total parking spaces proposed = 1,679	44 parking spaces

As indicated above, four waiver requests are associated with this Site Plan Approval application. The first two waivers address the project's Primary Street. As identified on the adopted PCD Master Plan, the Primary Street connects Alton Road with the Premier Street within the Town Center. Because of the desire to bring uses to the Town Center district that will serve the residents of Alton, such as a grocery, home improvement store and a fitness center. These desired uses, especially the grocery, require a "back of store" section where deliveries can be made. From a health and safety standpoint, these delivery and

loading areas need to be separated from pedestrian and vehicular traffic. In order to buffer these delivery and loading areas, the applicant is proposing to create a heavily landscaped meandering pathway along the northern boundary of the Primary Street. On the north side of the Primary Street, a meandering sidewalk with benches, lush landscaping and artwork is proposed. The walkway will be separated from the rear of the commercial buildings by a 12-foot high wall, 22 to 39 feet of lush landscaping and the proposed artwork. This shaded area along the Primary Street also leads to the district's 26,000-square foot central plaza.

The third waiver request is related to the provision of designated bicycle lane and on-street parking on Secondary Streets within the project. The Applicant is requesting a waiver from this requirement as the Secondary Streets will be used as a shared facility for both bicyclists and motorists, similar to the use of local City streets as shared facilities for bicyclists and motorists. Along each of the north/south secondary streets, trellis features have been added at the mid-block crossings. The four new trellis features enhances the pedestrian experience along these streets.

In addition, the Applicant is seeking to waive the on-street parking requirement for the east-west Secondary Street in order to provide additional street trees and hardscape areas to accent the sidewalks on both sides of the street. Additional Japanese Blueberry trees have been added to the east/west secondary streetscape along with four new benches and a color palette of grasses and vegetation for a pleasant pedestrian experience. The two north-south Secondary streets will provide on-street parking.

The fourth waiver request seeks to waive a portion of the parking requirement for patio/outdoor seating within the center. With the proposed site plan, 13,800 square feet of patio/outdoor seating areas which will feature dining with service. Like the parking requirement for interior retail space, the patio/outdoor seating areas has a parking ratio of 1 space per 200 square feet, which would result 69 parking spaces. The site has 25 extra spaces above the parking requirements for the interior shopping center spaces and the home improvement garden center. We are seeking a waiver of 44 parking spaces – or about 2% of the total parking provided – for the patio area parking requirements for several reasons. The patio/outdoor seating areas are dependent upon the weather for its use. Rain, heat, humidity, wind and cold limit the availability and the function of the patio/outdoor seating area. In addition, consistent with the principles of mixed use communities, 353 apartments and the estimated 812 residents are within a five-minute walk to all of Alton Town Center. Hundreds of other Town Center District residents will have less than a 10 minute walk or a short bicycle ride to the project. Having a grocery, fitness center and quality restaurants and coffee shops within walking distance is amenity to the Town Center residents and an amenity they will use. Part of the justification for this requested waiver is that Town Center District residents will walk and not use their cars when visiting the site.

Waiver Criteria Compliance

Consistent with the requirements of Section 78-158 of the City's LDRs, the waiver request shall comply with a majority of the criteria listed within the code. The City's waiver criteria are listed below in **bold** and the responses follow in *italics*.

(1) The request is consistent with the city's comprehensive plan.

With this request, the applicant is requesting to deviate from standards set by the Alton Design Guidelines to create an urban, pedestrian-focused commercial town center for the Alton community. The proposal to create this pedestrian-oriented is consistent with the requirements of Policies 1.1.1.15. and 1.3.6.3. of the Future Land Use Element of the City's Comprehensive Plan. These policies require a pedestrian-oriented

environment within a BioScience MXD, which Alton is one, and for the City to encourage walking within the City. As stated above, the proposed Alton Town Center provides for more pedestrian facilities than any other commercial area within the City. As such, the request is consistent with the City's Comprehensive Plan.

(2) The request is consistent with the purpose and intent of this section.

The purpose and intent of this Section 78-158 is to promote creative and innovative design through the planned development process. With the waiver requests, the applicant is able to provide a contemporary commercial district for the Alton community. Please note that the applicant is providing more than 55% additional landscaping points than what is required for this application. As such, the waiver requests are consistent with the purpose and intent of Section 78-158.

(3) The request is in support of and furthers the city's goals, objectives, and policies to establish development possessing architectural significance, pedestrian amenities and linkages, employment opportunities, reductions in vehicle trips, and a sense of place.

With the requested waiver for the variation to the Design Guideline standards, the applicant will be creating an environment that is as easy to access for pedestrian as well as motorists. The proposed site plan has 18 separate sidewalk connections to the 8-foot wide sidewalk along Alton Road and 12-foot wide sidewalk within the Donald Ross Road parkway. The proposed Alton Town Center features unique and contemporary buildings which possess architectural interest and significance. The requested waivers will allow the creation of a high quality aesthetic environment within the Alton Town Center District consistent with City standards. Along the street frontages, pedestrian covering and areas of interest are provided. These sidewalk amenities will be used as hundreds of Town Center District residents will be within a five minute walk to the grocery, fitness center and coffee shop – an amenity that will attract active residents.

(4) The request demonstrates that granting of the waiver will result in a development that exceeds one or more of the minimum requirements for PUDs.

As indicated above, the Alton Town Center site Plan application PUD exceeds several of the minimum standards including the provision of open space and landscaping points. The site is proposing 21.1% open space while 15% is required. In addition, the proposed landscaping within the project exceeds the City's landscaping standards.

(5) The request for one or more waivers results from innovative design in which other minimum standards are exceeded.

The proposed Alton Town Center employs various innovative techniques in its design, such as building layouts, creation of large plazas, contemporary architectural style and enhanced pedestrian facilities. The request for the referenced waivers from the Design Guideline standards is consistent with these efforts. For example, the Central Square plaza will be the transition and gathering space connecting the residential and non-residential portions of the Town Center District. This plaza is more than twice the size that what is required by the Alton Design Guidelines. This plaza will feature outdoor seating, large palms and a water wall.

(6) The request demonstrates that granting of the waiver will result in preservation of valuable natural resources, including environmentally-sensitive lands, drainage and recharge areas, and coastal areas.

The proposed waivers and site plan will not impact the existing upland preserve areas or the drainage for the site. As such, this criterion has been met.

- (7) The request clearly demonstrates public benefits to be derived, including but not limited to such benefits as no-cost dedication of rights-of-way, extensions of pedestrian linkages outside of the project boundaries, preservation of important natural resources, and use of desirable architectural, building, and site design techniques.**

As required by the City's Comprehensive Plan, Zoning Code and the Alton Design Guidelines, the Alton Town Center features a pedestrian-oriented environment which provide linkages to the adjacent arterial roadways of Donald Ross Road and Alton Road as well as internal linkages to the future Atlantico and Neighborhood #1 communities. A contemporary architecture is being proposed consistent with the architecture approved for Neighborhood #1 and Atlantico.

- (8) Sufficient screening and buffering, if required, are provided to screen adjacent uses from adverse impacts caused by a waiver.**

The requested waivers will only affect the internal layout of the Alton Town Center. The Town Center will be screened by the approved landscape buffers along Donald Ross Road and Alton Road. Within the project, the project will provide more than 55% more landscape points than what is required. As such, the request meets the referenced criterion.

- (9) The request is not based solely or predominantly on economic reasons.**

The requested waivers allow for the functionality of a modern commercial district within a modified grid pattern for streets within the project. The additional landscaping, open space, plaza area and pedestrian facilities were not provided for economic reasons.

- (10)The request will be compatible with existing and potential land uses adjacent to the development site.**

The requested Alton Town Center site plan, street layout and sidewalk widths and locations are compatible to the Alton PCD Master Plan, the Design Guidelines, the approved Alton PCD construction plans and proposed plans for adjacent neighborhoods. As such, the request meets this criterion.

- (11)The request demonstrates the development will be in harmony with the general purpose and intent of this section, and that such waiver or waivers will not be injurious to the area involved or otherwise detrimental to the public health, safety, and welfare.**

As previously stated, the requested waivers allow for the functionality of a modern commercial district within a modified grid pattern for streets within the project. The proposed waivers will not be injurious to the area or detrimental to the public health, safety and welfare. The applicant believes the pedestrian orientation of the site plan will encourage more walking by the community's residents, aiding to their health and safety.

Major and Minor Conditional Uses

The request for a Specialty Restaurant with a drive-through facility is a major conditional use and for a Convenience Store with gas sales as a minor conditional use under the Alton PCD. Section 78-52 of the City's Land Development Regulations. For the consideration of approval of these major and minor conditional uses, the code provides for 13 criteria points for the evaluation of the request. For your convenience, I have replicated the criteria in **bold** below with our responses in *italics*.

Conditional Use Criteria:

(1) Comprehensive Plan. The proposed use is consistent with the comprehensive plan.

The proposed application is a request to provide the commercial Town Center component to the Alton PCD's Town Center mixed use district. As stated above, the Alton PCD has a Mixed Use future land use designation. The proposed uses are consistent with the Mixed Use land use designation and have been included with several existing mixed use projects within the City.

(2) Chapter requirements. The proposed use is consistent with all applicable requirements of this chapter.

The proposed application is a request to create the Town Center for the Alton PCD, which is a mixed use development which will bring new quality employment opportunities to the City. The building elevations and signage will be consistent with the architectural style and theming of the project. This request is consistent with the applicable requirements of City's Land Development Regulations.

(3) Standards. The proposed use is consistent with the standards for such use as provided in Section 78-159.

The specific City standards for a restaurant with a drive through lane and a convenience store with gas sales have been met.

(4) Public welfare. The proposed use provides for the public health, safety, and welfare by:

(a) Providing for a safe and effective means of pedestrian access.

Internal pedestrian access is currently provided through a series of sidewalks. Additional sidewalks will be provided from all new buildings to the public sidewalk network.

(b) Providing for a safe and effective means of vehicular ingress and egress.

The site currently has access from two major roadways, Donald Ross Road and Alton Road. Site design has taken into account required turning movements for public safety vehicles.

(c) Providing for an adequate roadway system adjacent to and in front of the site.

The site is bound by Alton Road on the west and Donald Ross Road on the north. These major roadways provide an adequate roadway system adjacent the site. All access points to the project from these adjacent roadways meet all applicable standards.

(d) Providing for a safe and efficient onsite traffic circulation, parking, and overall control.

The proposed site plan provides for a grid network of streets to provide circulation through the site. The proposed location of the conditional uses minimizes the impacts to the overall project.

(e) Providing adequate access for public safety purposes, including fire and police protection.

Access and circulation has been designed to allow for ease of circulation and access for emergency vehicles from Donald Ross Road and Alton Road. The proposed designs of the parking and vehicular areas

allows for convenient and effective movement for the public safety and for fire and police protection in a logical manner.

(5) Screen and buffering. The proposed use utilizes such techniques as landscaping, screening, buffering, site or building design, or business operation procedures to mitigate impacts on surrounding properties, including such impacts as:

(a) **Noise** – *The proposed uses is part of the proposed Town Center and is specifically located directly adjacent to Donald Ross Road. Within the proposed site plan, these uses are the farthest from existing and future residential development. The proposed use will not create any adverse noise. The proposed use will comply with the City's noise standards and regulations.*

(b) **Glare** – *The proposed lighting will be consistent with the existing lighting on the property and will be designed to minimize glare to the adjacent roadways and properties. The proposed lighting will meet all applicable City lighting standards.*

(c) **Odor** – *There will be no odor produced as a result of the proposed uses on this site. Trash and debris from the use will be regularly removed from the site by the waste disposal provider. The property manager has a comprehensive dumpster maintenance program to ensure no odor problems arise.*

(d) **Ground, wall, or roof mounted mechanical equipment** –*All ground wall or roof mounted mechanical equipment is proposed to be screened via a parapet wall or landscaping.*

(e) **Perimeter, interior, and security lighting** – *All security lighting will be in compliance with the City's LDRs and Florida State Statues.*

(f) **Signs** – *The applicant is proposing a signage program for the project. Signage for these uses will be consistent with the Alton Town Center signage program.*

(g) **Waste disposal and recycling** – *The site has an existing program in place for waste disposal on this site.*

(h) **Outdoor storage of merchandise and vehicles** – *There will be no outdoor storage of merchandise or vehicles on this site.*

(i) **Visual impact** – *The applicant is proposing to improve the current plaza to enhance the visual appearance of the site. The architectural design of the buildings are consistent with the existing architecture and has incorporated many of the design elements of the existing buildings.*

(j) **Hours of operation** – *The use will comply with the LDR regulations for hours of operation.*

(6) Utilities. The proposed use minimizes or eliminates the impact of utility installation, including underground and overhead utilities, on adjacent properties.

The proposed building construction for Alton Town Center, including the requested uses, will result in the placement of new underground utilities to serve the project. None of the proposed improvements will impact adjacent properties.

(7) Dimensional standards. The proposed use meets or exceeds all dimensional requirement required by the chapter.

The proposed uses meet and exceed all dimensional requirements, such as setbacks, stacking lengths, and parking stall sizes.

(8) Neighborhood Plans. The proposed use is consistent with the goals, objectives, policies, and standards of neighborhood plans.

There is no Neighborhood plan for this area.

(9) Compatibility. The overall compatibility of the proposed development with adjacent and area uses, and character or area development.

The existing commercial development is bordered by two major roadways and other nonresidential development. The proposed uses are consistent with the existing character of the area.

(10) Patterns of development. The proposed use will result in logical, timely, and orderly development patterns.

The development of this site is consistent with the comprehensive plan, the surrounding zoning and the Land Development Regulations. The proposed Conditional Uses will provide for a logical, timely and orderly pattern of development.

(11) Purpose and intent. The proposed use will be in harmony with the general purpose and intent of this chapter and the goals, objectives, and policies of the City.

The proposed uses are consistent with the general purpose and intent of the code as well as the goals, objectives and policies of the City for commercial development.


(12) Adverse impact. The design of the proposed use and structures will minimize any adverse visual impacts or impacts caused by the intensity of the use.

The improvements to the site have been designed in consideration of the surrounding properties and to improve the visual esthetics of the site while minimizing abutting property impacts.

(13) Environmental impact. The design of the proposed use minimizes any adverse impacts that may be created, including impact on environmental and natural resources including air, water, storm water management, wildlife, vegetation, and wetlands.

As part of an overall PCD, the Environmental impact for this site was addressed with the PCD approval in 2010. As such, there are no existing environmental areas on the site.

Location Map

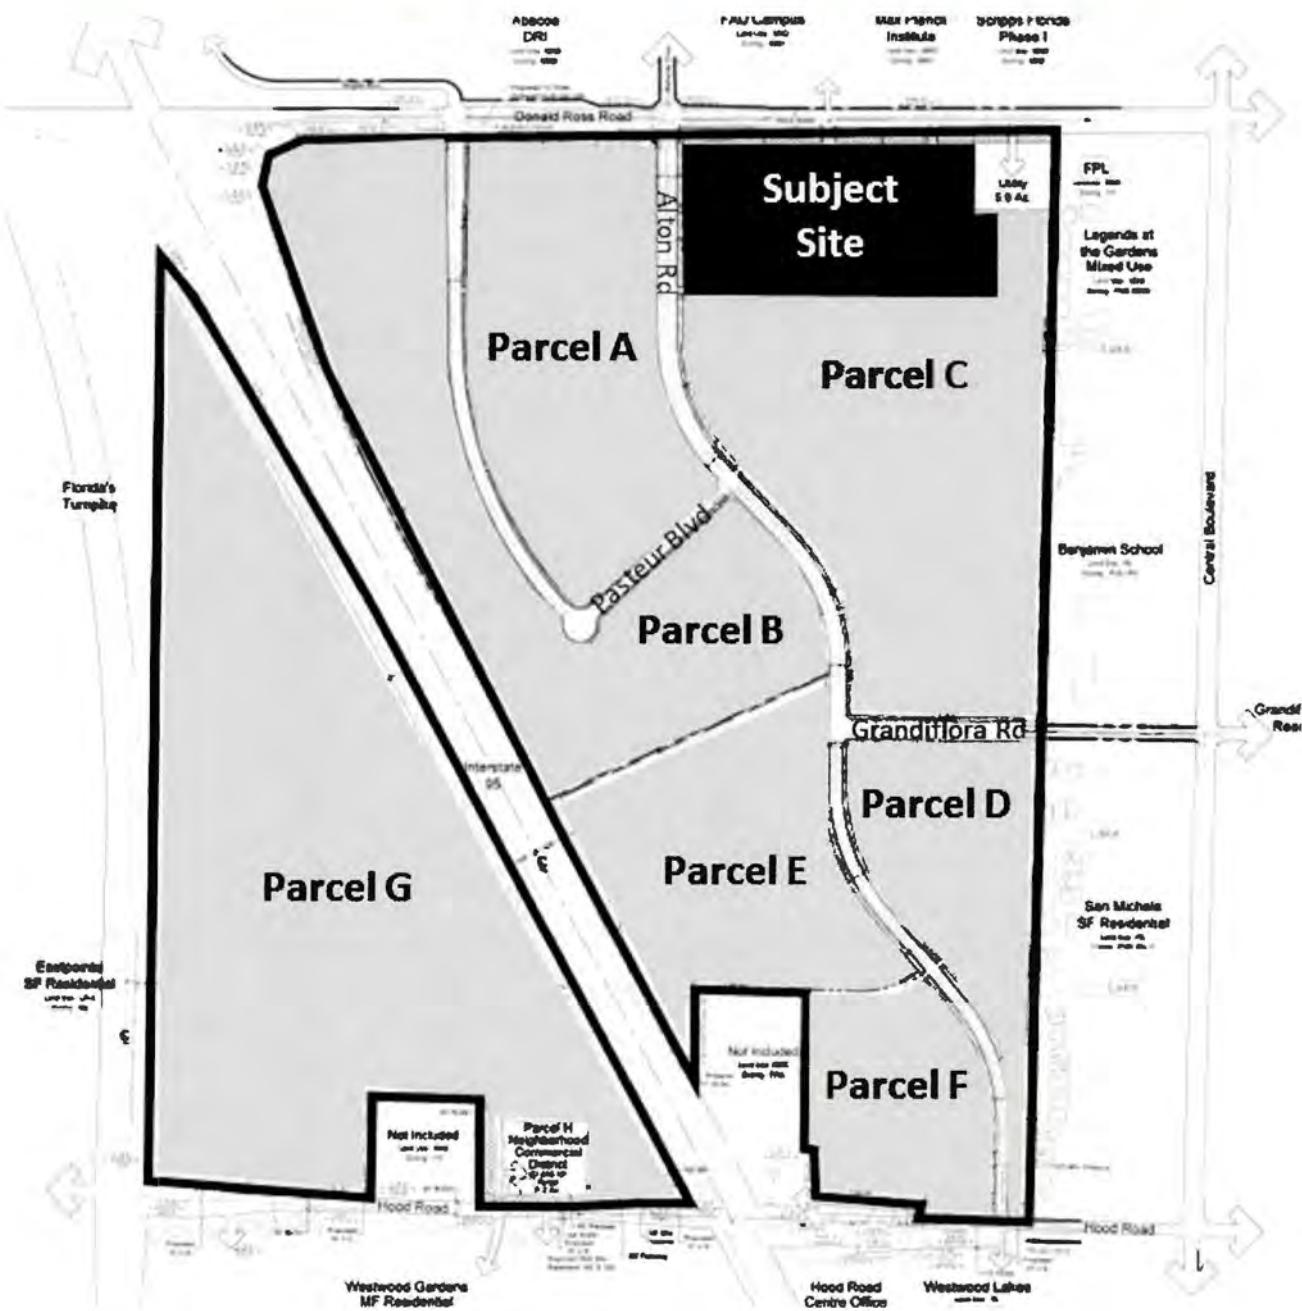

RESOLUTION 65, 2016

A RESOLUTION OF THE CITY COUNCIL OF THE CITY OF PALM BEACH GARDENS, FLORIDA GRANTING SITE PLAN AND MAJOR CONDITIONAL USE APPROVAL FOR A 360,203-SQUARE-FOOT COMMERCIAL RETAIL DEVELOPMENT WITH A DRIVE-THROUGH RESTAURANT WITHIN THE TOWN CENTER (PARCEL C) OF THE ALTON PLANNED COMMUNITY DEVELOPMENT (PCD); THE SUBJECT SITE IS APPROXIMATELY 40.8 ACRES WITHIN THE 133.68-ACRE PARCEL C, WITHIN THE 681-ACRE PLANNED COMMUNITY DEVELOPMENT (PCD), AS MORE PARTICULARLY DESCRIBED HEREIN; PROVIDING CONDITIONS OF APPROVAL; PROVIDING WAIVERS; PROVIDING AN EFFECTIVE DATE; AND FOR OTHER PURPOSES.

WHEREAS, the City Council, as the governing body of the City of Palm Beach Gardens, Florida, pursuant to the authority in Chapter 163 and Chapter 166, *Florida Statutes*, and the City's Land Development Regulations (LDR), is authorized and empowered to consider petitions related to zoning and land development orders; and

WHEREAS, the City Council adopted Ordinance 18, 2009, approving a text and map amendment for the Scripps Phase II/Briger Tract Development of Regional Impact (DRI); and

WHEREAS, the City Council adopted Ordinance 33, 2009, approving the zoning regulations and design guidelines for the Briger Planned Community District (PCD); and

WHEREAS, the City Council adopted Resolution 80, 2009, approving a 681-acre DRI for 2.6 million square feet of industrial/research and development/biotech, 1.2 million square feet of office, 300 hotel rooms, 500,000 square feet of commercial/retail development, and 2,700 dwelling units; and

WHEREAS, the City of Palm Beach Garden's Addressing Committee on January 27, 2014, approved a subdivision name change for the Scripps Florida Phase II/Briger Tract PCD to be known as the Alton PCD; and

WHEREAS, the City Council adopted Resolution 21, 2014, approving an amendment to the Alton PCD to incorporate modifications to utility easements, roadway cross sections and buffers, lakes, open space, and revisions to conditions of approval; and

WHEREAS, the City Council adopted Resolution 30, 2014, approving a site plan for 360 residential townhome and single-family dwelling units known as Neighborhood 1 within Parcel C; and

WHEREAS, the City Council adopted Resolution 31, 2015, approving a Community Design Elements and signage package for the Alton PCD; and

1 **WHEREAS**, the City Council adopted Resolution 31, 2016, approving a site plan for a
2 3.5-acre Community Recreation and Fitness Facility at the northeast corner of Parcel E of the
3 Alton PCD; and
4

5 **WHEREAS**, the City Council adopted Resolution 24, 2015, approving a site plan
6 amendment for the Center for Intelligent Buildings Technology Complex in Parcel B of the Alton
7 PCD; and
8

9 **WHEREAS**, the subject site has a Planned Community Development (PCD) Overlay
10 with an underlying Mixed Use (MXD) zoning designation and has the land-use designation of
11 Mixed Use (MXD); and
12

13 **WHEREAS**, the Planning and Zoning Department has reviewed the application, has
14 determined that it is sufficient and consistent with the City's Comprehensive Plan and Land
15 Development Regulations, and has recommended approval; and
16

17 **WHEREAS**, the Planning, Zoning, and Appeals Board reviewed the petition at its August
18 9, 2016, meeting and recommended approval of the subject petition (SPLN-15-07-000020) to
19 City Council by a vote of 7 to 0; and
20

21 **WHEREAS**, the City Council has considered the evidence and testimony presented by
22 the Applicant and other interested parties and the recommendations of the various City of Palm
23 Beach Gardens reviewing agencies and staff; and
24

25 **WHEREAS**, the City Council deems approval of this Resolution to be in the best interest
26 of the health, safety, and welfare of the residents and citizens of the City of Palm Beach
27 Gardens and the public at large.
28
29

30 **NOW, THEREFORE, BE IT RESOLVED BY THE CITY COUNCIL OF THE CITY OF**
31 **PALM BEACH GARDENS, FLORIDA** that:
32

33 **SECTION 1.** The foregoing recitals are hereby affirmed and ratified.
34

35 **SECTION 2.** The application is hereby APPROVED for a site plan permitting the
36 development of a 360,203-square-foot commercial retail development and major conditional
37 use for a restaurant with drive-through on 40.8 acres within the 133.68-acre Parcel C Town
38 Center District within the 681-acre Alton DRI/PCD, subject to the conditions of approval
39 contained herein that are in addition to the general requirements otherwise provided by
40 resolution for real property described as follows:
41

42 LEGAL DESCRIPTION:
43

44 TRACT "C-3" OF THE PLAT OF THE ALTON PCD AS RECORDED IN PLAT BOOK 118,
45 PAGES 197 THROUGH 206 OF THE PUBLIC RECORDS OF PALM BEACH COUNTY,
46 FLORIDA.
47
48

1 **SECTION 3.** The City Council of the City of Palm Beach Gardens, Florida hereby
2 APPROVES the following four (4) waivers:
3

- 4 1. Section B.5.c.(7)(b) of the Alton PCD Design Guidelines, *Primary Streets*, to allow
5 buildings along the Primary Street to not be located within ten (10) feet of the required
6 build-to line.
7
- 8 2. Section B.5.c.(7)(b) of the Alton PCD Design Guidelines, *Primary Streets*, to allow 80
9 percent of building elevations along the Primary Street to not be located within ten (10)
10 feet of the build-to line.
11
- 12 3. Section B.5.c.(7)(c) of the Alton PCD Design Guidelines, *Secondary Streets*, to permit
13 Secondary Streets within the project to not have bicycle lanes and the northern most
14 Secondary Street to not include on-street parking spaces.
15
- 16 4. Section B.5.c.(4) of the Alton PCD Design Guidelines, *Parking Regulations*, to allow for
17 a reduction in the total number of required parking spaces by 44 spaces, for a total of
18 1,679 parking spaces.
19

20 **SECTION 4.** All conditions from the development orders related to this project remain
21 in full force and effect.
22

23 **SECTION 5.** This approval is subject to the following conditions, which shall be the
24 responsibility of and binding upon the Applicant, its successors, or assigns:
25

26 **PLANNING AND ZONING**

- 27 1. Prior to issuance of the first building permit for this project, the Applicant shall schedule
28 a pre-permit meeting with the Planning and Zoning Department. (Planning and Zoning)
29
- 30 2. Prior to the issuance of the first land alteration permit for this project, the Applicant shall
31 install a six- (6) foot-tall construction fence with privacy tarp around the project site.
32 Final locations to be determined and modified by the Director of Planning and Zoning
33 at the time of building permit submittal. The construction fence with privacy tarp
34 location may be modified by the Director of Planning and Zoning during the construction
35 of the project to provide necessary screening of construction activities from the public.
36 (Planning and Zoning)
37
- 38 3. Prior to any land alteration, an environmental survey shall be submitted identifying all
39 listed plant and animal species and a relocation plan. The environmental survey shall
40 ensure compliance with the approved Preserve Area Management Plan (PAMP). The
41 environmental survey shall be submitted for review and approved by staff. (Planning
42 and Zoning)
43

- 1 4. Prior to the issuance of the first vertical building permit, the Applicant shall comply with
2 City Code Section 78-261, Art in Public Places (AIPP) and submit construction cost
3 estimates to verify the one percent (1%) vertical construction cost for the required AIPP
4 fee. Art in Public Places is required if the vertical construction cost of all new
5 improvements on the project site is greater than One Million Dollars (\$1,000,000). The
6 Applicant shall provide art on site or make a payment in lieu thereof. (Planning and
7 Zoning)
- 8 5. Prior to the issuance of any land alteration, clearing, or building permit, the Applicant
9 shall provide, to the satisfaction of the City for review and approval and to be recorded
10 in the Public Records of Palm Beach County, (i) a perpetual public access easement
11 over the Primary Street and Premier Street, which is deemed satisfied by that certain
12 Public Access Easement dated March 4, 2015, and recorded on March 6, 2015, in ORB
13 27384, Pages 279 through 292, of the Public Records of Palm Beach County, Florida;
14 and (ii) a right for the public to access the area identified on the plans as the Central
15 Plaza under a Declaration of Easements, Covenants, and Restrictions; subject,
16 however, to any reasonable limitations, conditions, and restrictions imposed on such
17 access to the Central Plaza by the Applicant from time to time. Such provisions, as set
18 forth under a Declaration of Easements, Covenants, and Restrictions, shall be
19 approved by the City Attorney and said provisions shall not be modified without the
20 written consent of the City Attorney. (Planning and Zoning)
- 21 6. Notwithstanding any provision set forth in the Public Access Easement dated March 4,
22 2015, and recorded on March 6, 2015, in ORB 27384 Pages 279 through 292, of the
23 Public Records of Palm Beach County, Florida, the Public Access Easement shall not
24 be modified or terminated without the written consent of the City of Palm Beach
25 Gardens' City Manager and City Attorney. (Planning and Zoning)
- 26 7. Prior to the issuance of any land alteration, the Applicant shall submit the proposed
27 Property Owners Association Declarations for the Town Center site for review and
28 approval by the City Attorney prior to such documents being recorded in the Public
29 Records of Palm Beach County. (Planning and Zoning)
- 30 8. Prior to the issuance of any applicable Business Tax Receipt or building permit for
31 interior renovations of tenant spaces, the Applicant or its agent shall submit a tenant
32 breakdown by use of the gross square footage for approval by the Planning and Zoning
33 Department. (Planning and Zoning)
- 34 9. Outdoor display areas are permitted only as indicated on the Outdoor Display Sales
35 (ODS) plan and shall follow strict compliance with said plan. (Planning and Zoning)
- 36 10. Outdoor storage, display, and/or sales shall be prohibited in areas not approved for
37 such uses. All delivered materials/staging areas shall be cleared of all materials and
38 storage inside the building or garden center within two (2) hours of store closing or no
39 later than 11:00 p.m. (Planning and Zoning)
- 40 11. All sales activities and any outdoor storage shall adhere to the standards sets forth in
41 Section 78-147 of the City's Code. (Planning and Zoning)

- 1 12. All signage shall be consistent with Division 7 – Signs of the City's Code, unless an
2 alternative Master Signage Program is approved by the City Council. (Planning and
3 Zoning)
- 4
- 5 13. No 24-hour fast food service or restaurant use is permitted. (Planning and Zoning)
- 6
- 7 14. All deliveries to the site shall be limited to the hours of 7:00 a.m. to 9:00 p.m. (Planning
8 and Zoning)
- 9
- 10 15. All deliveries shall be prohibited from stopping or standing within the project's roadways
11 and shall use the designated loading areas within the project. (Planning and Zoning)
- 12
- 13 16. All on-site lighting shall be cast downward and shielded from adjacent properties.
14 (Planning and Zoning)
- 15
- 16 17. The Applicant shall provide an annual update from Palm Tran regarding the provision
17 of bus service to the site no later than December 31, or until buildout of this project, or
18 until bus service has been established to the site, whichever occurs first. (Planning and
19 Zoning)
- 20
- 21 18. All shopping carts shall be prohibited from accumulating in any parking lot and loading
22 area. All carts shall be removed from cart corrals in a timely manner and relocated to
23 designated storage areas. (Planning and Zoning).
- 24
- 25 19. Any vacant building pads shall be sodded with grass and irrigated within 30 days' notice
26 from the Director of Planning and Zoning. (Planning and Zoning)
- 27
- 28 20. Two percent (2%) of the project's required vehicle parking may be converted to parking
29 spaces for alternative modes of transportation. Alternate modes of transportation shall
30 include, but not be limited to, golf carts, electric vehicles, etc. (Planning and Zoning)
- 31
- 32 21. All dumpster and trash compactors shall be screened from view in accordance with
33 Section 78-378 of the City's Code. (Planning and Zoning)
- 34
- 35 22. All new mechanical and ground-mounted equipment shall be screened from public view
36 in accordance with Section 78-195 of the City's Code. (Planning and Zoning)
- 37
- 38 23. The Applicant shall coordinate and receive approval from the Director of Planning and
39 Zoning prior to the closing of any public sidewalk. (Planning and Zoning)
- 40
- 41 24. The total restaurant square footage, including outdoor seating, shall not exceed 25
42 percent of the commercial square footage within the project. (Planning and Zoning)
- 43
- 44 25. All outdoor seating shall be in compliance with Section 78-191 of the City's Code.
45 (Planning and Zoning)
- 46
- 47 26. At no time shall staging of construction vehicles and/or service vehicles occur within a
48 public right-of-way. (Planning and Zoning)

27. Any proposed valet operation within the project shall be reviewed and approved by City staff and include the consent of such operation of the Property Owners Association for the Town Center. (Planning and Zoning)
 28. The Clusia Guttifera landscaping depicted on Sheets LP-2, LP6, and LP-10 that provide screening of the project's parking areas shall be maintained at a height of between six (6) feet and eight (8) feet providing an opaque barrier. (Planning and Zoning)
 29. Prior to the issuance of the vertical building permits for Buildings A or O-P1-P2-Q, the rear landscape buffers, including the screen wall, identified on Sheets LP-10 and LP-11 along the Primary Street shall be installed and completed. Prior to the issuance of the vertical building permit for Building T, the eight- (8) foot-tall screen wall located south and east of the building and the associated wall landscaping shall be installed. The intent of this condition is to provide adequate time for the landscape buffer to mature prior to the building becoming operational. (Planning and Zoning)
 30. Prior to the issuance of the first Certificate of Occupancy for Buildings O-P1-P2-Q or R, the central plaza, as depicted on the project plans, shall be completed. (Planning and Zoning)
 31. Prior to the issuance of the first Certificate of Occupancy for Buildings L or S, whichever occurs first, the large trellis feature depicted on Sheet SP-5 shall be completed. (Planning and Zoning)
 32. Prior to the issuance of the first Certificate of Occupancy for any of the following buildings: A, C, D, E, F, G, N, O-P-P-Q, all pedestrian streetscape amenities located on the west side of the Premier Street shall be installed. Prior to the issuance of the first Certificate of Occupancy for any of the following buildings: H, I, J, K, L, S, or T, all pedestrian and streetscape amenities located on the east side of the Premier Street shall be installed. Prior to the issuance of the first Certificate of Occupancy for any building adjacent to the Premier Street, the Premier Street and all Premier Street associated streetscape amenities shall be completed. These improvements shall include, but not be limited to, benches, lighting, trellis, crosswalk, etc. The provision of these streetscape amenities required by this condition may be modified by the Director of Planning and Zoning during construction, as necessary. (Planning and Zoning)
 33. Minor adjustments to building signage and landscaping may be approved by staff to accommodate for tree growth and signage visibility conflicts. (Planning and Zoning)
 34. Prior to the issuance of the first building permit, the Applicant shall submit a lighting and amenity plan to staff for review and approval. The lighting and amenity plan shall include, but not limited to, up-lighting, accent lighting, tree lighting, etc. The plan shall also include time frames for installation and implementation and maintenance. (Planning and Zoning)

1 **FORESTRY**

- 2
- 3 35. Prior to the issuance of the first Certificate of Occupancy for any building within this
4 project, the Donald Ross Road medians shall be landscaped in accordance with
5 Section 78-324 of the City's Code. (City Forester)

6

7 **GEOGRAPHIC INFORMATION SYSTEMS (GIS)**

- 8
- 9 36. Prior to the issuance of the first Certificate of Occupancy, digital files of the recorded
10 plat, if required, shall be submitted to the Planning and Zoning Department. (GIS
11 Manager)
- 12
- 13 37. Prior to the issuance of the first building permit for vertical construction, the Applicant
14 shall submit an addressing plan to the City for review and approval. (GIS Manager)
- 15
- 16 38. Prior to the issuance of the first building permit for vertical construction, the Applicant
17 shall submit a subdivision name to the City for review and approval. (GIS Manager)
- 18
- 19 39. Prior to the issuance of the Certificate of Occupancy for each building, the Applicant
20 shall prepare and submit an exhibit for approval that demonstrates building and tenant
21 suite addresses are consistent with Section 78-275 of the City's Code. (GIS Manager)
- 22
- 23 40. Prior to the issuance of the land alteration permit or first building permit for vertical
24 construction, the Applicant shall submit a street name plan for the project to the City's
25 Addressing Committee for review and approval. (GIS Manager)

26

27 **ENGINEERING**

- 28
- 29 41. Prior to the issuance of any land alteration, clearing, or building permit, the Applicant
30 shall submit for subdivision approval consistent with Section 78-592 of the City's Code.
31 The Applicant shall submit to the City for review and approval all proposed and required
32 easements and any easement modifications as part of said subdivision approval.
33 (Engineering)
- 34
- 35 42. The Applicant shall install the future traffic signal at the Donald Ross Road and Florida
36 Atlantic University (FAU) and project intersection in accordance with Condition of
37 Approval 30.b of Resolution 44, 2013, or as otherwise permitted and approved by Palm
38 Beach County. (Engineering)
- 39
- 40 43. Prior to the issuance of the first Certificate of Occupancy, the traffic signal required
41 pursuant to Condition of Approval 30.b of Resolution 44, 2013 shall be installed and
42 operational. (Engineering)
- 43
- 44 44. Prior to the issuance of the first Certificate of Occupancy or Certificate of Completion,
45 whichever occurs first, for the project, the Applicant shall construct the following
46 improvements:

- a. An eastbound right-turn lane on Donald Ross Road and the project's western driveway.
 - b. The northbound Alton Road outside through lane shall be striped as a right-turn lane, consistent with the striping north of this driveway, at the intersection with the Primary Street. (Engineering)

Prior to the issuance of the clearing permit, infrastructure permit, or the building permit for the vertical construction, whichever occurs first, the Applicant shall provide itemized cost estimates and surety for the project (public or private), in accordance with LDR Sections 78-309 and 78-461. The itemized cost estimates shall include all public elements for the on-site and off-site infrastructure, landscaping, and irrigation-related improvements for the project. The cost estimates shall be dated, signed and sealed by a professional engineer and landscape architect registered in the State of Florida. Surety will be based on 110% of the total combined City-approved cost estimates and shall be posted with the City. (Engineering)

Prior to the issuance of the infrastructure permit, the Applicant shall receive a Technical Compliance Approval (TCA) letter for the subdivision for this project, if required, from the Planning and Zoning Department in accordance with the City's LDRs. (Engineering)

Prior to the issuance of a land clearing, alteration, infrastructure permit, or building permit, the Applicant shall submit a construction development and phasing and construction safety plan for the City to review. At a minimum, the plan should provide a preliminary schedule of construction for specific buildings, common areas, and thoroughfares, identification of construction limits during individual phases of construction, the construction of parking areas to support completed development, and other infrastructure improvements necessary to serve the development for review and approval by staff. The construction phasing and safety plan shall include all necessary construction zone signage and fencing, as required by the Engineering Department, and will need to be monitored throughout the construction duration and modified as necessary to allow safe and effective pedestrian and vehicular movement throughout the project. The plan shall be updated, as necessary, at the request of the City Engineer and/or the Director of Planning and Zoning. (Planning and Zoning, Engineering, Police)

Prior to the issuance of the infrastructure permit, the Applicant shall submit to the City a site lighting permit application along with a signed and sealed Photometric plan. (Engineering)

Prior to the issuance of the infrastructure permit, the required ADA elements for the building entrance, pedestrian access areas, and ramps shall be shown and detailed on the plans for review by the City. (Engineering)

- 1 50. Prior to the commencement of construction, the Applicant shall schedule a pre-
2 construction meeting with City staff. Inspections related to the infrastructure permit will
3 not be performed until the pre-construction meeting has occurred. In addition, failure
4 to comply with this condition could result in a Stop-Work Order of all work/construction
5 activity for the subject development site. (Engineering)
- 6 51. The following items are required to be ongoing throughout the project:
- 7 a. The construction, operation, and/or maintenance of any elements of the subject
8 project shall not have any negative impacts on the existing drainage of surrounding
9 areas. If at any time during the project development it is determined by the City that
10 any of the surrounding areas are experiencing negative drainage impacts caused
11 by the project, it shall be the Applicant's responsibility to resolve said impacts in a
12 period of time and a manner acceptable to the City prior to additional construction
13 activities. The City may cease issuing building permits and/or Certificates of
14 Occupancy until all drainage concerns are resolved.
- 15 b. Prior to the issuance of the infrastructure permit, if applicable, the Applicant shall
16 provide the City Engineer with copies of all permits, permit applications, and
17 Requests for Additional Information to and from regulatory agencies regarding
18 issues on all permit applications, certifications, and approvals including South
19 Florida Water Management District, Northern Palm Beach County Improvement
20 District, Seacoast Utility Authority, Palm Beach County, Palm Beach County Health
21 Department, Florida Department of Transportation, etc.
- 22 c. The Applicant shall comply with all Federal EPA and State of Florida Department of
23 Environmental Protection NPDES requirements, including, but not limited to,
24 preparation of a storm water pollution prevention plan and identification of
25 appropriate Best Management Practices, as generally accepted by the
26 Environmental Protection Agency (EPA) and/or local regulatory agencies, for
27 construction activities, implementation of the approved plans, inspection, and
28 maintenance of controls during construction, including a Notice of Intent prior to the
29 issuance of the infrastructure permit and Notice of Termination prior to the issuance
30 of the Certificate of Completion for the infrastructure permit. (Engineering)
- 31 52. Prior to the issuance of the Certificate of Completion for the infrastructure permit, the
32 Applicant shall provide electronic certified civil design as-built drawings both in PDF
33 and AutoCAD formats. (Engineering)
- 34 53. Prior to the issuance of the Certificate of Completion for the infrastructure permit, the
35 Applicant shall provide copies of the required test results as provided for on the plans
36 and specifications and in accordance with the FDOT for the City's review.
37 (Engineering)
- 38 54. Prior to the issuance of the first Certificate of Occupancy and/or Certificate of
39 Completion for the new building, the Applicant shall submit all required recorded
40 easements and easement modifications to the City. (Engineering)
- 41 48

- 1 55. All pavement marking and striping, excluding parking stall striping, shall be installed
2 with thermoplastic materials. Paver bricks of appropriate color shall be used on paver
3 brick areas in lieu of paint or thermoplastic material for conformance with Section 78-
4 344 of the City's LDRs. (Engineering)
- 5 56. The locations for any proposed ATM and the photometrics for the ATMs must be
6 submitted prior the issuance of the infrastructure permit and must meet City Code 78-
7 182. (Engineering)

10 **SECTION 6.** This petition is approved subject to strict compliance with the Exhibits
11 listed below, which are attached hereto and made a part hereof as Exhibit "A":

- 13 1. Site Plan, Sheets 1 through 5, prepared by *Urban Design Kilday Studios*, dated
14 September 21, 2016.
- 16 2. Landscape Plans, Sheets LP-C and LP-1 through LP-15, prepared by *Urban Design*
17 *Kilday Studios*, dated September 6, 2016.
- 19 3. Building T Outdoor Display Plan, Sheet ODS, prepared by *CPH*, dated July 18, 2016.
- 21 4. Alton Town Center Concept Plaza Layout Plan, Sheet C-1, prepared by *Krent Wieland*
22 *Design, Inc.*, dated July 15, 2016.
- 24 5. Building A/B/C, Floor Plan, Roof Plan, and Elevations (black and white and color),
25 Sheets Z1.0 through Z1.2, prepared by *Glidden Spina and Partners*, dated July 20,
26 2016.
- 28 6. Building D, Floor Plan, Roof Plan, and Elevations (black and white and color), Sheets
29 Z2.0 through Z2.1, prepared by *Glidden Spina and Partners*, dated September 6, 2016.
- 31 7. Building E, Floor Plan, Roof Plan, and Elevations (black and white and color), Sheets
32 Z3.0 through Z3.1, prepared by *Glidden Spina and Partners*, dated September 6, 2016.
- 34 8. Building F, Floor Plan, Roof Plan, and Elevations (black and white and color), Sheets
35 Z4.0 through Z4.1, prepared by *Glidden Spina and Partners*, dated September 6, 2016.
- 37 9. Building G, Floor Plan, Roof Plan, and Elevations (black and white and color), Sheets
38 Z5.0 through Z5.1, prepared by *Glidden Spina and Partners*, dated September 6, 2016.
- 40 10. Building H, Floor Plan, Roof Plan, and Elevations (black and white and color), Sheets
41 Z6.0 through Z6.1, prepared by *Glidden Spina and Partners*, dated September 6, 2016.
- 43 11. Building I, Floor Plan, Roof Plan, and Elevations (black and white and color), Sheets
44 Z7.0 through Z7.1, prepared by *Glidden Spina and Partners*, dated September 6, 2016.
- 46 12. Building J, Floor Plan, Roof Plan, and Elevations (black and white and color), Sheets
47 Z8.0 through Z8.1, prepared by *Glidden Spina and Partners*, dated September 6, 2016.

13. Building K, Floor Plan, Roof Plan, and Elevations (black and white and color), Sheets Z9.0 through Z9.1, prepared by *Glidden Spina and Partners*, dated July 20, 2016.
 14. Building L-M, Floor Plan, Roof Plan, and Elevations (black and white and color), Sheets Z11.0 through Z11.1, prepared by *Glidden Spina and Partners*, dated July 20, 2016.
 15. Building N, Floor Plan, Roof Plan, and Elevations (black and white and color), Sheets Z12.0 through Z12.1, prepared by *Glidden Spina and Partners*, dated September 6, 2016.
 16. Building O/P/Q, Floor Plan, Roof Plan, and Elevations (black and white and color), Sheets Z13.0 through Z13.2, prepared by *Glidden Spina and Partners*, dated September 6, 2016.
 17. Building R, Floor Plan, Roof Plan, and Elevations (black and white and color), Sheets Z14.0 through Z14.1, prepared by *Glidden Spina and Partners*, dated July 20, 2016.
 18. Building S, Floor Plan, Roof Plan, and Elevations (black and white and color), Sheets Z15.0 through Z15.2, prepared by *Glidden Spina and Partners*, dated July 20, 2016.
 19. Building T – Lowes, Floor Plan and Elevations (black and white and color), Sheets A1 and A2.1, prepared by *CPH*, dated July 20, 2016.
 20. Trellis Plans and Elevations (black and white and color), Sheets Z16.0 through Z16.1, prepared by *Glidden Spina and Partners*, dated July 20, 2016.
 21. Small Trellis Elevations, Sheet Z17.0, prepared by *Glidden Spina and Partners*, dated July 20, 2016.
 22. Alton Town Center Bollard Detail, Sheet B1, prepared by *Urban Design Kilday Studios*, dated September 16, 2016.
 23. Alton Town Center Traffic Impact Statement, prepared by *Kimley-Horn and Associates, Inc.*, dated September 15, 2016.
 24. Alton Town Center Traffic Approval Letter, prepared by *Pinder Troutman Consulting, Inc.*, dated July 27, 2016.

SECTION 7. All representations made by the Applicant or the Applicant's agent at any public hearing regarding this application are specifically incorporated herein, and this approval is granted subject to same.

SECTION 8. This Resolution shall become effective immediately upon adoption.

1 PASSED AND ADOPTED this _____ day of _____, 2016.
2
3
4
5
6

7
8 CITY OF PALM BEACH GARDENS, FLORIDA
9

10 BY: _____
11 Marcie Tinsley, Mayor
12

13 ATTEST:
14

15 BY: _____
16 Patricia Snider, CMC, City Clerk
17

18 APPROVED AS TO FORM AND
19 LEGAL SUFFICIENCY
20

21 BY: _____
22 R. Max Lohman, City Attorney
23

24
25 VOTE: AYE NAY ABSENT
26

27 MAYOR TINSLEY _____
28

29 VICE MAYOR JABLIN _____
30

31 COUNCILMEMBER PREMUROSO _____
32

33 COUNCILMEMBER MARINO _____
34

35 COUNCILMEMBER WOODS _____
36



EXHIBIT “A”

Kimley»Horn

August 5, 2015
Revised February 15, 2016
Revised April 14, 2016
Revised June 22, 2016
Revised July 7, 2016
Revised July 20, 2016
Revised September 15, 2016

Mr. William Bouwman and
Mr. Andrew Brock
NADG/Brock [Alton PBG], LLP
400 Clematis Street, Suite 201
West Palm Beach, Florida 33401

**RE: Alton Town Center
Traffic Impact Statement
Palm Beach Gardens, Florida
KHA #144981000**

Dear Mr. Bouwman and Mr. Brock:

It is proposed to develop the site on the south side of Donald Ross Road, just west of Central Boulevard, in the City of Palm Beach Gardens, Florida. The location of the site is illustrated in *Figure 1*. The parcel control number (PCN) for the site is 52-42-41-26-00-100-3003. The site is a part of the Briger East DRI.

The existing site is currently vacant. It is proposed to develop 346,403 square feet of retail uses, including general retail, home improvement superstore, fast-food restaurant with drive-through, drive-in bank and gas station with convenience store and car wash. An additional 13,800 square feet of outdoor seating area is anticipated. Although the physical location of this seating area is not identified on the site plan, the trips associated with this seating area have been included in this analysis. This analysis has been prepared to demonstrate the proposed uses in addition to up to 13,800 square feet of future outdoor seating area are within the traffic impacts anticipated within the Briger East DRI. A buildout year of 2019 is proposed.

CONVERSION ANALYSIS

The existing Parcel C has an allocation of 450,000 square feet of retail use. A trip conversion analysis was therefore prepared to compare the proposed development plan to the allowable allocation of trips. The trip conversion matrix and methodology outlined in the DRI was utilized for purposes of converting the 450,000 square foot retail allocation to the specific mix of uses proposed on this site plan. *Table 1* includes a summary of the conversion. Conversion rates are included in the matrix for conversions from the retail use to the fast-food with drive-through use and the drive-in

bank use. Conversion rates for conversion from retail use to gas station with convenience store and car wash, and the home improvement store, are not included in the matrix. Therefore, the methodology noted in the matrix for conversion to alternate uses was applied. As noted in the matrix:

ITE PM Peak Hour Rate is the Average Two-Way PM Peak Hour Rate multiplied by the outbound split percentage.

The PM peak hour rates for gas station with convenience store and car wash as well as the home improvement superstore were based on the rates reported in the *ITE Trip Generation Manual, 9th Edition*. Fueling positions were utilized as the independent variable for the gas station and convenience store. The convenience store was also included as retail use, providing a conservative analysis. To convert from the retail use to the gas station use and the home improvement superstore use, the rate described above is then divided by the approved retail use rate reported in the matrix. As shown in *Table 1*, the proposed conversion of non-general-retail uses results in a reduction of 201,848 square feet of general retail use. The proposed plan includes 235,361 square feet of retail use inclusive of the additional 13,800 square feet of future outdoor seating area; therefore, the existing allocation of 450,000 square feet of retail use on this parcel can be converted to the proposed uses.

CUMULATIVE TRIP ANALYSIS

The daily and peak hour trip generation potential for the proposed development plan was calculated based on trip generation rates published as part of the Briger East DRI as available, or the ITE rates for uses not included in the DRI. Rates reported in the *ITE Trip Generation Manual, 9th Edition* were utilized for the proposed fast-food with drive-through, gas station with convenience store and car wash, and drive-in bank uses. Furthermore, pass-by reductions were applied to the rates to determine net trips. It should be noted that internalization was not included in the calculation; therefore, this analysis is conservative.

Per the conditions of approval for the DRI, the cumulative trips from all previously-approved site plans within the DRI must be included in this analysis. Sites within the DRI have been approved for 217 single-family homes, 143 multifamily units, 353 apartments and 224,066 SF of office use. As indicated in *Table 2*, the cumulative development (proposed and approved) is expected to generate 960 net AM peak-hour trips and 1,361 net PM peak hour trips. Section 4.3 of the City of Palm Beach Gardens Resolution 80-09 limits Phase 1 development to 1,369 cumulative net AM peak hour trips and 2,174 cumulative net PM peak hour trips. Therefore, the proposed development falls below the trip threshold for Phase 1. Therefore, no further analysis is required.

Section 3.30.b of Resolution 44-13 of the plat note states:

When a vehicular connection is made to Donald Ross Road at Florida Atlantic University (FAU), then no building permits for development within Parcel C, the Town Center District, that generates more than 400 net external AM peak-hour trips or 650 net external PM peak hour trips, whichever occurs first, shall be issued until a surety bond has been posted and the contracts have been let to remove

the median restriction on Donald Ross Road and install the traffic signal at Donald Ross Road and FAU.

Because the proposed development will generate more than 400 net external AM peak-hour trips and more than 650 net external PM peak-hour trips, a surety bond is required for the signal at this time.

TRAFFIC ASSIGNMENT

The AM and PM peak hour trips associated with the project were assigned to the adjacent roadway links according to the approved DRI distribution. *Figure 2* illustrates the project traffic assignment.

SITE CIRCULATION AND TURN LANE REQUIREMENTS

Access to the site is proposed two right-in/right-out driveways on Donald Ross Road, one right-in/right-out driveway on Alton Drive, one full-access driveway on Alton Drive, and one full-access driveway on Donald Ross Road.

The project driveway volumes were compared against the Palm Beach County thresholds to determine the turn lane requirements of the site's driveways. The Palm Beach County Land Development Standards Manual identifies its threshold for providing a right-turn lane as 75 or more right turns during peak hour conditions on roadways with an Average Daily Traffic (ADT) volumes of 10,000 vehicles or more and its threshold for providing a left turn lane as 30 or more left turns during peak hour conditions.

Using these criteria, the left-turn volume is greater than 30 vehicles per hour at the southernmost full-access drive along Alton Drive and at the full median opening on Donald Ross Road. Left turn lanes are shown at these locations on the attached site plan. The Right turn volume is greater than 75 peak hour vehicles at the full median opening on Donald Ross Road and the two driveways on Alton Road. The right-turn lane on Donald Ross Road is shown on the attached site plan. Due to the lower traffic volumes projected for Alton Drive, the more urban characteristic of the roadway, and that considering that the roadway is under the jurisdiction of the City of Palm Beach Gardens, the County's thresholds have not been applied to this City roadway and right-turn lanes are not proposed for the driveways on Alton Road. It should be noted that the driveway volume calculations are based on gross project traffic volumes and do not include internal capture reduction; therefore the driveway volumes are conservative.

CONCLUSION

The foregoing analysis demonstrates that the proposed modification to the development is within the approved trip thresholds for the approved Briger DRI. Therefore, no additional analysis is required.

Should you have any questions regarding this analysis please contact me at (561) 840-0874 or adam.kerr@kimley-horn.com.

Sincerely,



Adam B. Kerr, P.E.
Transportation Engineer

Florida Registration
Number 64773
Certificate of Authorization
Number 696


Attachments



LEGEND
 SITE LOCATION

FIGURE 1
SITE LOCATION
ALTON TOWN CENTER

Kimley»Horn

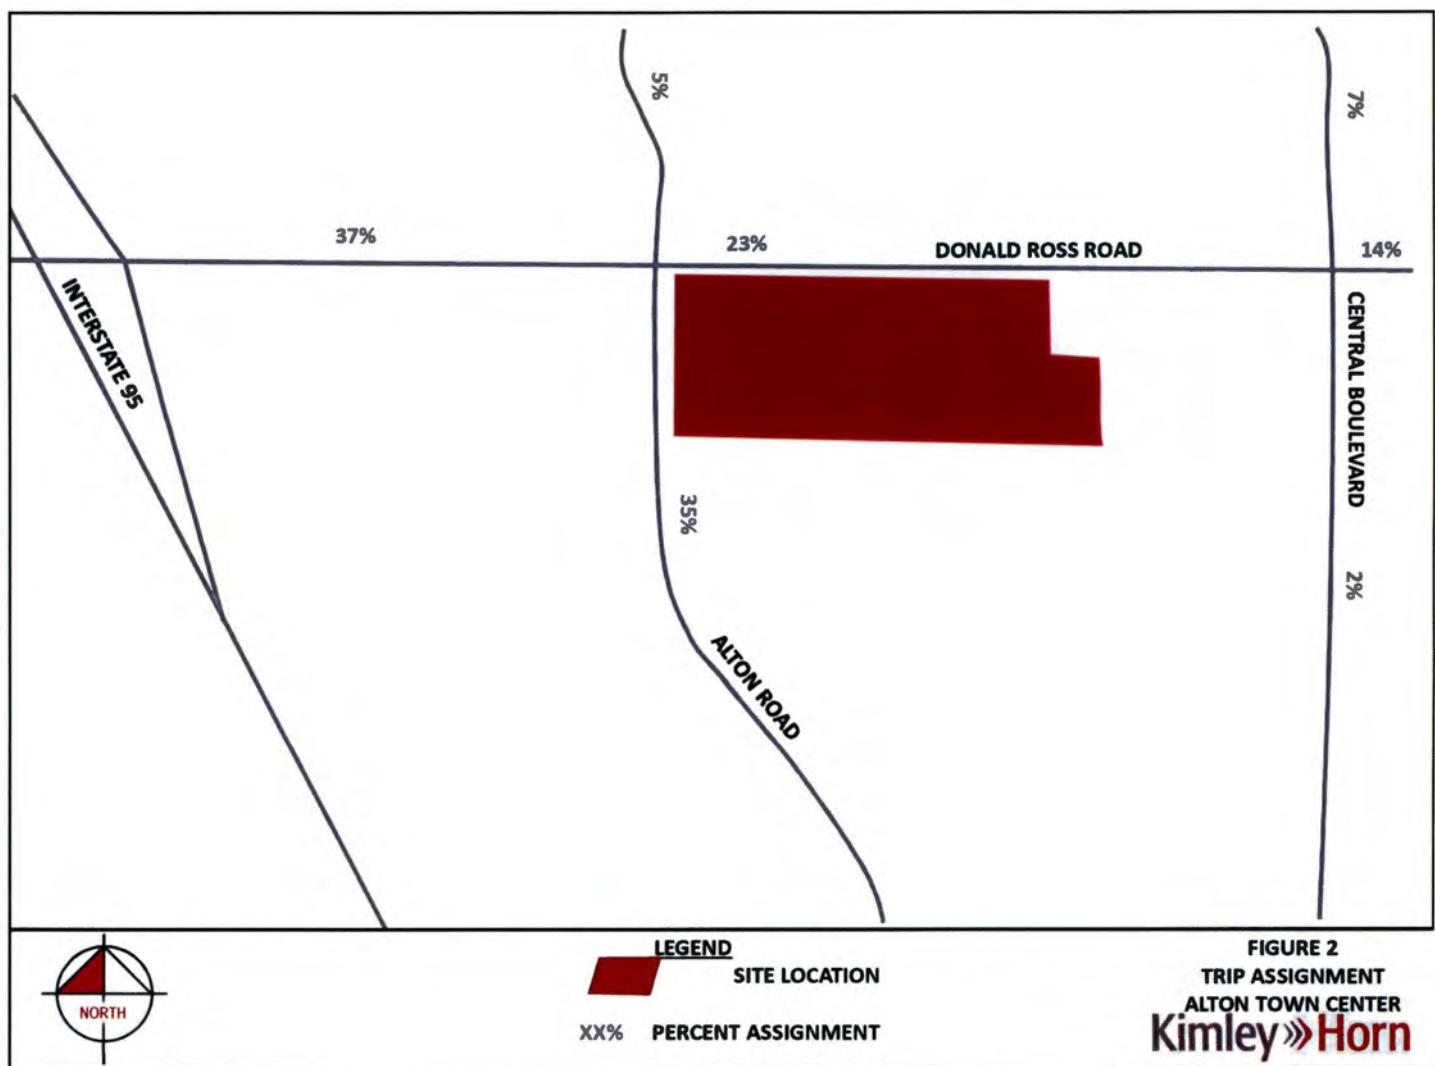

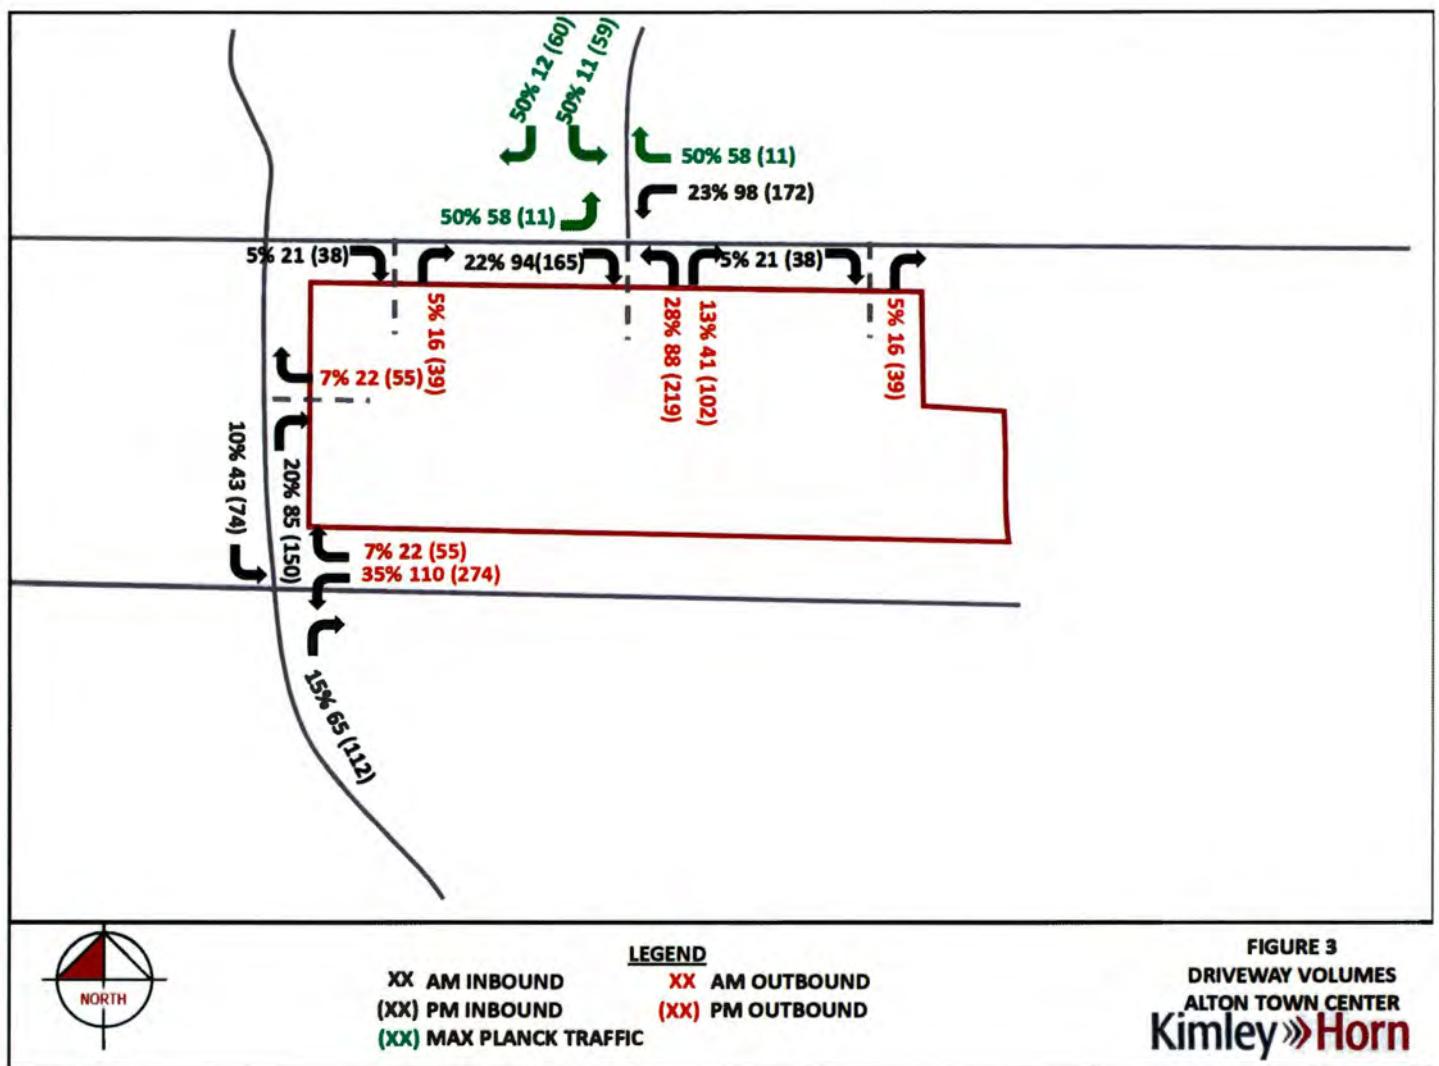


TABLE 1
CONVERSION MATRIX
ALTON TOWN CENTER

LAND USE	INTENSITY	CONVERSION RATE	AMOUNT TO REDUCE
Approved Use			
Town Center (Retail)	450,000 s.f.	--	--
Proposed Development			
Fast Food Restaurant + DT	2,006 s.f.	9.2373	18,530
Drive-in Bank	3,475 s.f.	12.7056	44,152
Home Improvement Superstore *	119,361 s.f.	0.6602	78,798
Gas Station with Convenience Store & Car Wash **	16 s.f.	3.7730	60,368
Total Retail Reduction			201,848
Total Proposed Retail***			235,361

* PM Peak Hour Two-Way rate of 2.33 trips/ksf multiplied by 51% outbound split and divided by retail rate of 1.8

** PM Peak Hour Two-Way rate of 13.86 trips/fp multiplied by 49% outbound split and divided by retail rate of 1.8

*** Includes 13,800 SF of outdoor seating area

TABLE 2
TRIP GENERATION COMPARISON
ALTON TOWN CENTER

LAND USE	INTENSITY	AM PEAK HOUR			PM PEAK HOUR		
		TOTAL	IN	OUT	TOTAL	IN	OUT
Proposed Development (Net New Trips)							
Town Center (Retail)	235,361 s.f.	150	92	58	504	242	262
Fast Food Restaurant + DT	2,006 s.f.	46	23	23	33	17	16
Drive-in Bank	3,475 s.f.	22	13	9	45	23	22
Gas Station with Convenience Market + Car Wash	16 fp	72	37	35	98	50	48
Home Improvement Superstore	119,361 s.f.	103	53	50	161	79	82
Gross Trips (Proposed Development)		393	218	175	841	411	430
Approved Development (per DRI Rates)							
Single Family (East)	217 units	132	33	99	136	86	50
Multi Family	143 units	41	7	34	39	26	13
Apartments	353 units	146	29	117	145	94	51
Office	224,066 SF	248	206	42	200	34	166
Net New External Trips (Approved Development)		567	275	292	520	240	280
Total Gross Trips (Proposed + Approved)		960	493	467	1,361	651	710

Trip Generation calculated using the following equations:

Net New AM Trips

Town Center (Retail)	[DRI]	=	0.638 trips/1,000 square feet; (61% in, 39% out)
Fast Food Restaurant + DT	[ITE 934]	=	45.42 trips / 1,000 SF (51% in, 49% out) + 49% pass-by
Drive-In Bank	[ITE 912]	=	12.08 trips / 1,000 SF (57% in, 43% out) + 47% pass-by
Gas Station with Convenience Market + Car Wash	[ITE 946]	=	11.84 trips / FP (51% in, 49% out) + 62% pass-by
Home Improvement Superstore	[ITE 862]	=	1.49 trips / 1,000 SF (57% in, 43% out) + 42% pass-by
Single Family (East)	[DRI]	=	0.606 trips/unit; (25% in, 75% out)
Multi Family	[DRI]	=	0.284 trips/unit; (17% in, 83% out)
Apartments	[DRI]	=	0.415 trips/unit; (20% in, 80% out)
Office	[DRI]	=	1.106 trips/1,000 square feet; (88% in, 12% out)

Net New PM Trips

Town Center (Retail)	[DRI]	=	2.14 trips/1,000 square feet; (48% in, 52% out)
Fast Food Restaurant + DT	[ITE 934]	=	32.65 trips / 1,000 SF (52% in, 48% out) + 50% pass-by
Drive-In Bank	[ITE 912]	=	24.30 trips / 1,000 SF (50% in, 50% out) + 47% pass-by
Gas Station With Convenience Market + Car Wash	[ITE 946]	=	13.86 trips / FP (51% in, 49% out) + 56% pass-by
Home Improvement Superstore	[ITE 862]	=	2.33 trips / 1,000 SF (49% in, 51% out) + 42% pass-by
Single Family (East)	[DRI]	=	0.629 trips/unit; (63% in, 37% out)
Multi Family	[DRI]	=	0.275 trips/unit; (67% in, 33% out)
Apartments	[DRI]	=	0.410 trips/unit; (65% in, 35% out)
Office	[DRI]	=	0.893 trips/1,000 square feet; (17% in, 83% out)

TABLE 3
TRIP GENERATION COMPARISON FOR DRIVEWAY VOLUMES
ALTON TOWN CENTER

LAND USE	INTENSITY	AM PEAK HOUR			PM PEAK HOUR		
		TOTAL	IN	OUT	TOTAL	IN	OUT
Proposed Development (Gross Trips)							
Town Center (Retail)	235,361 s.f.	242	148	94	883	424	459
Fast Food Restaurant + DT	2,006 s.f.	91	46	45	65	34	31
Drive-in Bank	3,475 s.f.	42	24	18	84	42	42
Gas Station with Convenience Market and Car Wash	16 fp	189	108	81	222	113	109
Home Improvement Superstore	119,361 s.f.	178	101	77	278	136	142
Net New Gross Trips (Proposed Development)		742	427	315	1,532	749	783
Trip Generation calculated using the following equations:							
Net New AM Trips							
Town Center (Retail)	[DRI]	=	1.03 trips/1,000 square feet; (61% in, 39% out)				
Fast Food Restaurant + DT	[ITE 934]	=	45.42 trips / 1,000 SF (51% in, 49% out)				
Drive-in Bank	[ITE 912]	=	12.08 trips / 1,000 SF (57% in, 43% out)				
Gas Station with Convenience Market and Car Wash	[ITE 946]	=	11.84 trips / 1,000 SF (51% in, 49% out)				
Home Improvement Superstore	[ITE 862]	=	1.49 trips / 1,000 SF (57% in, 43% out)				
Net New PM Trips							
Town Center (Retail)	[DRI]	=	3.753 trips/1,000 square feet; (48% in, 52% out)				
Fast Food Restaurant + DT	[ITE 934]	=	32.65 trips / 1,000 SF (52% in, 48% out)				
Drive-In Bank	[ITE 912]	=	24.30 trips / 1,000 SF (50% in, 50% out)				
Gas Station with Convenience Market and Car Wash	[ITE 946]	=	13.86 trips / FP (51% in, 50% out)				
Home Improvement Superstore	[ITE 862]	=	2.33 trips / 1,000 SF (49% in, 51% out)				

SHORT REPORT												
General Information				Site Information								
Analyst Agency or Co. KHA Date Performed 07/20/2016 Time Period AM Peak				Intersection Donald Ross Rd & Driveway Area Type All other areas Jurisdiction Analysis Year 2019								
Volume and Timing Input												
	EB			WB			NB			SB		
	LT	TH	RT	LT	TH	RT	LT	TH	RT	LT	TH	RT
Number of Lanes	1	3	1	1	4	0	1	1	0	1	1	0
Lane Group	L	T	R	L	TR		L	TR		L	TR	
Volume (vph)	58	1733	94	98	929	58	88	0	41	11	0	12
% Heavy Vehicles	2	2	2	2	2	2	2	2	2	2	2	2
PHF	0.95	0.95	0.95	0.95	0.95	0.95	0.95	0.92	0.95	0.92	0.92	0.95
Pretimed/Actuated (P/A)	A	A	A	A	A	A	A	A	A	A	A	A
Startup Lost Time	2.0	2.0	2.0	2.0	2.0		2.0	2.0		2.0	2.0	
Extension of Effective Green	2.0	2.0	2.0	2.0	2.0		2.0	2.0		2.0	2.0	
Arrival Type	3	3	3	3	3		3	3		3	3	
Unit Extension	3.0	3.0	3.0	3.0	3.0		3.0	3.0		3.0	3.0	
Ped/Bike/RTOR Volume	0	0	0	0	0	58	0	0	10	0	0	10
Lane Width	12.0	12.0	12.0	12.0	12.0		12.0	12.0		12.0	12.0	
Parking/Grade/Parking	N	0	N	N	0	N	N	0	N	N	0	N
Parking/Hour												
Bus Stops/Hour	0	0	0	0	0		0	0		0	0	
Minimum Pedestrian Time		3.2			3.2			3.2			3.2	
Phasing	Excl. Left	Thru & RT		03	04	Excl. Left	NS Perm		07		08	
Timing	G = 14.0 Y = 5	G = 69.5 Y = 6.5	G =	G =	G = 15.0 Y = 5	G = 20.0 Y = 5	G =	G =				
Duration of Analysis (hrs) = 0.25				Cycle Length C = 140.0								
Lane Group Capacity, Control Delay, and LOS Determination												
	EB			WB			NB			SB		
	Adjusted Flow Rate	61	1824	99	103	978		93	33		12	2
Lane Group Capacity	177	2519	786	177	3358		440	226		413	226	
v/c Ratio	0.34	0.72	0.13	0.58	0.29		0.21	0.15		0.03	0.01	
Green Ratio	0.10	0.50	0.50	0.10	0.50		0.29	0.14		0.29	0.14	
Uniform Delay d_1	58.7	27.7	18.9	60.2	20.8		37.7	52.5		36.0	51.5	
Delay Factor k	0.11	0.28	0.11	0.17	0.11		0.11	0.11		0.11	0.11	
Incremental Delay d_2	1.2	1.1	0.1	4.8	0.0		0.2	0.3		0.0	0.0	
PF Factor	1.000	1.000	1.000	1.000	1.000		1.000	1.000		1.000	1.000	
Control Delay	59.9	28.8	19.0	65.0	20.8		37.9	52.8		36.0	51.5	
Lane Group LOS	E	C	B	E	C		D	D		D	D	
Approach Delay		29.2			25.0			41.8			38.2	
Approach LOS		C			C			D			D	
Intersection Delay		28.3			Intersection LOS						C	

BACK-OF-QUEUE WORKSHEET												
General Information												
Project Description Donald Ross Rd & Driveway												
Average Back of Queue												
	EB			WB			NB			SB		
	LT	TH	RT	LT	TH	RT	LT	TH	RT	LT	TH	RT
Lane Group	<i>L</i>	<i>T</i>	<i>R</i>	<i>L</i>	<i>TR</i>		<i>L</i>	<i>TR</i>		<i>L</i>	<i>TR</i>	
Initial Queue/Lane	0.0	0.0	0.0	0.0	0.0		0.0	0.0		0.0	0.0	
Flow Rate/Lane Group	61	1824	99	103	978		93	33		12	2	
Satflow/Lane	1770	1862	1583	1770	1862		1540	1583		1443	1583	
Capacity/Lane Group	177	2519	786	177	3358		440	226		413	226	
Flow Ratio	0.0	0.4	0.1	0.1	0.1		0.1	0.0		0.0	0.0	
v/c Ratio	0.34	0.72	0.13	0.58	0.29		0.21	0.15		0.03	0.01	
I Factor	1.000	1.000	1.000	1.000	1.000		1.000	1.000		1.000	1.000	
Arrival Type	3	3	3	3	3		3	3		3	3	
Platoon Ratio	1.00	1.00	1.00	1.00	1.00		1.00	1.00		1.00	1.00	
PF Factor	1.00	1.00	1.00	1.00	1.00		1.00	1.00		1.00	1.00	
Q1	2.2	20.5	2.1	3.8	6.2		2.6	1.1		0.3	0.1	
kB	0.3	0.9	0.8	0.3	0.9		0.5	0.4		0.5	0.4	
Q2	0.2	2.1	0.1	0.4	0.4		0.1	0.1		0.0	0.0	
Q Average	2.4	22.6	2.2	4.3	6.5		2.8	1.2		0.4	0.1	
Percentile Back of Queue (95th percentile)												
fB%	2.0	1.7	2.0	2.0	1.9		2.0	2.1		2.1	2.1	
Back of Queue	4.8	37.7	4.4	8.4	12.5		5.6	2.4		0.7	0.1	
Queue Storage Ratio												
Queue Spacing	25.0	25.0	25.0	25.0	25.0		25.0	25.0		25.0	25.0	
Queue Storage	0	0	0	0	0		0	0		0	0	
Average Queue Storage Ratio												
95% Queue Storage Ratio												

SHORT REPORT												
General Information				Site Information								
Analyst Agency or Co. KHA Date Performed 07/20/2016 Time Period PM Peak				Intersection Donald Ross Rd & Driveway								
Area Type All other areas Jurisdiction				Analysis Year 2019								
Volume and Timing Input				EB			WB			NB		
				LT	TH	RT	LT	TH	RT	LT	TH	RT
Number of Lanes				1	3	1	1	4	0	1	1	0
Lane Group				L	T	R	L	TR		L	TR	
Volume (vph)				11	1355	165	174	1773	11	219	0	102
% Heavy Vehicles				2	2	2	2	2	2	2	2	2
PHF				0.95	0.95	0.95	0.95	0.95	0.95	0.95	0.95	0.95
Pretimed/Actuated (P/A)				A	A	A	A	A	A	A	A	A
Startup Lost Time				2.0	2.0	2.0	2.0	2.0		2.0	2.0	
Extension of Effective Green				2.0	2.0	2.0	2.0	2.0		2.0	2.0	
Arrival Type				3	3	3	3	3		3	3	
Unit Extension				3.0	3.0	3.0	3.0	3.0		3.0	3.0	
Ped/Bike/RTOR Volume				0	0	60	0	0	11	0	0	10
Lane Width				12.0	12.0	12.0	12.0	12.0		12.0	12.0	
Parking/Grade/Parking				N	0	N	N	0	N	N	0	N
Parking/Hour												
Bus Stops/Hour				0	0	0	0	0		0	0	
Minimum Pedestrian Time					3.2			3.2		3.2		3.2
Phasing	Excl. Left	Thru & RT		03		04		Excl. Left	NS Perm	07		08
Timing	G = 25.0	G = 58.5	G =	G =	G =	G = 15.0	G = 20.0	G =	G =			
	Y = 5	Y = 6.5	Y =	Y =	Y =	Y = 5	Y = 5	Y =	Y =			
Duration of Analysis (hrs) = 0.25				Cycle Length C = 140.0								
Lane Group Capacity, Control Delay, and LOS Determination												
				EB			WB			NB		
Adjusted Flow Rate				12	1426	111	183	1866		231	97	
Lane Group Capacity				316	2120	661	316	2827		396	226	
v/c Ratio				0.04	0.67	0.17	0.58	0.66		0.58	0.43	
Green Ratio				0.18	0.42	0.42	0.18	0.42		0.29	0.14	
Uniform Delay d ₁				47.6	33.0	25.5	52.7	32.8		42.2	54.8	
Delay Factor k				0.11	0.24	0.11	0.17	0.23		0.17	0.11	
Incremental Delay d ₂				0.0	0.8	0.1	2.7	0.6		2.2	1.3	
PF Factor				1.000	1.000	1.000	1.000	1.000		1.000	1.000	
Control Delay				47.6	33.8	25.6	55.3	33.3		44.4	56.1	
Lane Group LOS				D	C	C	E	C		D	E	
Approach Delay					33.4			35.3			47.9	
Approach LOS					C		D			D		
Intersection Delay					35.8				Intersection LOS			D

BACK-OF-QUEUE WORKSHEET												
General Information												
Project Description Donald Ross Rd & Driveway												
Average Back of Queue												
	EB			WB			NB			SB		
	LT	TH	RT	LT	TH	RT	LT	TH	RT	LT	TH	RT
Lane Group	<i>L</i>	<i>T</i>	<i>R</i>	<i>L</i>	<i>TR</i>		<i>L</i>	<i>TR</i>		<i>L</i>	<i>TR</i>	
Initial Queue/Lane	0.0	0.0	0.0	0.0	0.0		0.0	0.0		0.0	0.0	
Flow Rate/Lane Group	12	1426	111	183	1866		231	97		63	52	
Satflow/Lane	1770	1862	1583	1770	1862		1386	1583		1251	1583	
Capacity/Lane Group	316	2120	661	316	2827		396	226		358	226	
Flow Ratio	0.0	0.3	0.1	0.1	0.3		0.2	0.1		0.1	0.0	
v/c Ratio	0.04	0.67	0.17	0.58	0.66		0.58	0.43		0.18	0.23	
I Factor	1.000	1.000	1.000	1.000	1.000		1.000	1.000		1.000	1.000	
Arrival Type	3	3	3	3	3		3	3		3	3	
Platoon Ratio	1.00	1.00	1.00	1.00	1.00		1.00	1.00		1.00	1.00	
PF Factor	1.00	1.00	1.00	1.00	1.00		1.00	1.00		1.00	1.00	
Q1	0.4	16.5	2.7	6.5	16.0		6.8	3.4		1.8	1.8	
kB	0.5	0.8	0.7	0.5	0.8		0.5	0.4		0.5	0.4	
Q2	0.0	1.5	0.1	0.6	1.4		0.7	0.3		0.1	0.1	
Q Average	0.4	18.0	2.8	7.1	17.5		7.5	3.7		1.9	1.9	
Percentile Back of Queue (95th percentile)												
fB%	2.1	1.7	2.0	1.9	1.7		1.9	2.0		2.0	2.0	
Back of Queue	0.8	30.9	5.7	13.6	30.2		14.3	7.4		3.8	3.9	
Queue Storage Ratio												
Queue Spacing	25.0	25.0	25.0	25.0	25.0		25.0	25.0		25.0	25.0	
Queue Storage	0	0	0	0	0		0	0		0	0	
Average Queue Storage Ratio												
95% Queue Storage Ratio												

NOW, THEREFORE, BE IT RESOLVED BY THE CITY COUNCIL OF THE CITY
OF PALM BEACH GARDENS, FLORIDA that:

SECTION 1. The foregoing recitals are hereby affirmed and ratified.

SECTION 2. The application is hereby APPROVED for an amendment to Conditions #30, #31, and #32 of Resolution 80, 2009 related to certain intersection improvements for the real property described as follows:

(See Exhibit "A" for Legal Description)

SECTION 3. Condition #30 shall be modified to reflect the following changes illustrated in ~~strike~~underline format:

30. Scripps Florida – Phase II/Briger Tract Development of Regional Impact shall have the following connections to the external roadway network consistent with Map H, Master Development Plan:

- Four connections to Donald Ross Road, as listed in Conditions 31.a.-d.;
 - Three connections to Hood Road, as listed in Condition 31.f and Conditions 33.a. and b.; and
 - One connection to Central Boulevard via Grandiflora Road.

a) For the intersections listed in Conditions 31.e., 31.f., 33.a., and 33.b., which are not currently signalized, signalization shall be provided, if warranted, through completion of the DRI. A signal warrant study for each of these intersections shall be submitted with the biennial report according to the following schedule until signalization is warranted. For the intersection listed in Condition 31.e., the first warrant study shall be included in the next biennial report after construction of the required improvements at that intersection. For the intersections listed in Conditions 31.f., 33.a., and 33.b., the first signal warrant study count shall be included in the next biennial report after the first building permit for vertical construction, west of I-95, is issued for development west of I-95.

b) When a vehicular connection is made to Donald Ross Road at Florida Atlantic University (FAU), then no building permits for development within Parcel C, the Town Center District, that generates more than 400 net external AM peak-hour trips or 650 net external PM peak-hour trips, whichever occurs first, shall be issued until a surety bond has been posted and the contracts have been let to remove the median restriction on Donald Ross Road and install the traffic signal at Donald Ross Road and FAU.

1 slabs or footings or any work beyond the stage of excavation or land clearing, such as
 2 the construction of roadways or other utility infrastructure.

3

4 **Phasing**

5

6 3. The following phasing table for the Scripps Florida - Phase II/Briger Tract
 7 Development of Regional Impact is based on information provided in Table 10-A,
 8 included in the answer to Question 10 – General Project Description, in the Application
 9 for Development Approval.

Phase	Years	Industrial/ R&D/ Biotech (SF)	Office (SF)	Retail (SF)	Residential (DU)	Hotel (rooms)
1	2009- 2013	300,000	100,000	500,000	800	300
2	2014- 2018	400,000	200,000	0	850	0
3	2019- 2023	400,000	200,000	0	500	0
4	2024- 2028	1,500,000	700,000	0	550	0
Total	2009- 2028	2,600,000	1,200,000	500,000	2,700	300

11 This table is not intended to restrict the amount or type of development by phase,
 12 provided the Development Order in its entirety is followed. Rather, the amount and type
 13 of development within each phase is only limited by the following maximum number of
 14 trips for each phase. These trip amounts are cumulative (include trips from previous
 15 phase), and were derived from the trips generated by the development program for each
 16 phase listed above. These trip totals were used to calculate the timing of proportionate
 17 share payments and the timing of other required traffic improvements. The maximum
 18 number of trips for each phase is as follows:

<u>Phase</u>	<u>AM Peak-Hour Trips¹</u>	<u>PM Peak-Hour Trips¹</u>
1	1,369	2,174
2	2,397	3,089
3	3,176	3,778
4	5,361	5,528

30 ¹ Cumulative net external trips

31 A phase is considered complete when either the AM or PM Net External Peak-Hour trip
 32 number for that phase is met.

TABLE 2
TRIP GENERATION COMPARISON
MAX PLANCK WAY

LAND USE	INTENSITY	DAILY TRIPS	AM PEAK HOUR			PM PEAK HOUR		
			TOTAL	IN	OUT	TOTAL	IN	OUT
Existing Development								
Research and Development Center	107,366 s.f.	1,066	138	115	23	140	21	119
Net New External Trips (Existing Development)								
		1066	138	115	23	140	21	119
Trip Generation calculated using the following equations:								
Net New AM Trips		Research and Development Center	[ITE 760]	=	$LN(T) = 0.87 * LN(X/1000 SF) + 0.86; (83\% \text{ in}, 17\% \text{ out})$			
Net New PM Trips		Research and Development Center	[ITE 760]	=	$LN(T) = 0.83 * LN(X/1000 SF) + 1.06; (15\% \text{ in}, 85\% \text{ out})$			

SITE DATA:

PERMIT NUMBER:
 PROJECT NAME:
 PROPERTY ADDRESS: LAND USE DESIGNATION:
 CITY/TOWN/COUNTRY:
 ZIP CODE:
 PHONE NUMBER:
 FAX NUMBER:
GENERAL SITE AREA:
 PHASE 1
 PHASE 2

PROPOSED USE:


TOTAL BLDG SQFT.:
 GROSS BLDG SQFT.:
 TOTAL RESTAURANT SQFT.:
 TOTAL BAR SQFT.:
 TOTAL KITCHEN SQFT.:
 LET OPERATOR ALLOWED ONLY ONE
 LET OPERATOR PURPOSE:
OPERATING AREA:
 PERMITTED USES:
 TRAFFIC ANALYSIS ZONE (TAN)

PROPERTY DEVELOPMENT REGULATIONS:

NOTES



**Urban Planning & Design
Landscape Architecture
Communication Graphics**
**340 Diamond Street, Suite 2400
West Palm Beach, FL 33401
(800) 285-1100 FAX (800) 285-1111**

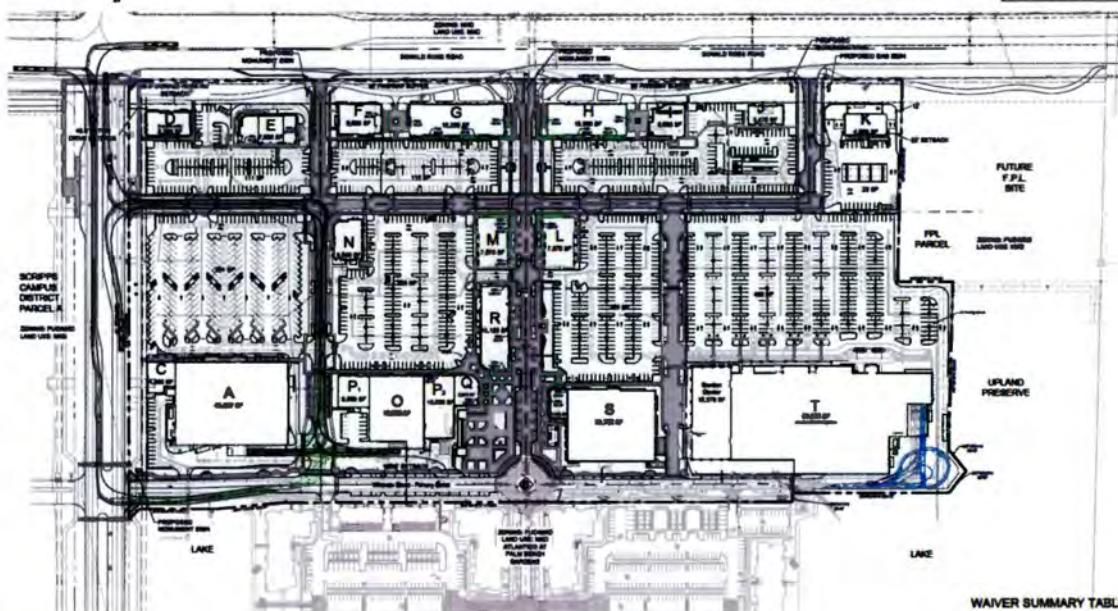

Alton Town Center
Prepared for NADG & Brock Development Group
Palm Beach Gardens, Florida
Phase 1 Site Plan



SP-1
of 5

TOWN CENTER USES

DEVELOPMENT TEAM

1000 1000 1000

DEVELOPMENT TEAM: NORTH AMERICAN DEVELOPMENT GROUP PLANNERS: LINDNER DESIGN/HALVORSON STUDIO ARCHITECT: BLOOM SPARKS PARTNERS



2005 Vista Parkway, Suite 111
West Palm Beach, FL 33411-6700
(561) 296-9698 Fax (561) 684-6336
Certificate of Authorization Number: 7989

July 27, 2016

Mr. Peter Hofheinz
City of Palm Beach Gardens, Planning & Zoning
10500 North Military Trail
Palm Beach Gardens, Florida 33410

**Re: Alton Parcel C, Town Center - #PTC15-002K
SPLN-15-07-000020**

Dear Mr. Hofheinz:

Pinder Troutman Consulting, Inc. (PTC) has completed our review of the referenced project. Specifically, we have reviewed the revised Traffic Impact Statement dated July 20, 2016 prepared by Kimley Horn. The site is within the Alton DRI and is summarized below:

Proposed Uses:	346,403 SF Enclosed Commercial, consisting of: 2,006 SF Fast Food Restaurant/Drive Thru 3,475 SF Drive-In Bank 119,361 SF Home Improvement Superstore 16 F.P. Gas Station with Carwash 221,561 SF Retail And 13,800 SF Outdoor Seating (Calculated as Retail)
-----------------------	---

Site Peak Hour Trips:	393 AM 841 PM
------------------------------	------------------

Based on our review, we have determined that the proposed project is consistent with the Briger DRI and is in compliance with Conditions 34 and 35 of the Development Order. The following Conditions of Approval are recommended:

1. Condition 30.b of Resolution 44, 2013 will be triggered with this Site Plan. Therefore, a surety bond for the traffic signal shall be posted.
2. The Site is limited to 81,756 SF of Restaurant, including Outdoor Seating.
3. An eastbound right turn lane shall be constructed on Donald Ross Road at the Site's eastern driveway.
4. An eastbound right turn lane and a westbound left turn lane shall be constructed on Donald Ross Road at the Site's central driveway (Premier Street.)
5. The northbound exit at the Site's central driveway (Premier Street) to Donald Ross Road shall consist of two continuous lanes (one left turn lane and one thru/right turn lane) all the way from Donald Ross Road to Secondary Street.

Mr. Peter Hofheinz

July 27, 2016

Page 2 of 2

6. An eastbound right turn lane shall be constructed on Donald Ross Road at the Site's western driveway.
7. A northbound right turn lane and a southbound left turn lane shall be constructed on Alton Road at the Site's southern driveway (Primary Street.)
8. A northbound right turn lane shall be constructed on Alton Road at the Site's northern driveway (Secondary Street.) As an alternative, the outside thru lane can be striped as a right turn lane, consistent with the striping north of this driveway.


If you have any questions or comments, please do not hesitate to contact this office.

Sincerely,




Rebecca J. Mulcahy, P.E.
Vice President



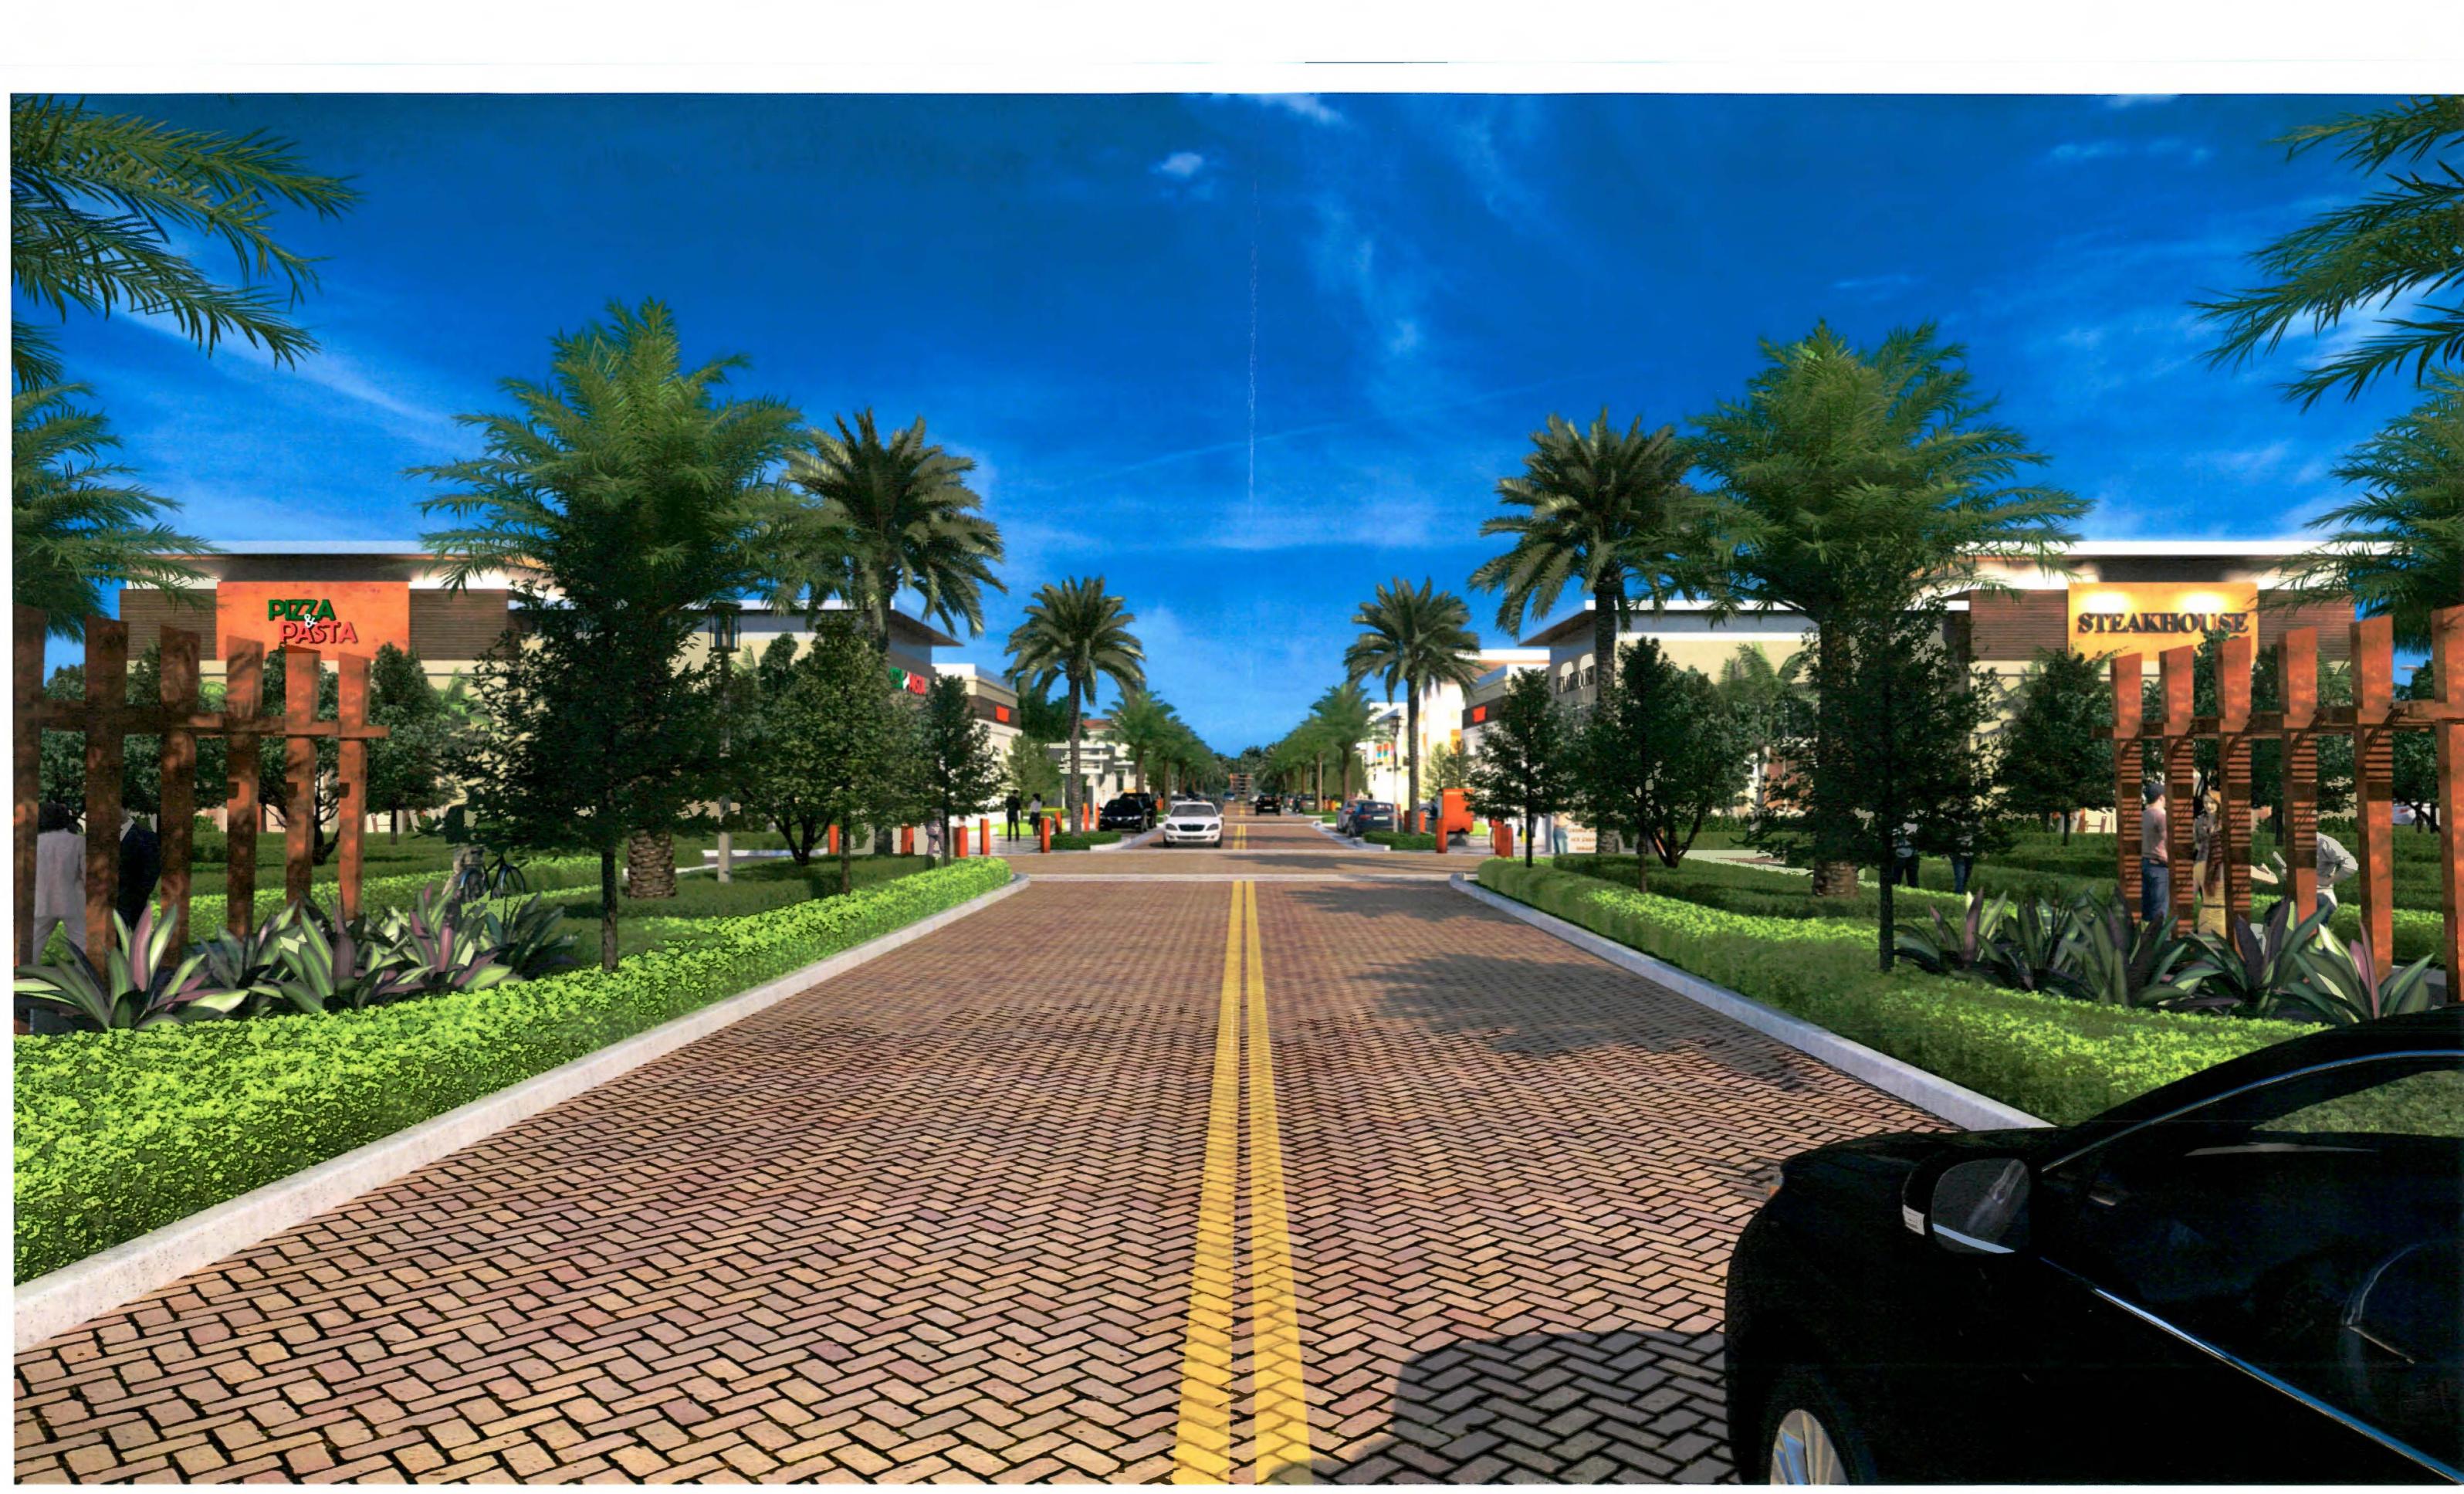





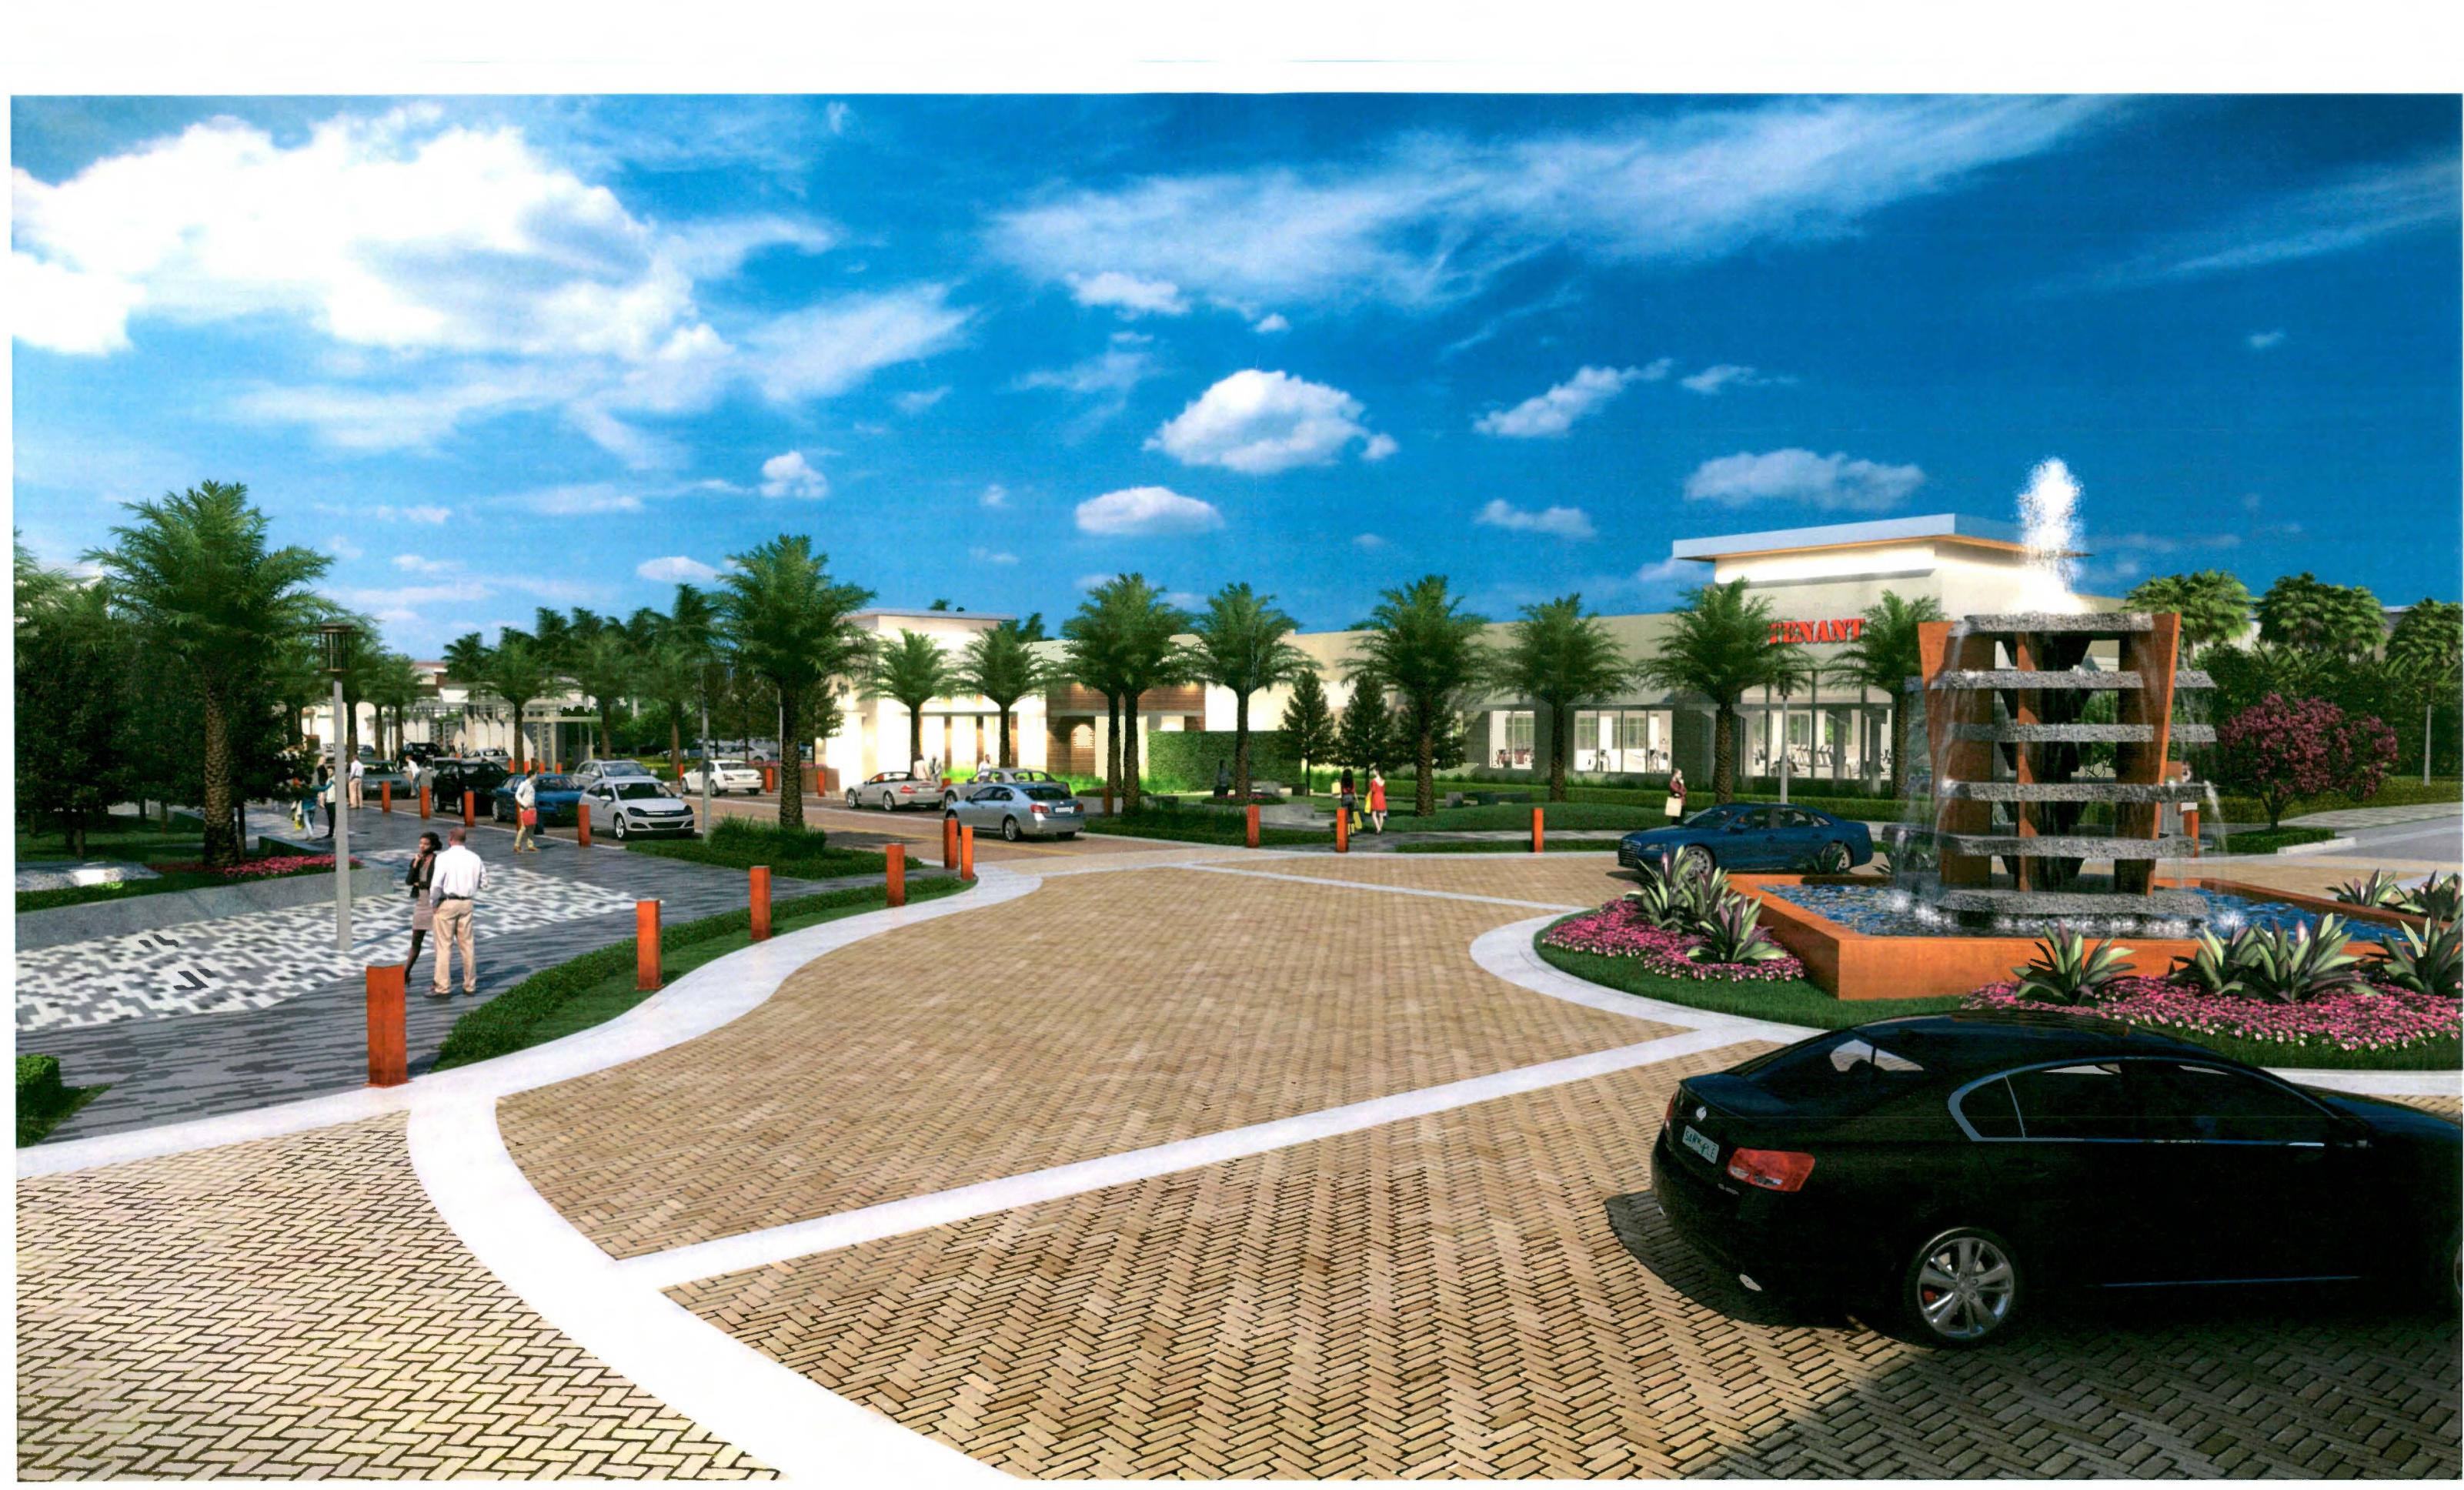



SITE DATA:

PETITION NO: SPLN-15-060020
 PROJECT NAME: ALTON TOWN CENTER
 EXISTING/PROPOSED LAND USE DESIGNATION: MXD/MXD
 EXISTING/PROPOSED ZONING DISTRICT: PCD/MXD
 SECTION/TOWNSHIP/ RANGE: 2641A12
 PCN (S): 52-42-41-26-00-196-3003
 GROSS SITE AREA: 40.80 AC.
 PHASE 1 28.23 AC.
 PHASE 2 12.57 AC.
 PROPOSED USE: TOWN CENTER
 TOTAL BUILDING SQ.FT.: 360,203 SF.
 (Includes 4,392 SF of future retail area
 and 13,800 SF of outdoor seating)
 MAXIMUM RESTAURANT USES: 25% (based on 327,024 of commercial retail)
 61,756 SF (including outdoor seating)
 TOTAL FAB: 0.19
 BUILDING HEIGHT: MAX. 50'
 PROPOSED 37'
 LOT COVERAGE ALLOWED (MAX 35%): 14.28 AC. (622,034.8 SF.)
 LOT COVERAGE PROVIDED: 7.95 AC. 19.4%
 IMPERVIOUS AREA: 83.0% - 33.86 AC.
 PREVIOUS AREA: 17.0% - 6.94 AC.
 TRAFFIC ANALYSIS ZONE (TAZ): 28

PARKING DATA	
SPACES REQUIRED	1,723 SPACES
SPACES PROPOSED (8.8' x 18.8' = 1,480 10' x 18.8' = 1,710 10' x 18.8' = 182) - required	1,678 SPACES
ACCESSIBLE PARKING REQUIRED	27 SP.
PROVIDED	57 SP.
BICYCLE PARKING REQUIRED	83 BIKE SP.
% OF OFF-STREET VEHICULAR SPACES REQUIRED @ 1,664 SP (PER PCD DESIGN GUIDELINES)	15%
BICYCLE PARKING PROVIDED	84 SPACES (20 BIKE RACKS)
LOADING SPACES REQUIRED	6 SPACES (12' X 35')
LOADING SPACES PROVIDED	17 SPACES (12' X 35')
OUTDOOR PATIO AREA	13,800 SF

PROPERTY DEVELOPMENT REGULATIONS:

MXD DISTRICT LOT COVERAGE BUILDING HEIGHT	REQUIRED	PROPOSED
	MAX. 35% MAX. 50' / 4-STORY	15% (7.96 AC - INCLUDES BLDGS & CANPIES) 37'
SETBACKS	REQUIRED	PROPOSED STANDARD
ALTON ROAD	30'	40'
DONALD ROSS ROAD	66'	55'
ADJACENT TO F.P.L. SITE	10'	11'
ADJACENT TO ATLANTICO	30'	126.6'

NOTES:

- BASE INFORMATION BASED ON SURVEY PREPARED BY MICHAEL B SCHORAH & ASSOCIATES, INC. DATED NOVEMBER 2014.
- BUILD TO LINES MAY BE EXPANDED BY 10% TO ACCOMMODATE INFRASTRUCTURE NEEDS AND DESIGN CONSIDERATIONS.
- LANDSCAPING SHALL BE FIELD ADJUSTED TO AVOID CONFLICTS WITH UTILITIES.
- A MINIMUM 15' BUILDING SETBACK WILL BE MAINTAINED FROM SEACOAST LINES.
- ALL STOP BARS SHALL BE SETBACK 4' IN ADVANCE OF PEDESTRIAN CROSSWALKS.
- ALL ACCESSIBLE PAVED ROUTES SHALL NOT EXCEED A 2:1 SLOPE.
- FINAL LOCATIONS OF ALL PROPOSED TRAFFIC SIGNAGE SHALL BE ESTABLISHED BY THE ENGINEER OF RECORD.
- ALL PAVEMENT MARKING AND STRIPING EXCLUDING PARKING STALL STRIPING SHALL BE INSTALLED WITH THERMOPLASTIC MATERIALS PAVER BRICKS OF APPROPRIATE COLOR SHALL BE USED ON PAVER BRICK AREA.
- CURBING DETAILS TO BE SHOWN ON ENGINEERING CONSTRUCTION PLANS.
- SEE ENGINEERING PLANS FOR ROADWAY CROSS SECTIONS.
- SURROUNDING INFORMATION AND PLANS ARE SHOWN FOR INFORMATIONAL PURPOSES ONLY.
- HANDICAP PARKING SIGNS SHALL BE PLACED BEHIND THE SIDEWALK IN AREAS WHERE SIDEWALK ABUTS THE STALL AND OUTSIDE THE TWO AND A HALF (2 1/2') FOOT OVERHANG AREA WHERE WHEEL STOPS ARE NOT PROVIDED.



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Alton Town Center Prepared for NADG & Brock Development Group Palm Beach Gardens, Florida Phase 1 Site Plan

Drawing Name: H:\\C\\Urban\\Town Center\\Site Plan.dwg, Date: 03-20-2014, Scale: 1\"/>



Scale: 0' 50' 100' 200'
 1" = 100'-0"

TOWN CENTER USES

BUILDING A 49,098 SF COMMERCIAL GROCERY & RESTAURANT
 BUILDING C 4,688 SF COMMERCIAL & RESTAURANT
 BUILDING D 6,137 SF COMMERCIAL & RESTAURANT - INCLUDES 1,000 SF OF COVERED PATIO SEATING
 BUILDING E 6,400 SF COMMERCIAL & RESTAURANT
 BUILDING F 7,003 SF COMMERCIAL & RESTAURANT - INCLUDES 1,000 SF OF COVERED PATIO SEATING
 BUILDING G 15,291 SF COMMERCIAL & RESTAURANT
 BUILDING H 12,977 SF COMMERCIAL & RESTAURANT
 BUILDING I 5,800 SF BANK COMMERCIAL & RESTAURANT
 BUILDING J 3,400 SF BANK COMMERCIAL & RESTAURANT
 BUILDING K 4,800 SF GAS SALES, COMMERCIAL & RESTAURANT
 BUILDING L 7,888 SF COMMERCIAL & RESTAURANT
 BUILDING M 7,888 SF COMMERCIAL & RESTAURANT
 BUILDING N 3,883 SF COMMERCIAL & RESTAURANT
 BUILDING O 19,349 SF COMMERCIAL & RESTAURANT
 BUILDING P1 3,319 SF COMMERCIAL & RESTAURANT
 BUILDING P2 3,800 SF COMMERCIAL & RESTAURANT
 BUILDING Q 3,800 SF COMMERCIAL & RESTAURANT
 BUILDING R 13,325 SF COMMERCIAL & RESTAURANT
 BUILDING S 14,430 SF FITNESS CENTER, COMMERCIAL & RESTAURANT
 BUILDING T 16,378 SF HOME IMPROVEMENT
 GARDEN CENTER *NOT INCLUDED IN GSF

UNCOVERED PATIO SEATING (13,800 SF)

Conceptual Distribution

BUILDING	SEATING AREA (SF)
BUILDING A	49,098 SF
BUILDING C	4,688 SF
BUILDING D	6,137 SF
BUILDING E	6,400 SF
BUILDING F	7,003 SF
BUILDING G	15,291 SF
BUILDING H	12,977 SF
BUILDING I	5,800 SF
BUILDING J	3,400 SF
BUILDING K	4,800 SF
BUILDING L	7,888 SF
BUILDING M	7,888 SF
BUILDING N	3,883 SF
BUILDING O	19,349 SF
BUILDING P1	3,319 SF
BUILDING P2	3,800 SF
BUILDING Q	3,800 SF
BUILDING R	13,325 SF
BUILDING S	14,430 SF
BUILDING T	16,378 SF

WAIVER SUMMARY TABLE

Building/Subdivision Section	Required	Proposed	Waiver
1 Primary Street Build-to-Use (Page 5)	82' height up to 84' height with 10% permitted variation	132' feet	46 feet None buildings are provided
2 Primary Street - % of Buildings at Build-to-Use (Page 5)	50%	50%	None
3 Secondary Street - Bicycle Lanes (Page 5)	Not Provided	Bicycle Lane	On-street parking provided on North South streets. Additional street trees provided on East-West streets.
4 On-Street Parking (Page 5)	None	None	None
5 Off-Street Parking (Page 5)	Parking required for minor driving areas	Parking provided within overall waiver	Waiver of 44 spaces

DEVELOPMENT TEAM:

OWNER: BROCK DEVELOPMENT GROUP
 4650 DONALD ROSS RD STE 200
 PALM BEACH GARDENS, FL 33418

NORTH AMERICAN DEVELOPMENT GROUP
 400 CLEMATIS STREET, SUITE 201
 WEST PALM BEACH, FL 33401

PLANNER/ARCHITECT
 URBAN DESIGN KILDAY STUDIOS
 610 CLEMATIS STREET, CU02
 WEST PALM BEACH, FL 33401
 (561) 368-1100

ARCHITECT
 GILDED SPINA & PARTNERS
 207 5TH STREET
 WEST PALM BEACH, FLORIDA 33401
 (561) 684-5844


SURVEYOR
 SCHORAH & ASSOCIATES
 1860 FOREST HILL BLVD, SUITE 205
 WEST PALM BEACH, FLORIDA 33406
 (561) 968-0080

CIVIL/TRAFFIC ENGINEER
 KIMLEY-HORN AND ASSOC.
 1920 WEKIVA WAY, STE 200
 WEST PALM BEACH, FLORIDA 33411
 (561) 840-0825


Date: 03-20-2014
 Project No.: 86-039-020
 Designed By: SCM
 Drawn By: SCM/LMB/KWK
 Checked By: KT
 Revision Dates:
 07-17-2015 (M&R CITY SUBMITTAL)
 02-08-2016 (SCM RESUBMIT)
 04-19-2016 (SCM RESUBMIT)
 06-28-2016 (SCM RESUBMIT)
 07-20-2016 (SCM RESUBMIT)
 09-06-2016 (SCM RESUBMIT)
 08-21-2016 (KWK RESUBMIT)

SP-1
 of 5

KEY MAP

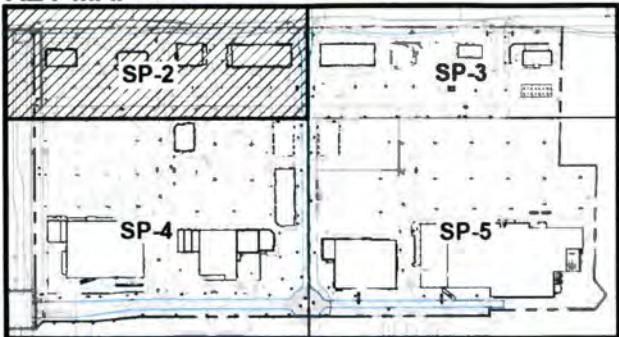

Central Plaza Area Detail

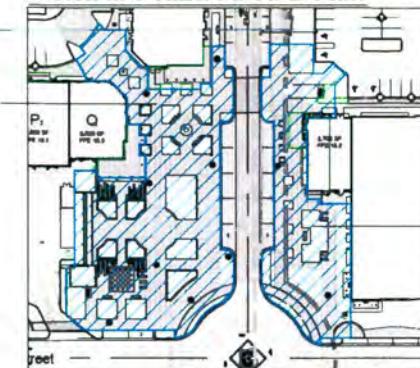

PEDESTRIAN ISLANDS PAVERSTYLE - PLANK HERRINGBONE 4' X 16' & 4' X 12' COLOR - DARK BEIGE MR
PEDESTRIAN ISLANDS PAVERSTYLE - PLANK HERRINGBONE 4' X 12' COLOR - LIGHT GRAY MR
INTERSECTIONS PAVERSTYLE - PLANK HERRINGBONE 4' X 16'
ROADWAYS PAVERSTYLE - PLANK HERRINGBONE 4' X 12' COLOR - MEDIUM GRAY MR
PEDESTRIAN CROSS WALKS PAVERSTYLE - PLANK HERRINGBONE 4' X 12' COLOR - LIGHT BEIGE MR
PARALLEL PARKING PAVERSTYLE - COBBLESTONE 4' X 12'
PARALLEL PARKING PAVERSTYLE - COBBLESTONE 4' X 12' COLOR - DARK BEIGE MR

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Drawing Name: H:\\2D\\2014\\144\\ALTONRD\\144_ALTONRD_SitePlan.dwg




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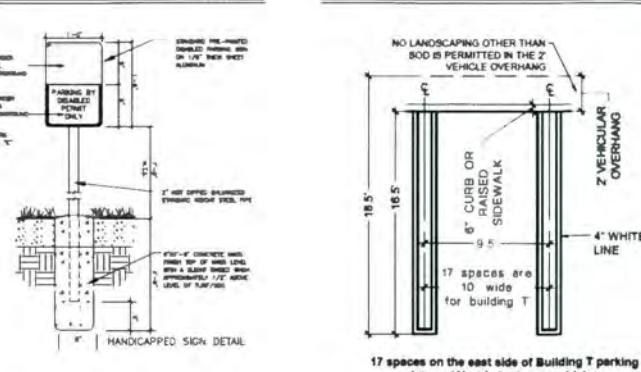
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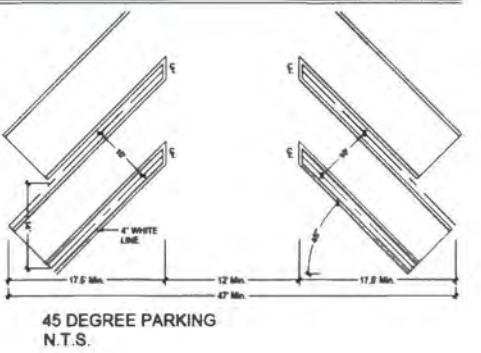
HANDICAP PARKING SPACE DETAIL:



TYPICAL PARKING SPACE DETAIL:

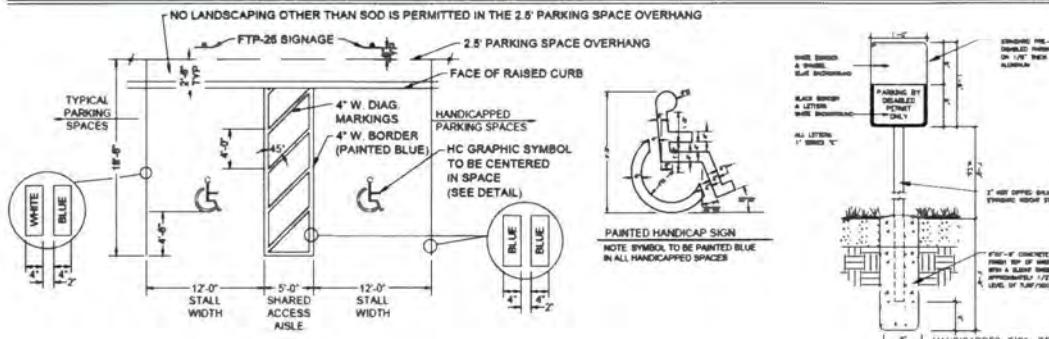

45 DEGREE PARKING SPACE DETAIL:



TYPICAL BENCH DETAIL:



TYPICAL BIKE RACK DETAIL:



SP-2
of 5

Date: 03-20-2014
Project No.: 88-039.020
Designed By: SCM
Drawn By: SCM/LMB/KWK
Checked By: KT

Revision Dates:
07.17.2015 LMB CITY SUBMITTAL
02.08.2016 SCM RESUBMIT
04.19.2016 SCM RESUBMIT
06.28.2016 SCM RESUBMIT
07.20.2016 SCM RESUBMIT
09.08.2016 SCM RESUBMIT
09.21.2016 KWK RESUBMIT

PARC VUE (LANDSCAPE FORMS.COM)
MODEL PARISIAN BACKED WITH ARMS

PARC VUE (LANDSCAPE FORMS.COM)
MODEL - RING

KEY MAP



PAVER LEGEND

	PEDESTRIAN NODES PAVERSTYLE - PLANK COMBINATION 4' X 16' & 4' X 12' COLOR - BEIGE MIX
	PEDESTRIAN SIDEWALKS PAVERSTYLE - PLANK RUNNING BOND 4' X 16' COLOR - LIGHT GRAY MIX
	INTERSECTIONS PAVERSTYLE - PLANK HERRINGBONE 4' X 16' COLOR - MEDIUM BEIGE MIX
	ROADWAYS PAVERSTYLE - PLANK RUNNING BOND 4' X 12' COLOR - MEDIUM GRAY MIX
	PEDESTRIAN CROSS WALKS PAVERSTYLE - PLANK HERRINGBONE 4' X 12' COLOR - LIGHT BEIGE MIX
	PARALLEL PARKING PAVERSTONE - COBBLESTONE 4' X 12' COLOR - DARK GRAY MIX

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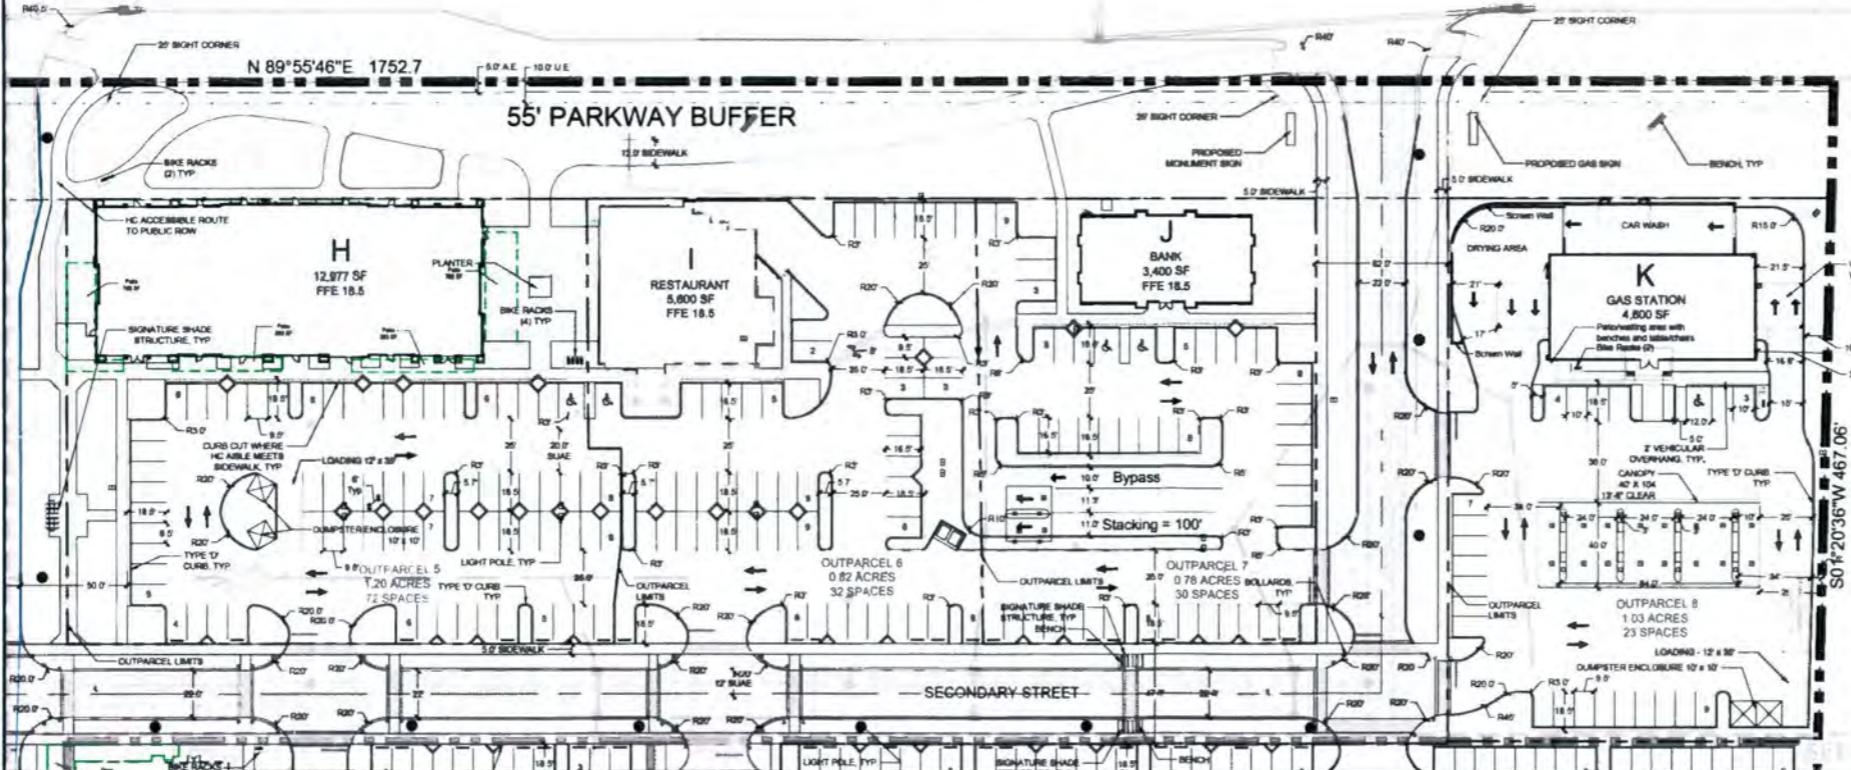
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Drawing date: 03/20/2014 Drawing time: 10:43 AM (EST) Drawing ID: 100-00000000000000000000000000000000




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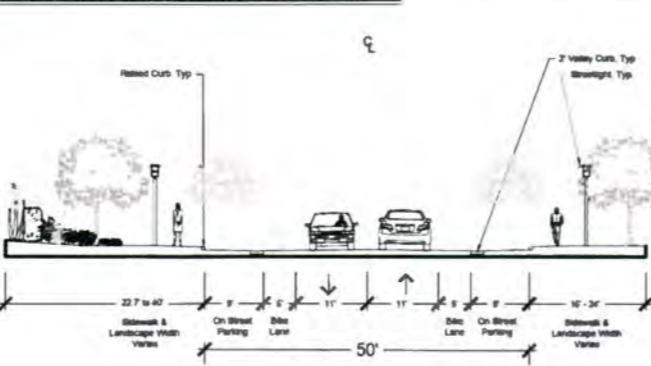
DONALD ROSS ROAD




PREMIER STREET CROSS SECTION

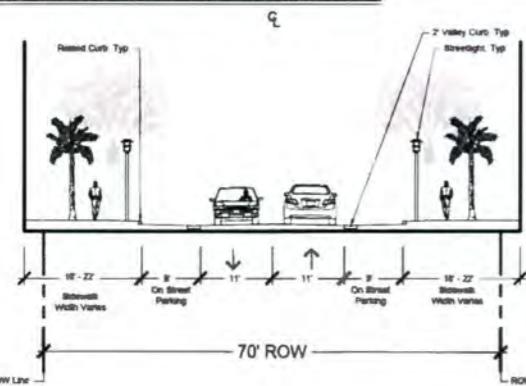


PRIMARY STREET CROSS SECTION



SECONDARY STREET CROSS SECTION

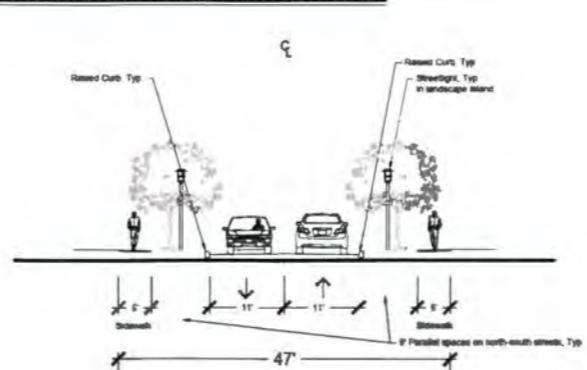

TYPICAL DUMPSTER DETAIL:

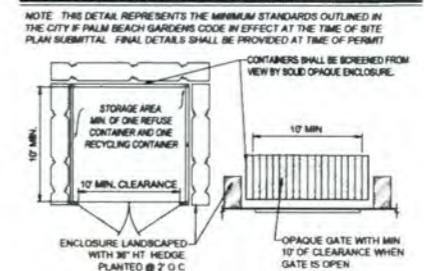


DUMPSTER ENCLOSURE SHALL BE CONSTRUCTED IN THE SAME ARCHITECTURAL STYLE, COLOR AND MATERIAL AS THE PRINCIPLE STRUCTURES.

SP-3
of 5

Date: 03-20-2014
Project No.: 88-039-020
Designed By: SCM
Drawn By: SCM/LMB/KWT
Checked By: KT

Revision Dates:
07-17-2015 LMB CITY SUBMITTAL
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04-19-2016 SCM RESUBMIT
06-28-2016 SCM RESUBMIT
07-20-2016 SCM RESUBMIT
09-06-2016 SCM RESUBMIT
09-21-2016 KWT RESUBMIT

KEY MAP

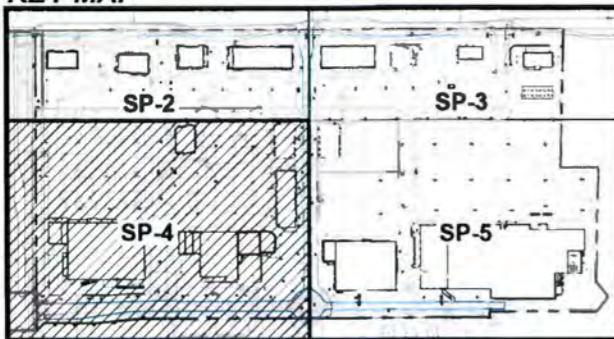

PAVER LEGEND

PEDESTRIAN NODES PAVERSTYLE - PLANK COMBINATION 4" X 36" & 4" X 12" COLOR - BEIGE MUD
PEDESTRIAN BIDWALKS PAVERSTYLE - PLANK RUNNING BOND 4" X 12" COLOR - LIGHT GRAY MUD
INTERSECTIONS PAVERSTYLE - PLANK HERRINGBONE 4" X 12" COLOR - MEDIUM BEIGE MUD
ROADWAYS PAVERSTYLE - PLANK RUNNING BOND 4" X 12" COLOR - MEDIUM GRAY MUD
PEDESTRIAN CROSS WALKS PAVERSTYLE - PLANK HERRINGBONE 2" X 12" COLOR - LIGHT BEIGE MUD
PARALLEL PARKING PAVERSTYLE - CORBELSTONE 4" X 12" COLOR - DARK GRAY MUD

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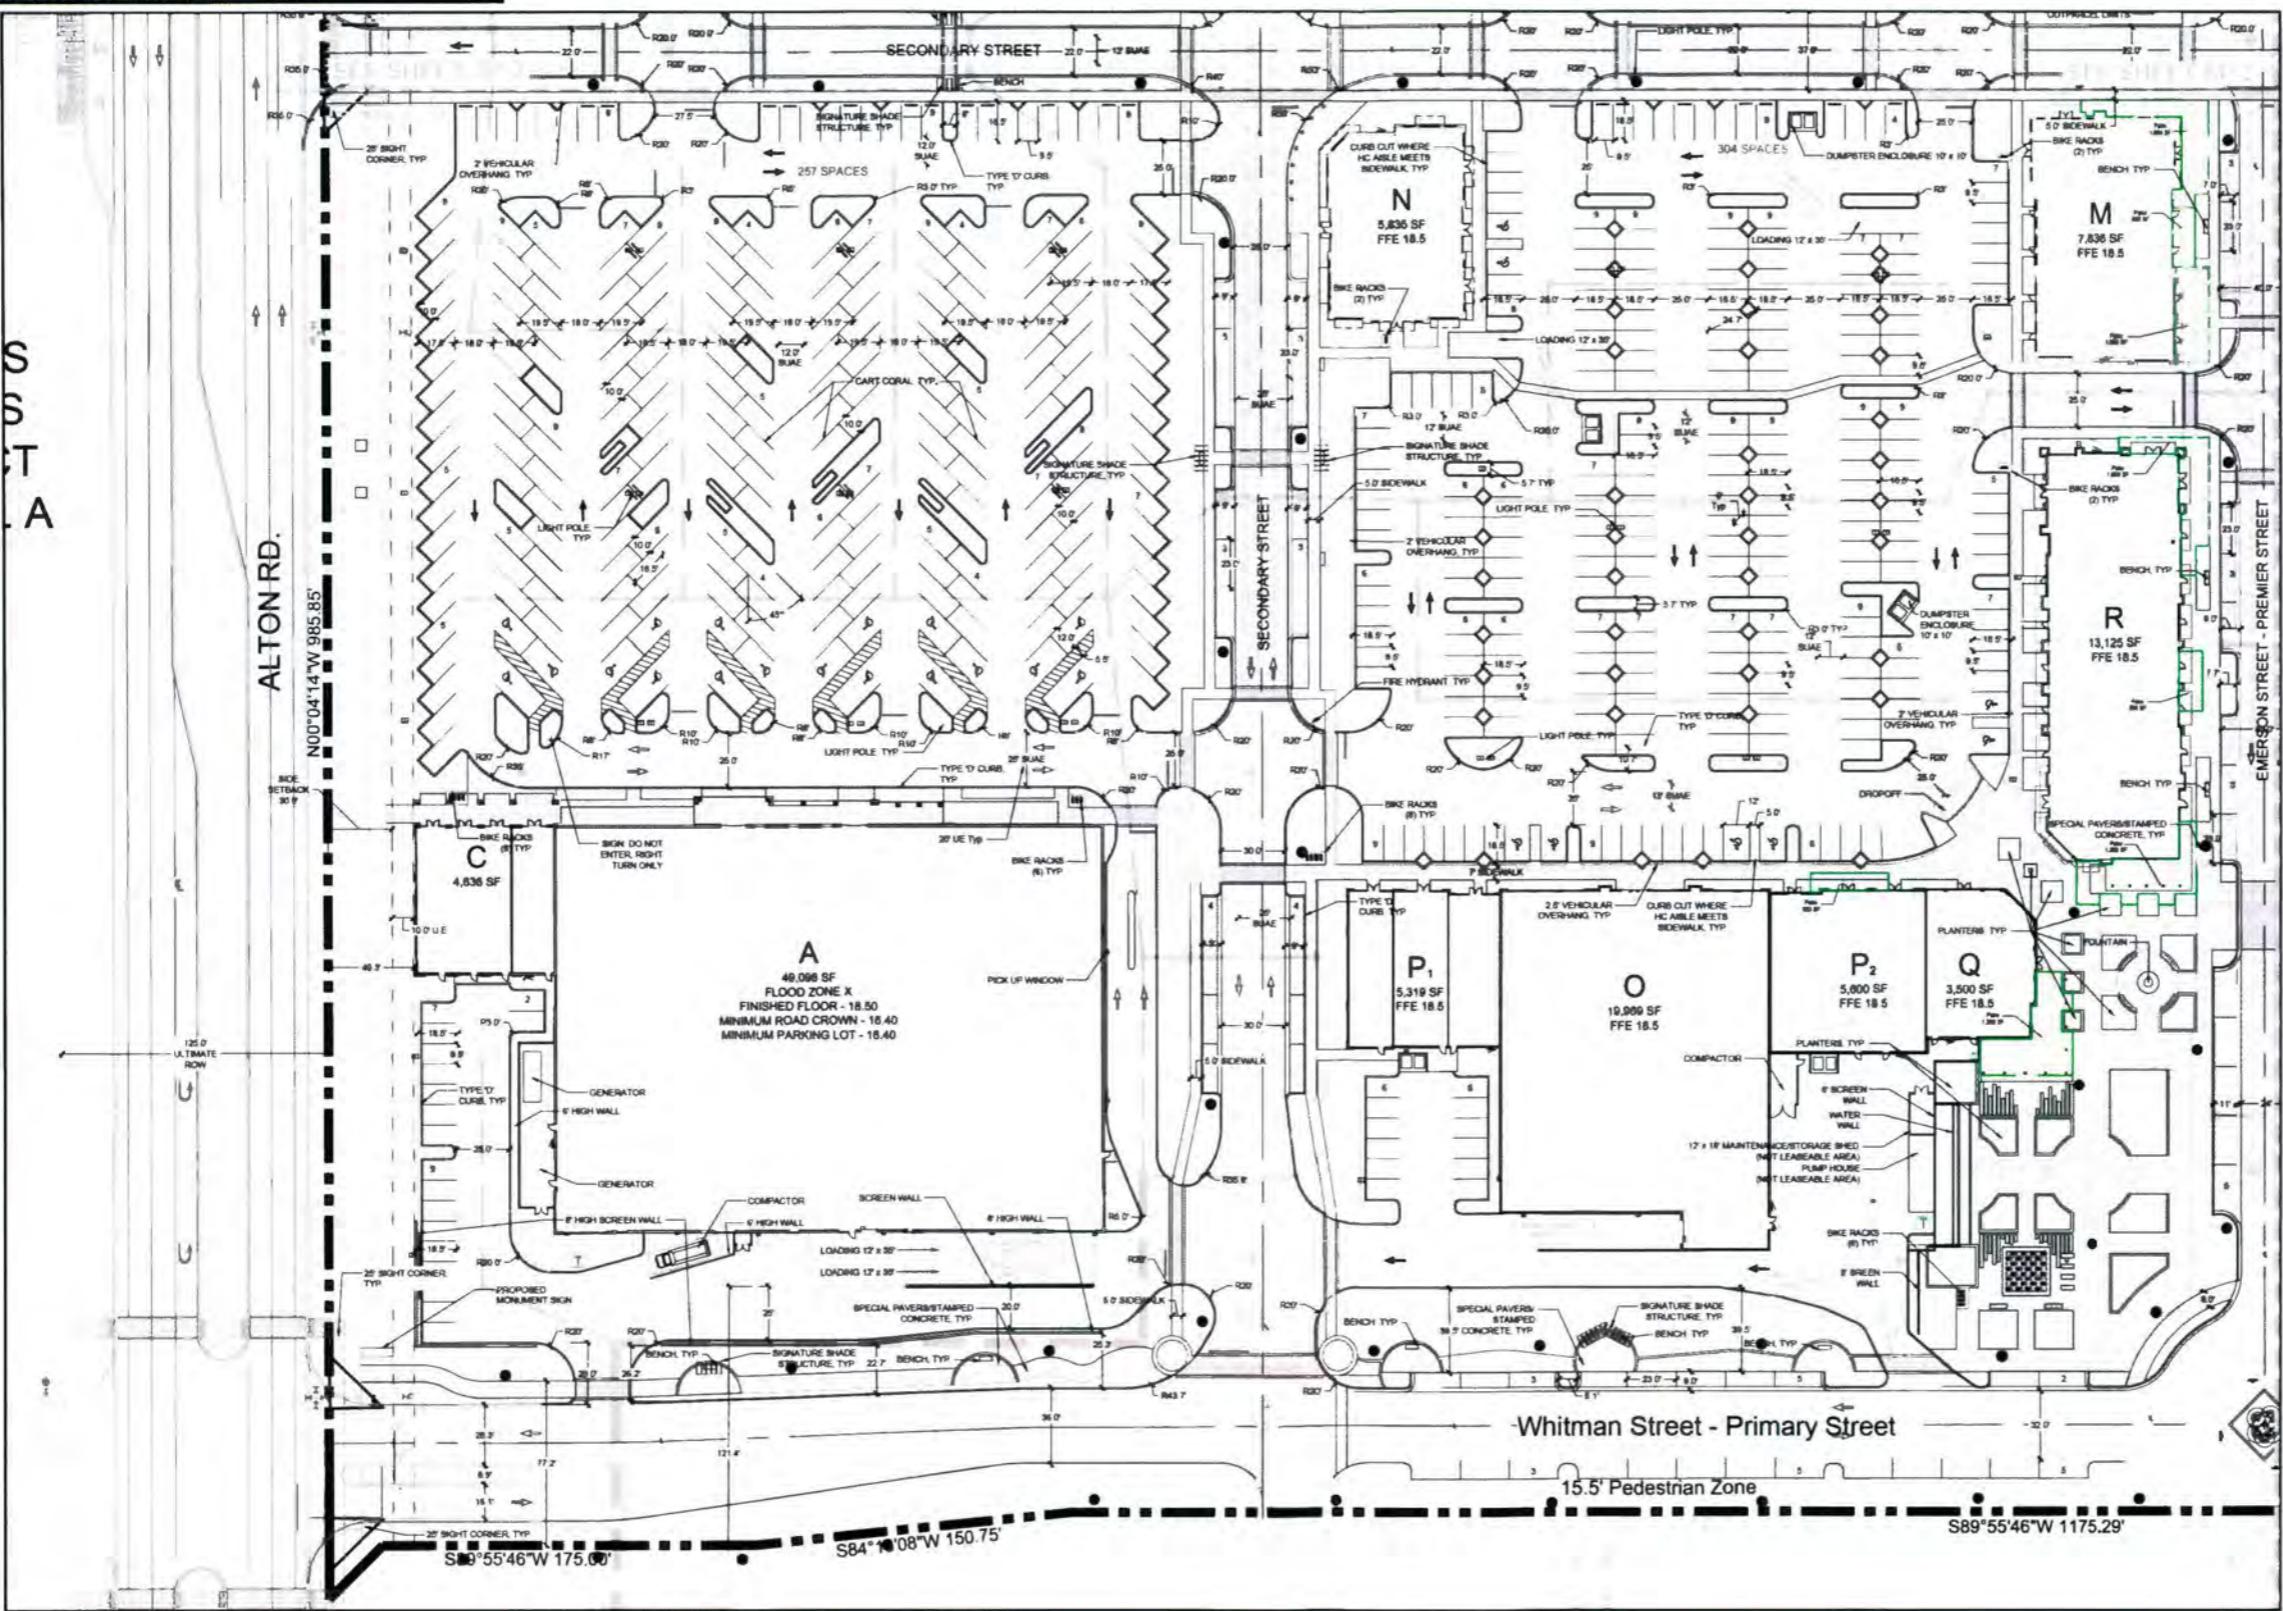


NORTH
0 20' 40' 80'

Scale: 1" = 40'-0"

Date: 03-25-2014
Project No.: 56-039.020
Designed By: SCM
Drawn By: SCM/LMB/KWK
Checked By: KWT
Revision Dates:
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08.08.2016 SCM RESUBMIT
08.21.2016 KWT RESUBMIT

SP-4
of 5




Alton Town Center

Prepared for North American Development Group
The City of Palm Beach Gardens, Florida

INDEX OF SHEETS

- LP-C: Plant List and Calculations
- LP-1: Overall Landscape Plan
- LP-2 - LP-13: Landscape Plan
- LP-14: Planting Details
- LP-15: Landscape Specifications

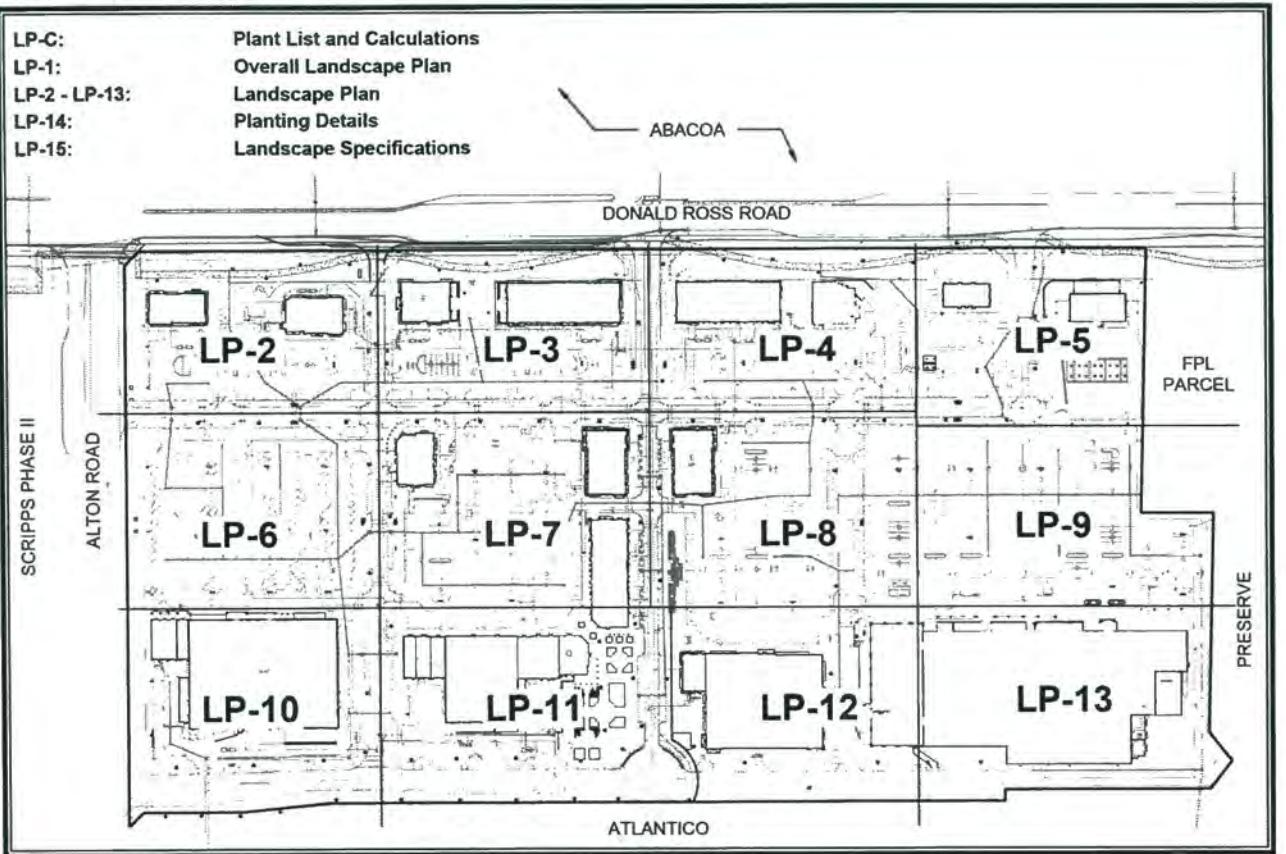

ALTON PCD LOCATION MAP



NOTE:
ALL LANDSCAPE AREAS SHALL BE IRRIGATED TO PROVIDE 100% COVERAGE, INCLUDE A RAIN SENSOR AND BE INSTALLED IN ACCORDANCE WITH SECTION 78-305 (c) (7) k AND SECTION 78-329 (c).

SITE AREA CALCULATIONS:

TOTAL SITE AREA 40.80 AC. / 1,777,348 SF

IMPERVIOUS AREA: 33.66 AC. / 1,474,945.8794 SF 83%

PERVIOUS AREA: 6.94 AC. / 302,516.8438 SF 17%

LANDSCAPE AREA: 5.91 AC. / 257,518.6505 SF 14.49%

SOD AREA: 1.03 AC. / 44,797.0655 SF 14.84%

6' PEDESTRIAN SIDEWALK/PLAZA 2.70 AC. / 117,612.0 SF 6.61%

TOTAL OPEN SPACE 8.61 AC. / 375,051.8 SF 21.1%

LANDSCAPE POINTS

REQUIRED
18 POINTS PER 100 SF OF PERVIOUS AREA

302,516.8436 SF OF PERVIOUS AREA / 100 X 18 = 54,453.24 POINTS

PROVIDED

TREES 13,062.0 POINTS

PALMS 11,619.0 POINTS

SHRUBS 51,404.0 POINTS

GROUND COVERS 8,435.3 POINTS


TOTAL: 84,540.3 POINTS

10/26/16
Nicholas A. Mihelich


PLANT SCHEDULE

TREES	CODE	QTY	BOTANICAL NAME / COMMON NAME	REMARKS	PREFERRED PLANT spp	POINTS PER PLANT	TOTAL POINTS
	BS1	1	Bursera simaruba / Burmese Limebo	Min. 12' Ht. x 5' Sp. 2.5' Cal. Single Straight Trunk, Full Canopy	Y	15	915
	CB1	33	Catolophium brasiliense / Brazilian Beautyleaf	Min. 12' Ht. x 6' Sp. 2.5' Cal. Single Straight Trunk, Full Canopy	Y	15	495
	CG1	128	Conocarpus erectus / Green Buttonwood	Min. 12' Ht. x 5' Sp. 2.5' Cal. Single Straight Trunk, Full Canopy	Y	15	1,800
	CE1	80	Gommacebus strobiliferus / Silver Butterwood	Min. 12'-14' Ht. x 5' Sp. 2.5' Cal. Single Straight Trunk, Full Canopy	Y	15	1,200
	CF1	296	Elaeocarpus decipiens / Japanese Blueberry Tree	Min. 12' Ht. x 5' Sp. 2.5' Cal. Total Multi-Trunk, Full dense canopy	N	5	1,180
	FC1	31	Fixa cassia / Dahoon Holly	Min. 12' Ht. x 5' Sp. 2' Cal. Florida #1. Single Trunks, Full canopy	Y	17	527
	LT1	26	Lagerstroemia x / Tulbaghia / Tulbaghia Crapemyrtle	Min. 12' Ht. x 5' Sp. 2.5' Cal. Total Multi-Trunk, Full Canopy	Y	15	385
	LJ1	115	Ligustrum japonicum / Japanese Privet Tree	Min. 6' Ht. x 5' Sp. 2.5' Cal. Total Multi-Trunk, Full Canopy	Y	15	1,725
	MC1	28	Mimosa caesalpiniifolia / Wax Myrtle	Min. 30 Gal. 8' Ht. x 6' Sp. Florida #1. Full to base, Multi-trunk	Y	5	140
	PO1	16	Pinus strobus / Eastern / South Florida Bass Pine	Min. 14'-16' Ht. x 5' Sp. 2.5' Cal. Wire Balled, Florida #1. Full canopy, Equal occurrences at 14', 16' & 17' Ht.	Y	15	1,258
	QV1	56	Quercus virginiana / Live Oak	Min. 10' Ht. x 6' Sp. 4' Cal. Single Straight Trunk, Full and Even Canopy, No Live Cutch	Y	15	1,258
	QV2	43	Quercus virginiana / Board Walk / Boardwalk Live Oak	Min. 22' Ht. x 14' Sp. 4' Cal. 848. Florida Fancy Straight Trunks, Full canopy, Matched Hts., RPP. Single Source Spec: High Branch Tree Farm™	Y	30	2,190
TOTAL = 82%							
PALM TREES							
	AM1	77	Adonidia merillii / Christmas Palm	Min. 8' Cal. Triple Trunk, Full Head, No Scars	N	7.5	582.5
	BN1	3	Brahea nitida / Silver Stucco Palm	Min. 10' Cal. 12' Cal., 848. Florida Fancy Full Crown, Matched	Y	3.5	9.5
	CM1	16	Caryota urens / Foster Palm	Min. 12' Cal. 16' O.A. Ht. Single Trunk, Full Head, No Scarred Trunk	N	1.8	28.8
	DN1	82	Phoenix dactylifera / Medjool / Medjool Date Palm	Min. 20' CH measure from base of tree, 848. Florida Fancy, Class cut, Full crown, Matched Height, No Scarred Trunk	Y	5.5	455.5
	PS1	61	Phoenix sylvestris / Wild Date Palm	Min. 15' Cal. 20' O.A. Ht. Single Trunk, Diamond Cut, Full Head, No Scarred Trunk	Y	10.5	628.5
	WE1	11	Roxburya edulis / Florida Royal Palm	Min. 20' CH. 28' O.A. Ht. Min. 5 Hands, Single Trunk, Full Head, No Scarred Trunk	Y	55.5	3,571.5
	WP1	186	Washingtonia / Cabbage Palm	Min. 15' CH. 28' O.A. Ht. Hurricane cut	Y	15	2,415
	ZM1	336	Washingtonia robusta / Montgomery Palm	Min. 22' CH. 28' O.A. Ht. Triple Trunk, Full Head, No Scarred Trunk	Y	17.5	4,682.4
TOTAL = 75%							
SHRUBS							
	CAU1	131	Crinum asiaticum / Queen Emma / Queen's Crinum	Min. 7' Gal. 24' Ht. x 24' Sp. Full and Even foliage, No Scars, Foliage, Deciduous Tree, 1 plant per pot.	Y	1	105
	DPF1	429	Dysoxylum lanceum / Arica Palm	Min. 10' Ht. x 6' Sp. 24' Cal. Full and Dense Shrub, Full to Base	N	3	1,267
	FCR1	402	Ficus repens / Creeping Fig	Min. 3 Gal. 15' O.C.	N	1	402
	POD1	416	Foddyceps macrophylla / Podocarpus	Min. 3 Gal. 24' Ht. x 24' Sp. 24' O.C. Full and Dense Shrub, Full to Base	Y	1	418
	THG1	51	Thunbergia grandiflora / Star Vines	Min. 7' Gal. 24' O.C.	Y	1	51
	JAC1	32	Trachelospermum jasminoides / Confederate Jasmine	Min. 3 Gal. 24' O.C.	Y	1	32
SHRUB AREAS							
	ALC1	1,865	Aleuroplatus cordata / Compacta / Dwarf Aleuroplatus	Min. 3 Gal. 18' Ht. x 18' Sp. 14' O.C. Full and Dense Shrub, Full to Base	Y	1	1,865
	CH1	3,696	Chrysobalanus icaco / Red Tip / Red Tip Cocoplum	Min. 7' Gal. 24' Ht. x 24' Sp. 24' O.C. Full and Dense Shrub, Full to Base	Y	1	3,696
	CLU1	1,744	Chusquea quila / Dwarf Clusa	Min. 7' Gal. 24' Ht. x 24' Sp. 24' O.C. Full and Dense Shrub, Full to Base	Y	1	1,744
	CLU2	1,499	Chusquea quila / Dwarf Clusa	Min. 10' Gal. 18' Ht. x 12' Sp. 30' O.C. Full and Dense Shrub, Full to Base	Y	1	1,499
	CM1	286	Cordyline variegata / Monstera / Monstera	Min. 2' Gal. 24' Ht. x 24' Sp. 24' O.C. Full and Dense Shrub, Full to Base	Y	1	286
	CM2	45	Euterpe edulis / Brazilian Reed Grass	Min. 1' Gal. 18' Ht. x 12' Sp. 30' O.C. Full and Dense Shrub, Full to Edge of Pot	N	5	45
	TC1	13,997	Ficus microcarpa / Green Island / Green Island Ficus	Min. 3' Gal. 12' Ht. x 12' Sp. 34' O.C. Full and Dense Shrub, Full to Base	N	1	13,997
	TM1	1,906	Hamelia nummularia / Dwarf Firecracker	Min. 3' Gal. 18' Ht. x 18' Sp. 34' O.C. Full and Dense Shrub, Full to Base	Y	1	1,906
	JAS1	1,821	Jasminum sambac / White Jasmine	Min. 3' Gal. 18' Ht. x 18' Sp. 24' O.C. Full and Dense Shrub, Full to Base	Y	1	1,821
	JUN1	104	Juniperus chinensis / Pendula / Parsons Juniper	Min. 3' Gal. 18' Ht. x 12' Sp. 24' O.C. Full and Dense Shrub, Full to Base	Y	1	104
	MUN1	779	Muhlenbergia capillaris / Pink Muhy Grass	Min. 3' Gal. 24' Ht. x 24' Sp. 24' O.C. Full and Dense Shrub, Full to Edge of Pot	Y	1	779
	POD2	7,277	Podocarpus macrophylla / Podocarpus	Min. 7' Gal. 24' Ht. x 24' Sp. 24' O.C. Full and Dense Shrub, Full to Base	Y	1	7,277
	POD3	1,256	Podocarpus macrophylla / Podocarpus	Min. 15' Gal. 30' Ht. x 24' Sp. 24' O.C. Full and Dense Shrub, Full to Base	Y	1	1,256
	POD4	261	Podocarpus macrophylla / Crested / Crested / Crested	Min. 3' Gal. 14' Ht. x 12' Sp. 18' O.C. Full and Dense Shrub, Full to Base	Y	1	261
	RHA1	310	Rhaphisera indica / Nira / White Indian Hawthorn	Min. 3' Gal. 18' Ht. x 18' Sp. 24' O.C. Full and Dense Shrub, Full to Base	Y	1	310
	SAT1	2,983	Scaevola australis / Tissue / Variegated Scaevola	Min. 3' Gal. 18' Ht. x 18' Sp. 24' O.C. Full and Dense Shrub, Full to Base	Y	1	2,983
	SPN1	5,098	Spiraea japonica / Sand Gold Grass	Min. 3' Gal. 24' Ht. x 24' Sp. 24' O.C. Full and Dense Shrub, Full to Edge of Pot	Y	1	5,098
	TRI1	1,518	Trachelosperma / Crested / Variegated Grass	Min. 1' Gal. 20' Ht. x 18' Sp. 24' O.C. Full and Dense Shrub, Full to Base	Y	1	1,518
	VB1	499	Vaccinium ovalifolium / Dwarf / Walter's Vaccinium	Min. 3' Gal. 24' Ht. x 24' Sp. 24' O.C. Full and Dense Shrub, Full to Base	Y	1	499
	ZAM1	729	Zamia pumila / Coontie	Min. 3' Gal. 12' Ht. x 12' Sp. 24' O.C. Full Foliage, Two Stems	Y	1	729
TOTAL = 5146							
GROUND COVERS							
	ANN1	4,221	Annuals / Annuals	Seasonal Cover, Min. 6' Ht. x Min. 6' Sp. Deciduous Foliage, Non-deciduous	N	0.5	2,110.5
	CEL1	20,283	Cynodon dactylon / Common / Common Bermudagrass	Stolon, Lat. light, Staggered rows, Weeds & Disease Free, Rooted & Standard to Lever Lawn	N	0.25	5,068.25
	SOI1	40,587	Stenotaphrum secundatum / Florida / St. Augustine Sod	Rooted and Standard to Lever Lawn	Y	0.25	10,145.85
	MHI1	9,807	Trachelospermum zebrina / Mexican Jasmine	Florida #1, Min. 4' Ht. x Min. 17' Sp. Min. 5' Jeep. Fully rooted & dense, Match w/ pine bark trees	Y	0.5	4,903.5
	REP1	5,595	Turf Soil Replica / Replica Turf		N/A	0.0	0.0
TOTAL = 8435.1							
TOTAL PROJECT PREFERRED PLANTS: 8435.1							
TOTAL PROJECT POINTS: 84,540.3							

DONALD ROSS ROAD

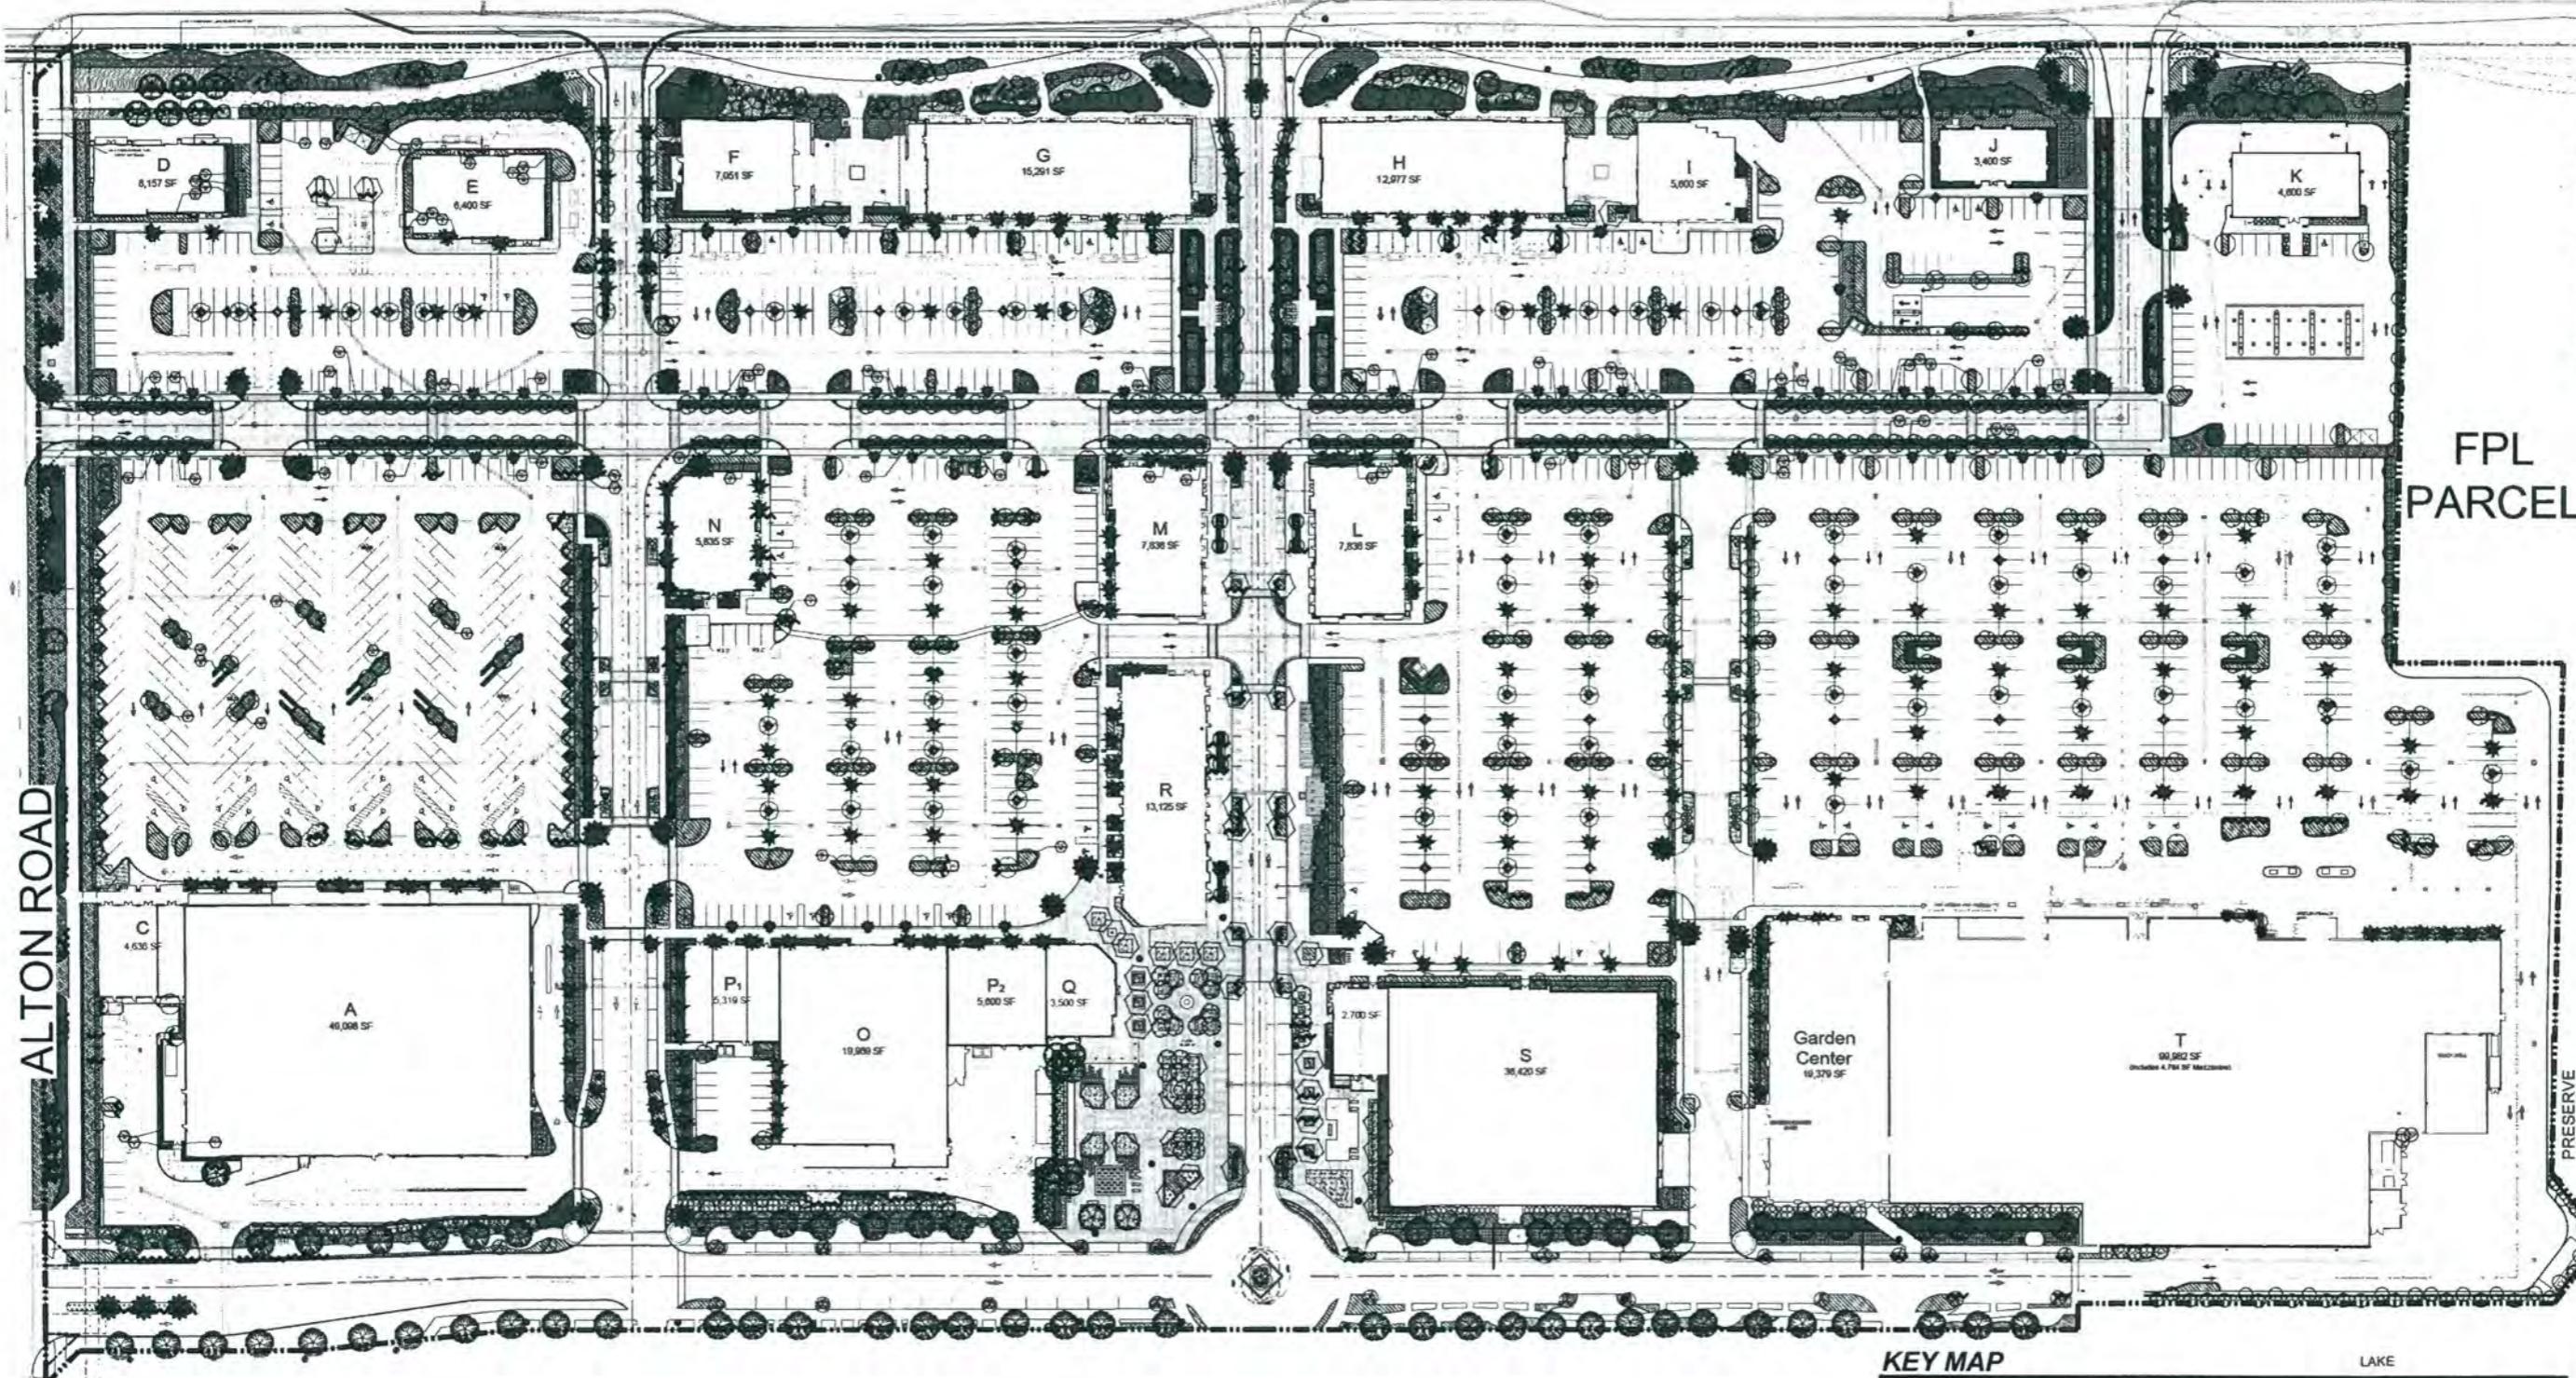

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Alton Town Center
Prepared for NADG & Brock Development Group
Palm Beach Gardens, Florida
Landscape Plan

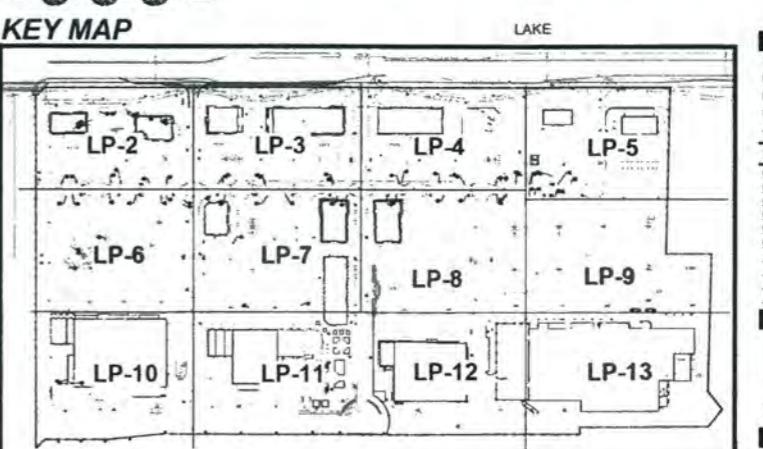Drawing name: 110201@b777-1.dwg, Date: 07-10-2015, Author: LMB/KWK, Project: 110201, LP: Any



NORTH

0 30° 60° 120°

Scale: 1" = 60'-0"

Date: 07-10-2015

Project No.: 88-039-020

Designed By: NM


Drawn By: LMB/KWK

Checked By: NM

Revision Dates:

07.12.2015: LMB CITY SUBMITTAL
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09.05.2016: KWK CITY RE-SUBMITTAL

KEY MAP

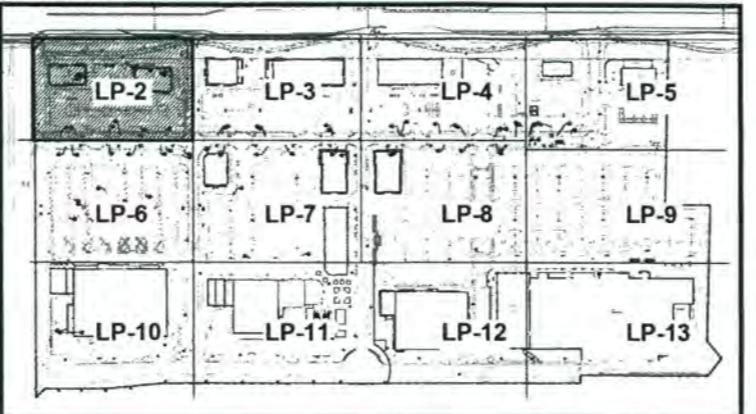

PAVER LEGEND

	PEDESTRIAN NODES PAVERSTYLE - PLANK HERRINGBONE 4' x 12' COLOR - BEIGE MIX
	PEDESTRIAN BERM/VALLEY PAVERSTYLE - PLANK RUNNING BOND 4' x 12' COLOR - LIGHT GRAY MIX
	INTERSECTIONS PAVERSTYLE - PLANK HERRINGBONE 4' x 12' COLOR - MEDIUM BEIGE MIX
	Roadways PAVERSTYLE - PLANK RUNNING BOND 4' x 12' COLOR - MEDIUM GRAY MIX
	PEDESTRIAN CROSS WALKS PAVERSTYLE - PLANK HERRINGBONE 4' x 12' COLOR - LIGHT BEIGE MIX
	PARALLEL PARKING PAVERSTYLE - CORBLESTONE 4' x 12' COLOR - DARK GRAY MIX

PLANT LIST

PLANT	CODE	GT#	BOTANICAL NAME / COMMON NAME
	BS	81	Bombax ceiba / Ceiba Tree Min. 12' Ht. x 5' Sp. 2.5" Cg. Single Straight Trunk, Full Canopy
	CB	13	Caldyphorus brasiliensis / Brazilian Butternut Min. 12' Ht. x 5' Sp. 2.5" Cg. Single Straight Trunk, Full Canopy
	CG	128	Conocarpus erectus / Green Buttonwood Min. 12' Ht. x 5' Sp. 2.5" Cg. Single Straight Trunk, Full Canopy
	CE	60	Crotonopsis sinuata ssp. / Silver Buttercup Min. 12' Ht. x 5' Sp. 2.5" Cg. Single Straight Trunk, Full Canopy
	CD	238	Dioscorea elephantipes / Japanese Yam Min. 12'-14' Ht. x 5' Sp. 2' Cg. 5' clear trunk, Florida Fancy, straight trunks, Full dense canopy
	CF	1	Elaeis guineensis / African Oil Palm Min. 12' Ht. 5' Sp. 2' Cg. Florida #1, Straight Trunk, Full canopy
	CG	17	Lippia ligustrina / Mexican Lime Min. 12' Ht. x 5' Sp. 2.5" Cg. Total Multi-Trunk, Full Canopy
	CL	115	Liquidambar styraciflua / Japanese Sweetgum Min. 8' Ht. x 5' Sp. 1.5" Cg. Total, Multi-Trunk, Full Canopy
	MC	26	Mitchella repens / Sweet Bells Min. 30 Gal. 6' Ht. x 5' Sp. Florida #1, Full to none, Multi-trunk
	PD	95	Pithecellobium dulce / South Florida Bean Tree Min. 12' Ht. x 5' Sp. 3.5" Cg. White Bean Tree, Florida #1, Full canopy, Equally spreading at 14', 18' & 21', Very heights in clusters
	PV	63	Quercus imbricaria / Live Oak Min. 12' Ht. x 5' Sp. 2' Cg. Single Straight Trunk, Full and Even Canopy, No Live Crocs
	QY2	43	Quercus virginiana / Shingle Oak Min. 12' Ht. x 5' Sp. 2' Cg. Barri, Florida Fancy, Straight trunk, Full canopy, Matched Trunks, I.P.O., Single Source Spec.
PALM TREES			
	AM	17	Adonidia malaccensis / Christmas Palm Min. 8' CL, Triple Trunk, Full Head, No Scared Trunk
	BN	3	Brahea nitida / Silver Bechtel Palm Min. 10' CL x 12' Cg. BBB, Florida Fancy, Full Crown, Matched
	CM	18	Canavalia rosea / French Petticoat Palm Min. 12' CL x 18' Cg. Single Trunk, Full Head, No Scared Trunk
	PH	52	Phoenix sylvestris / Medjool / Medina Date Palm Min. 20' CL measure from base of root, BBB, Florida Fancy, Curved, Full crown, Matched heights, No Scared Trunk, Bran Trunk Spec.
	PS	61	Phoenix roebelenii / White Date Palm Min. 10' CL x 12' Cg. Single Trunk, Diamond Cut, Full Head, No Scared Trunk, I.P.O.
	RE	77	Ripogonum scandens / Royal Rattan Palm Min. 20' CL x 20' Cg. Min. 3 Friends, Single Trunk, Full Head, No Scared Trunk
	SP	166	Sabal parviflora / Caribbean Parrottail Min. 15'-22' CL x 6' Sp. Florida #1, Hurricane cut
	TM	236	Trachycarpus monostachya / Montgomery Palm Min. 22' CL x 26' Cg. 4' Ht. Triple Trunk, Full Head, No Scared Trunk
SHRUBS			
	CAZ	177	Calicotome spinosa / Queen's Spear / Queen's Embrace Min. 7' Diam. x 24' Sp. 3.5" Cg. Full and Dense Shrub, Flat to Base
	CPB	128	Choisya tenuifolia / Orange Thyme Min. 7' Diam. x 24' Sp. 3.5" Cg. Full and Dense Shrub, Flat to Base
	FOR	422	Forsythia suspensa / Chinese Fing. Min. 3 Gal. 15' Ht.
	FOO	418	Fragaria ananassa / Pineapple Plant Min. 7' Gal. x 24' Sp. 3.5" Cg. Full and Dense Shrub, Flat to Base
	THG	1	Thunbergia grandiflora / Sky-Flame Min. 7' Gal. x 24' Cg.
	JAC	32	Tschimgania pentandra / Confederate Jasmine Min. 3 Gal. 12' Cg.
SHRUB AREAS			
	ALC	1,695	Aleurolobus carolinianus compacta / Dwarf Aleurolobus Min. 3 Gal. 18' Ht. x 18' Sp. 18" Cg. C. Full and Dense Shrub, Flat to Base
	CAR	7,856	Hippocratea salsoloides / Sweet Rose Top Coquuccio Min. 7 Gal. 24' Ht. x 24' Sp. 3.5" Cg. Full and Dense Shrub, Flat to Base
	COLU	1,744	Nekemias arborea / Carpet Crease Min. 7 Gal. 24' Ht. x 24' Sp. 3.5" Cg. Full and Dense Shrub, Flat to Base
	CLU/2	1,499	Clusia schiediana manu / Dwarf Clusia Min. 7 Gal. 18' Ht. x 18' Sp. 18" Cg. Full and Dense Shrub, Flat to Base
	CIV	3,606	Cordia intermedia / Marmamey / Marmamey Choco Min. 3 Gal. 24' Ht. x 24' Sp. 3.5" Cg. Full and Dense Shrub, Flat to Base
	EGH	1,421	Elaeagnus pungens / Honeycomb Rose Min. 1 Gal. 18' Ht. x 12' Sp. 18" Cg. Full and Dense Shrub, Flat to Edge of Pit
	ELA	13,967	Elaeagnus angustifolia / Green Island Rose Min. 3 Gal. 12' Ht. x 12' Sp. 34" Cg. Full and Dense Shrub, Flat to Edge
	JAM	3,300	Malvastrum coccineum / Devil's Poinsettia Min. 3 Gal. 18' Ht. x 18' Sp. 18" Cg. Full and Dense Shrub, Flat to Base
	JAS	1,421	Jasminum sambac / White Jasmin Min. 10' Gal. 18' Ht. x 14' Sp. 2' Cg. Full and Dense Shrub, Flat to Edge
	JUN	154	Juglans oliverae / Persian / Persian Jujube Min. 3 Gal. 12' Ht. x 28' Sp. 24" Cg. Full and Dense Shrub, Flat to Base
	MUL	7,159	Muhlenbergia capillaris / Fine Muhy Grass Min. 3 Gal. 24' Ht. x 24' Sp. 24" Cg. Full and Dense Shrub, Flat to Edge of Pit
	PODZ	1,377	Podocarpus neriifolia / Podocarpus Min. 7 Gal. 24' Ht. x 24' Sp. 24" Cg. Full and Dense Shrub, Flat to Base
	POZ	1,230	Photinia niitakayamensis / Photocarpus Min. 7 Gal. 36' Ht. x 28' Sp. 24" Cg. Full and Dense Shrub, Flat to Base
	POZ	303	Photinia niitakayamensis / Dwarf Photocarpus Min. 7 Gal. 18' Ht. x 12' Sp. 24" Cg. Full and Dense Shrub, Flat to Edge of Pit
	PSA	5,090	Psidium guajava / Brazil Guava Min. 3 Gal. 24' Ht. x 24' Sp. 24" Cg. Full and Dense Shrub, Flat to Edge of Pit
	TRI	3,516	Triplaris berteroana / Dwarf Triplaris / Triplaris Min. 3 Gal. 18' Ht. x 18' Sp. 24" Cg. Full and Dense Shrub, Flat to Base
	TRI	3,516	Triplaris berteroana / Dwarf Triplaris / Triplaris Min. 3 Gal. 18' Ht. x 18' Sp. 24" Cg. Full and Dense Shrub, Flat to Base
	VIB	465	Viburnum odoratissimum / Denies / Walker's Viburnum Min. 12' Gal. 24' Ht. x 24' Sp. 24" Cg. Full and Dense Shrub, Flat to Edge of Pit
	ZAM	1	Zamia furfuracea / Zamia Min. 3' Gal. 12' Ht. x 12' Sp. 24" Cg. Full Foliage, No Spots
GROUND COVERS			
	CODE	GT#	BOTANICAL NAME / COMMON NAME
	AKH	4,221	Aeonium / Aeonium Deciduous Color: Min. 4' Ht. x Min. 4' Sp. Deciduous tree, Fully rooted
	AKL	5,607	Aeonium arboreum ssp. 'Atropurpureum' / Marnia Florida #1, Min. 4' Ht. x Min. 12' Sp. Min. 5' Diam. Fully rooted, 6' Germs with pure dark leaves
	REP	5,509	Turf Soap Replicia / Replicia Turf

Alton Town Center
Prepared for NADG & Brock De

Palm Beach Gardens, Florida
Landscape Plan
On-going environmental planning for the City of Palm Beach Gardens, Florida



0 10' 20' 40'

Date: 07-10-2015
Project No.: 88-039.020
Designed By: NM
Drawn By: LMB/KWK
Checked By: NM

Revision Dates:

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07-20-2016 KWK CITY RESUBMITTAL
09-06-2016 KWK CITY RESUBMITTAL

LP- 2
of 15

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Alton Town Center Prepared for NADG & Brock Development Group Palm Beach Gardens, Florida Landscape Plan



NORTH
0 10' 20' 40'


Scale: 1" = 20'-0"

Date: 07-10-2015
Project No.: 88-039.020
Designed By: NM
Drawn By: LMB/KWK
Checked By: NM

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07-20-2016 KWK G/TY RESUBMITTAL
09-06-2016 KWK G/TY RESUBMITTAL

SEE SHEET LP-4

KEY MAP

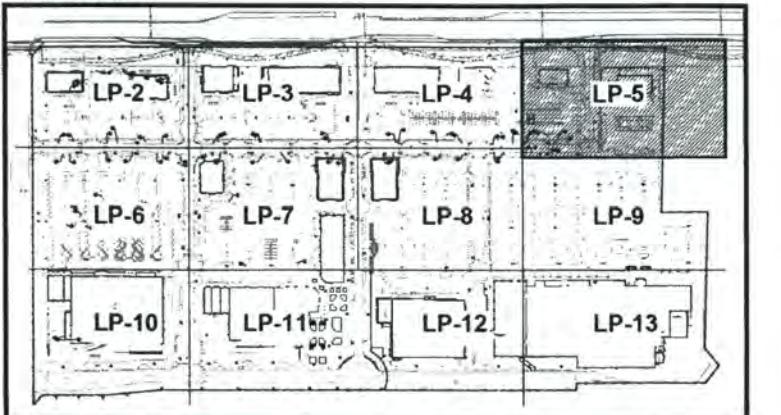


PAVER LEGEND

PEDESTRIAN ROADS PAVE/STYL - PLANK COMBINATION 4' X 18' & 4' X 12' COLOR - BEIGE MAX
PEDESTRIAN SIDEWALKS PAVE/STYL - PLANK HERRINGBONE 4' X 18' COLOR - LIGHT GRAY MAX
INTERSECTIONS PAVE/STYL - PLANK HERRINGBONE 4' X 18' COLOR - MEDIUM BEIGE MAX
ROADWAYS PAVE/STYL - PLANK RUNNING BOND 4' X 12' COLOR - SEDUM GRAY MAX
PEDESTRIAN CROSS WALKS PAVE/STYL - PLANK HERRINGBONE 4' X 12' COLOR - LIGHT BEIGE MAX
PARALLEL PARKING PAVE/STYL - COBBLESTONE 4' X 12' COLOR - DARK GRAY MAX

PLANT LIST

TREES	CODE	QTY	BOTANICAL NAME / COMMON NAME
CBL	61	1	Bursera simaruba / Brazilian Limebo
CBL	13	1	Canarium lanceolatum / Brazilian Sandalwood
CBL	126	1	Conocarpus erectus / Silver Bullockwood
CBL	80	1	Conocarpus erectus / Silver Bullockwood
CBL	236	1	Elaeagnus decipiens / Japanese Bittersweet Tree
CBL	31	1	Ficus carica / Common Fig
CBL	26	1	Lagerstroemia indica / Lagerstroemia Crape Myrtle
CBL	115	1	Liquidambar styraciflua / Japanese Sweet Tree
MIC	28	1	Mitchella repens / Mayapple
PO	65	1	Pinus sylvestris / Scotch Pine
PO	66	1	Pinus strobus / Eastern White Pine
PO	67	1	Pinus taeda / Loblolly Pine
PO	68	1	Pinus taeda / Shortleaf Pine
PO	69	1	Pinus taeda / Shortleaf Pine
PO	70	1	Pinus taeda / Shortleaf Pine
PO	71	1	Quercus nigra / River Birch
PO	72	1	Quercus virginiana / Live Oak
PO	73	1	Quercus virginiana / Live Oak
PO	74	1	Quercus virginiana / Live Oak
PO	75	1	Quercus virginiana / Live Oak
PO	76	1	Quercus virginiana / Live Oak
PO	77	1	Quercus virginiana / Live Oak
PO	78	1	Quercus virginiana / Live Oak
PO	79	1	Quercus virginiana / Live Oak
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PO	173	1	Quercus virginiana / Live Oak
PO	174	1	Quercus virginiana / Live Oak
PO	175	1	Quercus virginiana / Live Oak
PO	176	1	Quercus virginiana / Live Oak
PO	177	1	Quercus virginiana / Live Oak
PO	178	1	Quercus virginiana / Live Oak
PO	179	1	Quercus virginiana / Live Oak
PO	180	1	Quercus virginiana / Live Oak
PO	181	1	Quercus virginiana / Live Oak
PO	182	1	Quercus virginiana / Live Oak
PO	183	1	Quercus virginiana / Live Oak
PO	184	1	Quercus virginiana / Live Oak
PO	185	1	Quercus virginiana / Live Oak
PO	186	1	Quercus virginiana / Live Oak
PO	187	1	Quercus virginiana / Live Oak
PO	188	1	Quercus virginiana / Live Oak
PO	189	1	Quercus virginiana / Live Oak
PO	190	1	Quercus virginiana / Live Oak
PO	191	1	Quercus virginiana / Live Oak
PO	192	1	Quercus virginiana / Live Oak
PO	193	1	Quercus virginiana / Live Oak
PO	194	1	Quercus virginiana / Live Oak
PO	195	1	Quercus virginiana / Live Oak
PO	196	1	Quercus virginiana / Live Oak
PO	197	1	Quercus virginiana / Live Oak
PO	198	1	Quercus virginiana / Live Oak
PO	199	1	Quercus virginiana / Live Oak
PO	200	1	Quercus virginiana / Live Oak
PO	201	1	Quercus virginiana / Live Oak
PO	202	1	Quercus virginiana / Live Oak
PO	203	1	Quercus virginiana / Live Oak
PO	204	1	Quercus virginiana / Live Oak
PO	205	1	Quercus virginiana / Live Oak
PO	206	1	Quercus virginiana / Live Oak
PO	207	1	Quercus virginiana / Live Oak
PO	208	1	Quercus virginiana / Live Oak
PO	209	1	Quercus virginiana / Live Oak
PO	210	1	Quercus virginiana / Live Oak
PO	211	1	Quercus virginiana / Live Oak
PO	212	1	Quercus virginiana / Live Oak
PO	213	1	Quercus virginiana / Live Oak
PO	214	1	Quercus virginiana / Live Oak
PO	215	1	Quercus virginiana / Live Oak
PO	216	1	

KEY MAP

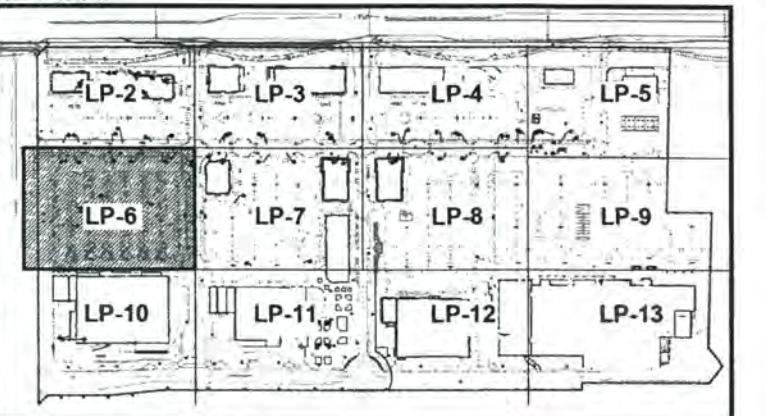

PAVER LEGEND

	PEDESTRIAN NODES PAVERSTYLE - PLANK COMBINATION 4' x 6' & 4' x 12' COLOR - NEUTRAL MX
	PEDESTRIAN SIDEWALKS PAVERSTYLE - PLANK RUNNING BOND 4' x 12' COLOR - LIGHT GRAY MX
	INTERSECTIONS PAVERSTYLE - PLANK HERRINGBONE 4' x 12' COLOR - MEDIUM BEIGE MX
	BROADWAYS PAVERSTYLE - PLANK RUNNING BOND 4' x 12' COLOR - MEDIUM GRAY MX
	PEDESTRIAN CROSS WALKS PAVERSTYLE - PLANK HERRINGBONE 4' x 12' COLOR - LIGHT BEIGE MX
	PARALLEL PARKING PAVERSTYLE - COBBLESTONE 4' x 12' COLOR - DARK GRAY MX

PLANT LIST

urban
design
kilday
STUDIOS

Urban Planning & Design Landscape Architecture Communication Graphics

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Alton Town Center
Prepared for NADG & Brock Development Group

Palm Beach Gardens, Florida Landscape Plan

During most of the twentieth century, the U.S. government's policies toward Native Americans were based on the idea that they were inferior to white Americans.



Scale: $1'' = 201.0''$

Date: 07-10-2015
Project No.: 88-039.020
Designed By: NM
Drawn By: LMB/KWK
Checked By: AIA

Revision Dates:
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12-09-2015 KWK CITY RESUBMITTAL
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05-29-2016 KWK CITY RESUBMITTAL
07-20-2016 KWK CITY RESUBMITTAL
09-06-2016 KWK CITY RESUBMITTAL

—

LP- 6
of 15

This detailed architectural landscape plan for Alton Road features a grid layout with various plantings, sidewalks, and infrastructure. The plan includes labels such as 'SEE SHEET LP-2' at the top left, 'ALTON ROAD' on the far left, 'SEE SHEET LP-7' on the right side, and 'SEE SHEET LP-10' at the bottom left and right.

Key features include:

- PLATEAUED INTERSECTION, TYP. BOLLARD, TYP.**: Located at the top left and top right intersections.
- CELEBRATION SOD, TYP.**: A large area of sod in the center.
- SIDEWALK**: Labeled multiple times along the edges.
- EXISTING PLANTING, SEE NPCID PROJECT #677**: Indicated by dashed lines.
- 8' SIDEWALK**: Width of the sidewalk.
- 30' LANDSCAPE AND PEDESTRIAN EASEMENT**: A strip of land between the sidewalk and the road.
- PODAs**: Various types of plantings, often labeled with codes like FIC, ZAM, AM, ED, PODA, SAT, etc., in hexagonal boxes.
- PODAs 40**: Specific planting types located in several locations.
- CART CORRAL, TYP.**: A structure in the center-left.
- LIGHTPOLE, TYP.**: A tall pole in the center-left.
- FIRE HYDRANT, TYP.**: Located in several locations.
- ST. AUGUSTINE SOD, TYP.**: A specific type of sod used in some areas.
- 12' U.E.** and **25' U.E.**: Unplanned areas.
- CLUA 110**, **JAS 9**, **CG 13**, **VM 7**, **JAS 8**, **CAO 4**, **JAS 9**, **FIC 40**, **SAT 33**, **PH 1**, **PODA 8**, **RE 13**: Various plant species and codes.

The plan also includes a scale bar at the bottom and directional arrows indicating north.


Alton Town Center Prepared for NADG & Brock Development Group Palm Beach Gardens, Florida Landscape Plan



Scale: 1" = 20'-0"

Date: 07-10-2015
Project No.: 88-039.020
Designed By: NM
Drawn By: LMB/KWK
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09.09.2016 KWK CITY RESUBMITTAL

KEY MAP

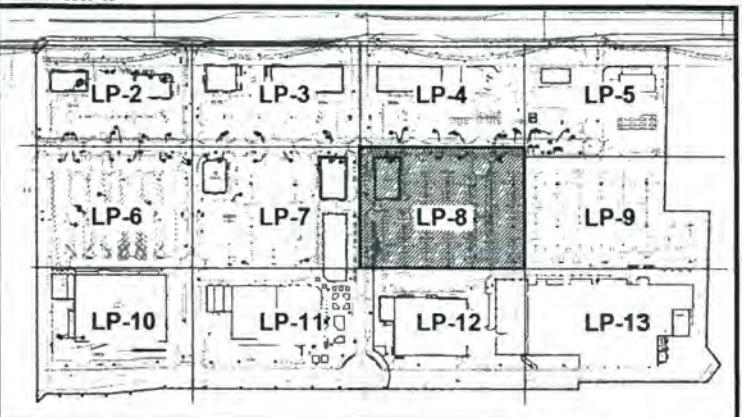


PAVER LEGEND

PEDESTRIAN HOGES PAVEMENT - PLANK COMBINATION 4" x 12" x 12"	COLOR - MEDIUM BEIGE MIX
PEDESTRIAN SIDEWALKS PAVEMENT - PLANK RUNNING BOND 4" x 12"	COLOR - LIGHT GRAY MIX
INTERSECTIONS PAVEMENT - PLANK HERRINGBONE 4" x 12"	COLOR - MEDIUM BEIGE MIX
ROADWAYS PAVEMENT - PLANK RUNNING BOND 4" x 12"	COLOR - MEDIUM GRAY MIX
PEDESTRIAN CROSS WALKS PAVEMENT - PLANK HERRINGBONE 4" x 12"	COLOR - LIGHT BEIGE MIX
PARALLEL PARKING PAVEMENT - COBBLESTONE 4" x 12"	COLOR - DARK GRAY MIX

PLANT LIST

TREES	CODE	QTY	BOTANICAL NAME / COMMON NAME
BS	61	1	Baobab / Monkey Buttress / Gumbo Limbo Min. 12' Ht. x 5' Sp. 2.5" Cal. Single Straight Trunk, Full Canopy
CB	33	1	Calycanthus floridana / Sweetshrub Min. 12' Ht. x 6' Sp. 2.5" Cal. Single Straight Trunk, Full Canopy
CG	126	1	Conocarpus erectus / Green Butterwood Min. 12' Ht. x 5' Sp. 2.5" Cal. Single Straight Trunk, Full Canopy
CE	99	1	Crinum americanum var. venustum / Sweet Butterwort Min. 12' Ht. x 5' Sp. 2.5" Cal. Single Straight Trunk, Full Canopy
ED	236	1	Dianella nigra / Blackberry Tree Min. 12' Ht. x 5' Sp. 2.5" Cal. Single Straight Trunk, Full Canopy
IC	21	1	Elaeagnus caroliniana / Chinese Olive Min. 12' Ht. x 5' Sp. 2" Cal. Single Trunk, Full Canopy
LT	35	1	Lagerstroemia indica / Crape Myrtle Min. 12' Ht. x 5' Sp. 2.5" Cal. Total, Mass Trunk, Full Canopy
LZ	115	1	Liquidambar styraciflua / Japanese Privet Tree Min. 4' Ht. x 6' Sp. 1" Cal. Total, Male Trunk, Full Canopy
MC	28	1	Mitchella repens / Mayapple Min. 30' Cal. x 14' Ht. x 6' Sp. Female #1, Full at base No stem
PD	65	1	Prunus elaeagnifolia / Chinese Snowball Min. 14'-18' Ht. x 5' Sp. 2.5" Cal. Total, Male Trunk, Full Canopy
QW	95	1	Quercus ilex / Live Oak Min. 18' Ht. x 8' Sp. 2" Cal. Single Straight Trunk, Full and Low Canopy
QV	43	1	Quercus virginiana / Scarlet Oak Min. 18' Ht. x 8' Sp. 2.5" Cal. Single Straight Trunk, Full and Low Canopy
PALM TREES	CODE	GTN	BOTANICAL NAME / COMMON NAME
	MM	77	Areca palm / Tropical Fan Palm Min. 10' Cl. x 12" Cal. #8• Florida Fancy, No Scared Trunk
	BN	3	Brachychiton populneus / Silver Flame Palm Min. 18' Cl. x 12" Cal. #8• Florida Fancy, No Scared Trunk
	CM	18	Canary Island Date Palm Min. 12' Cl. x 10' D.A. #8• Single Trunk, Full Hard, No Scared Trunk
	PH	42	Phoenix canariensis / Canary Island Date Palm Min. 20' Cl. x 10' D.A. #8• Single Trunk, Matched Height, No Scared Trunk
	PS	41	Phoenix dactylifera / Wild Date Palm Min. 15' Cl. x 10' D.A. #8• Single Trunk, Diamond Cut, Full Hard, No Scared Trunk
	RE	71	Roystonea regia / Royal Palm Min. 20' Cl. x 10' D.A. #8• Single Trunk, Full Hard, No Scared Trunk
	SP	186	Sabal palmetto / cabbage Palm Min. 15'-22' Cl. x 8' Cal. #8• Florida Cut
	VM	236	Yucca gloriosa / Spanish Dagger Min. 22' Cl. x 8' D.A. #8• Single Trunk, Full Hard, No Scared Trunk
SHRUBS	CODE	GTN	BOTANICAL NAME / COMMON NAME
	CAO	153	Crinum asiaticum / Queen's Spear / Queen's Spear Min. 1' Cal. x 12" Sp. Full and Even foliage, No Scared foliage, Disease Free, 1 plant per pot
	DYP	439	Forsythia suspensa / Golden Chain / Golden Chain Min. 10' Ht. x 6' Sp. 34" D.C. Full and Dense Shrub, Full to Shear
	FCR	402	Ficus Repens / Creeping Fig Min. 3' Cal. x 12" D.C.
	POD	419	Prostanthera incisa / Prostanthera Min. 1' D.W. x 24" Ht. x 24" Sp. 34" D.C. Full and Dense Shrub, Full to Shear
	THD	51	Thunbergia grandiflora / Star Vine Min. 1' Cal. x 24" D.C.
	JAC	32	Trachelospermum jasminoides / Confederate Jasmine Min. 1' Cal. x 24" D.C.
SHRUB AREAS	CODE	GTN	BOTANICAL NAME / COMMON NAME
	AIC	1,866	Acokanthera schimperi / Devil's Backbone Min. 1' Cal. x 18" Ht. x 18" Sp. 18" D.C. Full and Dense Shrub, Full to Edge of Pot
	CRH	3,695	Chrysobalanus icaco / Red Tip Cocnut Min. 1' Cal. x 24" Ht. x 24" Sp. 34" D.C. Full and Dense Shrub, Full to Edge of Pot
	CLU	1,444	Clusiella guianensis / Devil's Cocnut Min. 1' Cal. x 24" Ht. x 24" Sp. 34" D.C. Full and Dense Shrub, Full to Edge of Pot
	CLU2	1,449	Clusiella guianensis / Devil's Cocnut Min. 15' Cal. x 1' Sp. 34" D.C. Full and Dense Shrub, Full to Edge of Pot
	CIN	289	Cynometra apiculata / Memory Cedar Min. 1' Cal. x 24" Ht. x 24" Sp. 34" D.C. Full and Dense Shrub, Full to Edge of Pot
	EGH	44	Emilia sonchifolia / Hornbeam Thread Grass Min. 1' Cal. x 18" Ht. x 12" Sp. 18" D.C. Full and Dense Shrub, Full to Edge of Pot
	FIC	13,957	Ficus microcarpa / Green Island / Green Island Ficus Min. 1' Cal. x 12" Ht. x 12" Sp. 34" D.C. Full and Dense Shrub, Full to Edge of Pot
	HAM	1,909	Hamelia nummularia / Iron Jasmine Min. 1' Cal. x 18" Ht. x 18" Sp. 34" D.C. Full and Dense Shrub, Full to Edge of Pot
	JAS	1,421	Jasminum volubile / Star Jasmine Min. 1' Cal. x 18" Ht. x 18" Sp. 34" D.C. Full and Dense Shrub, Full to Edge of Pot
	JUN	104	Juncaria chinensis / Parrot's Beak Min. 1' Cal. x 12" Ht. x 12" Sp. 18" D.C. Full and Dense Shrub, Full to Edge of Pot
	MAB	779	Monnieria capillaris / Purple Murky Grass Min. 1' Cal. x 24" Ht. x 24" Sp. 34" D.C. Full and Dense Shrub, Full to Edge of Pot
	POD2	7,277	Prostanthera rotundifolia / Prostanthera Min. 1' Cal. x 24" Ht. x 24" Sp. 34" D.C. Full and Dense Shrub, Full to Edge of Pot
	POD3	1,250	Prostanthera rotundifolia / Prostanthera Min. 15' Cal. x 1' Sp. 34" D.C. Full and Dense Shrub, Full to Edge of Pot
	PDS	207	Ruellia paniculata / Mexican Petunia / Purple Petunia Min. 1' Cal. x 12" Ht. x 12" Sp. 18" D.C. Full and Dense Shrub, Full to Edge of Pot
	RHA	310	Rubus rosifolia / Asia / Asian Rose Hips Min. 1' Cal. x 12" Ht. x 12" Sp. 34" D.C. Full and Dense Shrub, Full to Edge of Pot
	SAT	3,083	Schefflera arboricola / Tribulus / Umbrella Schefflera Min. 1' Cal. x 12" Ht. x 12" Sp. 34" D.C. Full and Dense Shrub, Full to Edge of Pot
	SPI	5,046	Spermatophyllum / Sand Coast Grass Min. 1' Cal. x 12" Ht. x 12" Sp. 34" D.C. Full and Dense Shrub, Full to Edge of Pot
	TRI	3,518	Thespesia populnea / Sweet Frangipani Min. 1' Cal. x 28" Ht. x 18" Sp. 24" D.C. Full and Dense Shrub, Full to Edge of Pot
	VIB	489	Viburnum odoratissimum / Sweet Viburnum Min. 3' Cal. x 24" Ht. x 24" Sp. 34" D.C. Full and Dense Shrub, Full to Edge of Pot
	ZAM	729	Zamioculcas zamiifolia / Zamioculcas Min. 3' Cal. x 12" Ht. x 12" Sp. 24" D.C. Full Foliage, No Spots
CAPPING ON GROUNDS	CODE	GTN	BOTANICAL NAME / COMMON NAME
	A221	Acacia / Acacia Seasonal Color, Min. 1' Sp. 1' Sp., Disease free, Full, Dense & Dense	
	MHN	9,827	Amelanchier alnifolia / Shadberry / Juneberry Fortla #1, Min. 4' Ht. x 1' Sp. 1' Sp., Min. 3' Sp., Fully foliated, 6 dense, Much with peta leaf area
	REP	3,585	Golf Soil Resists / Replica Turf

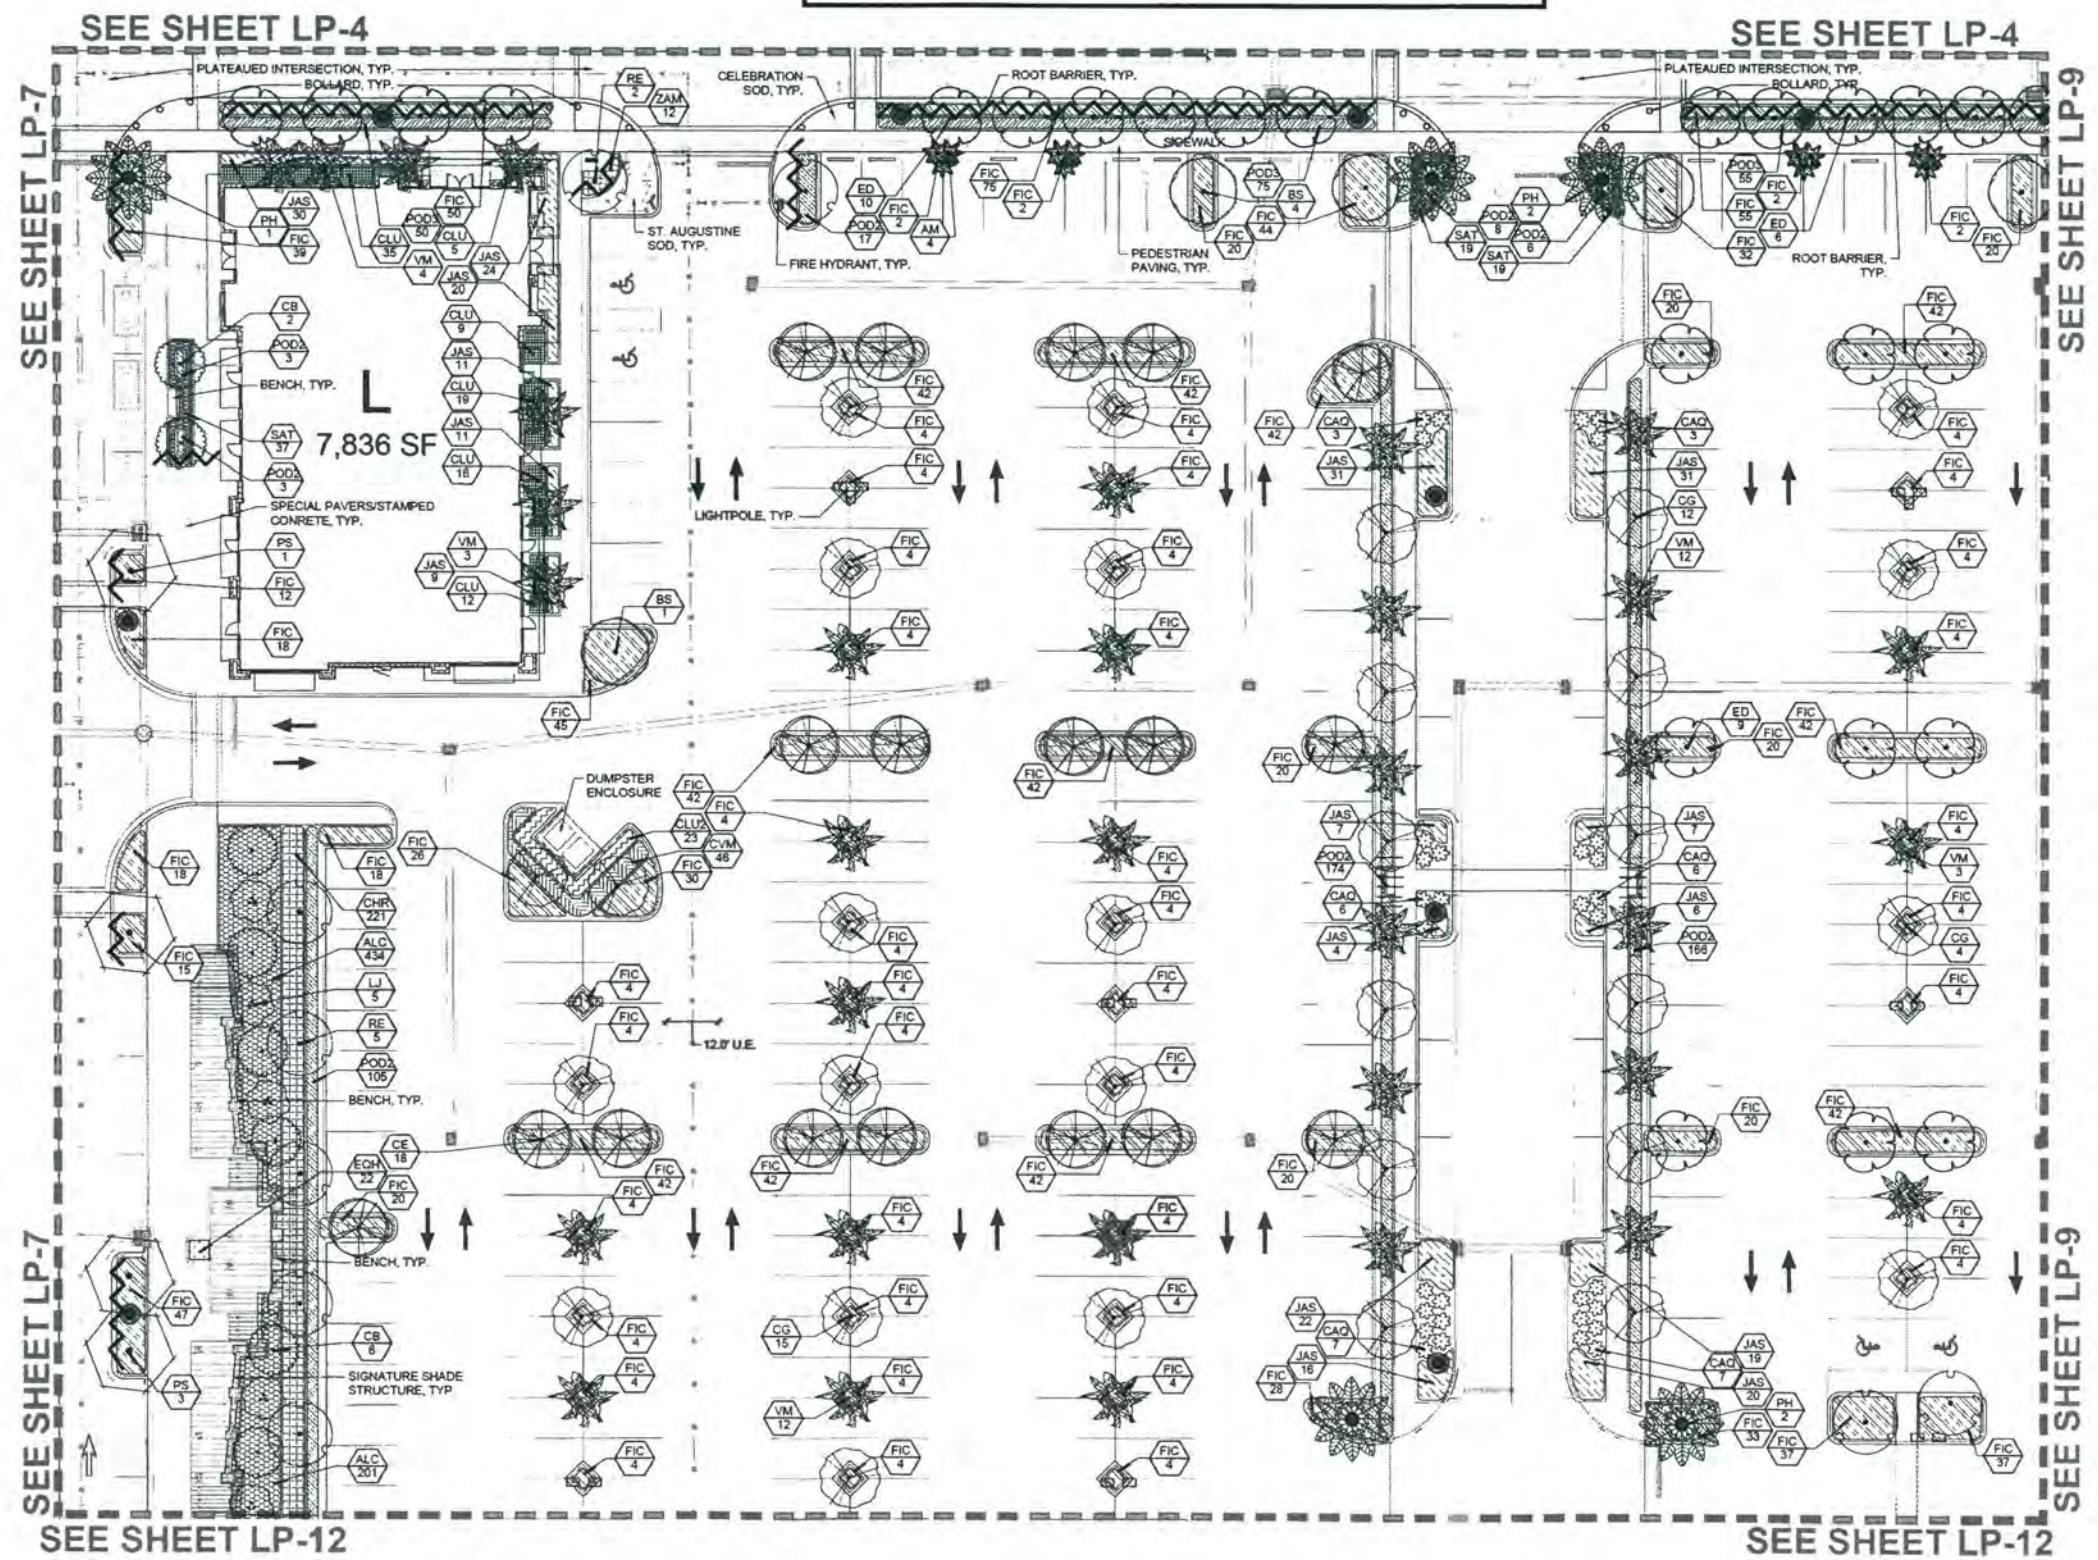

Alton Town Center Prepared for NADG & Brock Development Group Palm Beach Gardens, Florida Landscape Plan



NORTH

0 10' 20' 40'

Scale: 1" = 20'-0"

Date: 07-10-2015

Project No.: 88-039.020

Designed By: NM

Drawn By: LMB/KWK

Checked By: NM

Revision Dates:

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08.08.2015 KWH CITY RESUBMITTAL


04.20.2016 KWH CITY RESUBMITTAL

05.29.2016 KWH CITY RESUBMITTAL

07.20.2016 KWH CITY RESUBMITTAL


09.08.2016 KWH CITY RESUBMITTAL

KEY MAP

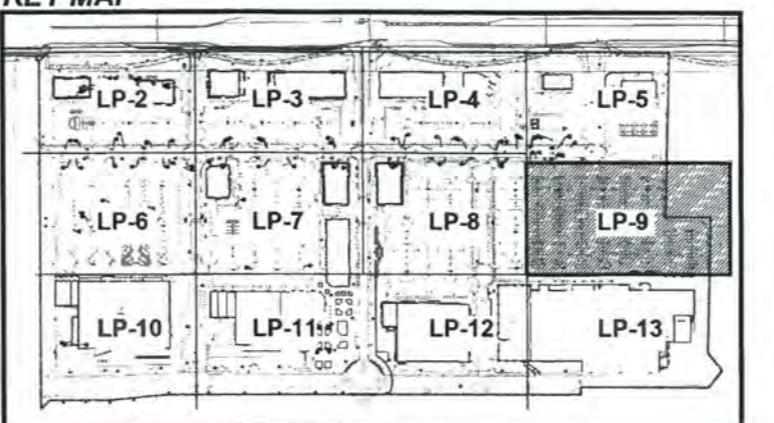

PAVER LEGEND

TABLE	CODE	QTY	BOTANICAL NAME / COMMON NAME
	BS	61	PEDESTRIAN NODES / Glaciar Liner Paverstyle - Plank Combination 4" x 18" x 2" x 12" COLOR - BEIGE MIX
	CB	33	Concrepave Interlock / Brulee Beaufort Min. 12" H. x 5' Bar 2.5" Cat. Single Straight Trunk, Full Canyon
	CG	125	Concrepave Interlock / Green Butterwood Min. 12" H. x 5' Bar 2.5" Cat. Single Straight Trunk, Full Canyon
	CE	80	Concrepave Interlock / Silver Butterwood Min. 12" H. x 5' Bar 2.5" Cat. Single Straight Trunk, Full Canyon
	CD	128	Concrepave Interlock / Japanese Blueberry Tree Min. 12" H. x 5' Bar 2' Cat. Single Straight Trunk, Full Canyon
	CE	31	CE Caspia / Cypress Tree Min. 12" H. 5' Bar 2" Cat. Single Straight Trunk, Full Canyon
	CL	28	Ligustrum # Ligustrum / Tussilago Capitata Myrsin Min. 12" H. x 5' Bar 2" Cat. Total, Multi-Trunk, Full Canyon
	CJ	115	Ligustrum Japonica / Japanese Privet Tree Min. 12" H. x 5' Bar 2.5" Cat. Total, Multi-Trunk, Full Canyon
	MC	26	Mitchella repens / Sweet Potato Vine Min. 20" W. 6' H. x 5' Bar, Florida #1, Full to base, Multi-trunk
	PD	65	Pavetta capensis / South Florida Mesh Vine Min. 14"-18" H. x 5' Bar 2.5" Cat. Vines Basket, Florida #1, Florida #1, Clusters w/white flowers at 14"-18" H., very fragrant in clusters
	DV	66	Quinchamalium vulgare / Chilean Holly Min. 20" W. 6' H. x 5' Bar, Florida #1, Full to base, Open Canopy, No Low Canopy
	CV	43	Quercus ilex / Holm Oak / Spanish Oak Min. 22" H. x 14' Bar, 4" Cat. Florida Fancy, Straight Stems, Full canopy, Matched Trunks, RPTD, Single Trunk Spec. Trunk, Single Trunk
	AM	77	Abies nobilis / Christmas Fir Min. 10' O.L. 12" Cat. B&B, Florida Fancy, Full Crown, Machine
	BN	1	Buxus sempervirens / Buxus Sempervirens Min. 10' O.L. 12" Cat. B&B, Florida Fancy, Full Crown, Machine
	CM	18	Crinodendron hookerianum / Chilean Holly Min. 12" O.L. 12" Cat. 0.4" H. Single Trunk, Full Head, No Scars Scars
	PR	42	Ficus petiolaris / Madras / Medium Date Palm Min. 20' Ctr measure from base of trunk, 6' Bar, Florida Fancy, Classic cut, Full crown, Matched height, No Scars Trunk, Single Trunk
	PS	61	Ficus benjamina / India Rubber Tree Min. 15" O.L. 20' O.A. H. Single Trunk, Diamond Cut, Full Head, No Scars Trunk
	RE	71	Rhizophora mangle / Florida Red Palm Min. 20' OH. 6' H. Min. 5' Bar, Florida Fancy Trunk, Full Head, No Scars Trunk
	RP	148	Sabal palmetto / cabbage Palmetto Min. 15'-22' OH. B&B, Florida #1, Hurricane cut
	TM	28	Thespesia populnea / Malabar Tree Min. 22' O.L. 20' O.A. H. Single Trunk, Full Head, No Scars Trunk
	BR	187	Cinnamomum camphora / Queen Emma / Queen Emma Cinnamon Min. 7' O.L. 24" H. x 24" Bar 24" O.C. Full and Dense Shrub, No Scars Trunk, Single Trunk
	DYR	429	Glycosmis pentaphylla / Africa Orange Min. 10' O.L. 24" H. x 24" Bar 24" O.C. Full and Dense Shrub, Full to Base
	FCR	42	Hamelia patens / Orange Coneflower Min. 5' O.L. 15' H.
	POD	418	Psychotria carthagenensis / Psychotria Min. 7' O.L. 24" H. x 24" Bar 24" O.C. Full and Dense Shrub, Full to Base
	TNG	51	Psychotria carthagenensis / Sky Rose Min. 5' O.L. 24" O.C.
	JAC	32	Trachelospermum jasminoides / Confederate Jasmine Min. 3' O.L. 24" O.C.
	SHRUB AREAS	CODE	BOTANICAL NAME / COMMON NAME
	A/LC	1,695	Albizia julibrissin / Mimosa Min. 10' O.L. 12" Cat. Full and Dense Shrub
	CHS	1,744	Chrysobalanus icaco / Red Tip / Red Tip Cocoplum Min. 5' O.L. 24" H. x 24" Bar 24" O.C. Full and Dense Shrub
	CLU	1,744	Chse gallesia / Desert Cactus Min. 10' O.L. 24" H. x 24" Bar 24" O.C. Full and Dense Shrub
	CLD	1,694	Chse gallesia / Desert Cactus Min. 10' O.L. 24" H. x 24" Bar 24" O.C. Full and Dense Shrub
	CMV	288	Clathrosanthus roseus / Harmony Cross Min. 3' O.L. 24" H. x 24" Bar 24" O.C. Full and Dense Shrub
	EGN	16	Eugenia jambolana / Indian Red Goose Min. 5' O.L. 18" H. x 12" Bar 24" O.C. Full and Dense Shrub Full to Edge of Plot
	TC	13,587	Ficus benjamina / Indian Rubber Tree Min. 10' O.L. 12" H. x 12' Bar 24" O.C. Full and Dense Shrub, Full to Base
	HAM	1,926	Hamelia patens / Orange Coneflower Min. 10' O.L. 18" H. x 24" Bar 24" O.C. Full and Dense Shrub, Full to Base
	JAS	1,421	Jasminum volubile / Star Jasmine Min. 10' O.L. 18" H. x 12' Bar 24" O.C. Full and Dense Shrub, Full to Base
	JUN	164	Junglania chinensis / Parrotia / Parrotia Min. 5' O.L. 24" H. x 12' Bar 24" O.C. Full and Dense Shrub, Full to Base
	MAB	779	Muhlenbergia capillaris / Prairie Muhly Grass Min. 2' O.L. 24" H. x 24" Bar 24" O.C. Full and Dense Shrub Full to Edge of Plot
	POZ	2,127	Psychotria carthagenensis / Psychotria Min. 3' O.L. 24" H. x 24" Bar 24" O.C. Full and Dense Shrub
	POZJ	1,296	Psychotria carthagenensis / Psychotria Min. 15' O.L. 24" H. x 24" Bar 24" O.C. Full and Dense Shrub
	POZM	267	Psychotria carthagenensis / Desert Psychotria Min. 3' O.L. 18" H. x 12' Bar 18" Bar 24" O.C. Full and Dense Shrub Full to Base
	RHA	316	Rhus integrifolia / White Indian Hawthorn Min. 5' O.L. 18" H. x 12' Bar 24" O.C. Full and Dense Shrub Full to Base
	SAT	1,083	Sophora secundiflora / Thrypticum / Thrypticum Min. 3' O.L. 18" H. x 12' Bar 24" O.C. Full and Dense Shrub Full to Base
	SPN	5,086	Spartina cynosuroides / Sand Cord Grass Min. 3' O.L. 24" H. x 24" Bar 24" O.C. Full and Dense Shrub Full to Edge of Plot
	TR	1,516	Triplaris gracilis / Dwarf / Parrotia Min. 3' O.L. 20" H. x 18" Bar 24" O.C. Full and Dense Shrub Full to Base
	VIB	482	Vitis vinifera / White Wine Min. 3' O.L. 24" H. x 24" Bar 24" O.C. Full and Dense Shrub Full to Base
	CAM	729	Zizaniopsis miliacea / Common Min. 3' O.L. 18" H. x 12' Bar 24" O.C. Full foliage, No Spots Full to Base
	YAN	4,221	Annualis / Amaranthus Min. 3' O.L. 18" H. x 12' Bar 24" O.C. Full foliage, Full flower
	MIN	9,927	Microseris glauca / Common Milkweed / Mimosa Min. 2' O.L. 18" H. x 12' Bar 24" O.C. Fully rooted Full to Base
	REP	3,535	Repens / Rootless Rapicola / Rapicola Min. 3' O.L. 18" H. x 12' Bar 24" O.C. Fully rooted Full to Base

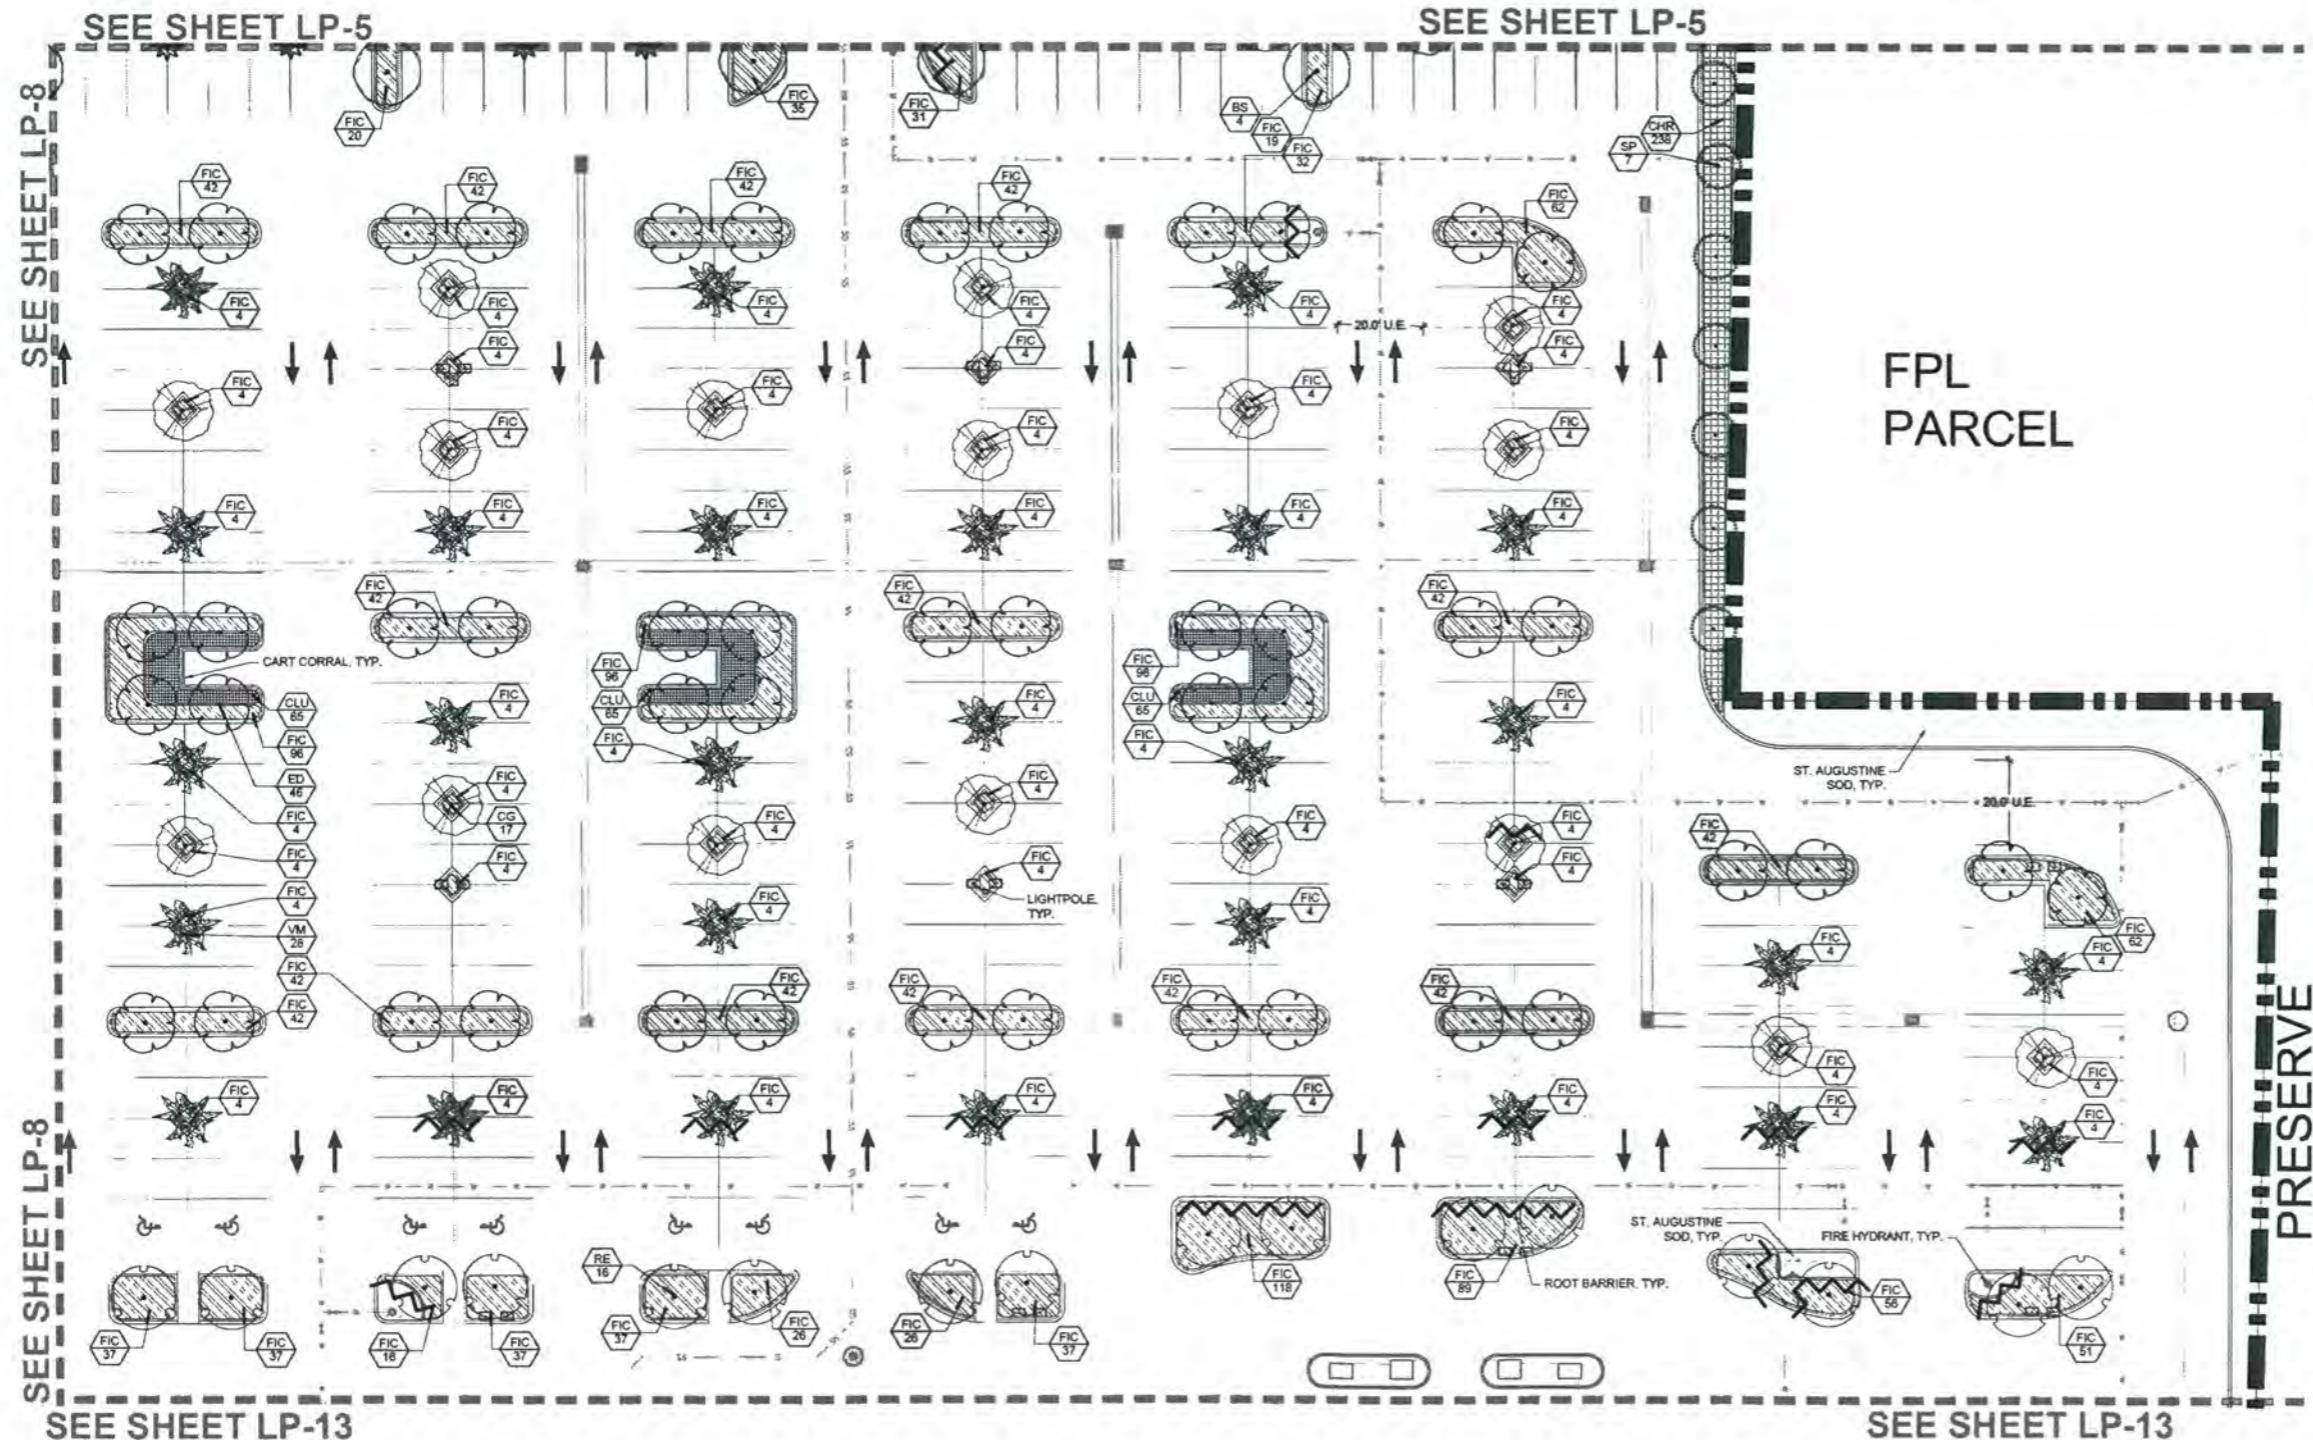


SEE SHEET LP-13

SEE SHEET LP-8

SEE SHEET LP-5

SEE SHEET LP-5

KEY MAP

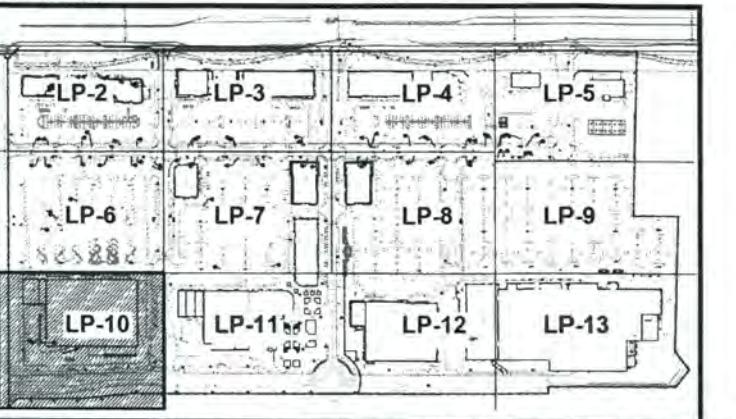

PAVER LEGEND

 <p>PEDESTRIAN NODES PAVERSTYLE - PLANK COMBINATION 4' X 10' & 6' X 6'</p>
 <p>INTERSECTIONS PAVERSTYLE - PLANK HERRINGBONE 4' X 10' COLOR - MEDIUM BEIGE MIX</p>
 <p>ROADWAYS PAVERSTYLE - PLANK RUNNING BOND 4' X 12' COLOR - MEDIUM GRAY MIX</p>
 <p>PEDESTRIAN CROSS WALKS PAVERSTYLE - PLANK HERRINGBONE 4' X 12'</p>
 <p>PARALLEL PARKING PAVERSTYLE - COMBINATION 4' X 12' COLOR - DARK GRAY MIX</p>

PLANT LIST

SEE SHEET LP-6

SEE SHEET LP-6

This detailed architectural site plan illustrates a mixed-use development project, likely a residential and commercial complex, situated along Alton Road and Primary Street. The plan is divided into several key areas:

- Section A:** Located on the right side of the site, this area measures 49,098 SF and includes a trash compactor, a signature shade structure, and a 6'0" site wall.
- Section C:** Located on the left side, this area measures 4,636 SF and features a green wall, a generator, and a proposed monument sign.
- Common Areas:** The site includes a primary street entrance, a secondary entrance labeled "ATLANTICO", and various landscape elements such as bike racks, pedestrian pavers, and St. Augustine sod.
- Infrastructure:** The plan shows utility connections, including light poles, and various structural components like root barriers and site walls.
- Landscaping:** The site is heavily landscaped with trees, shrubs, and ground covers, following guidelines from the "NPBCID PROJECT #577".

The plan also includes a legend for symbols and a north arrow. Specific dimensions and area measurements are provided throughout the drawing.


Alton Town Center

Prepared for NADG & Brock Development Group

Palm Beach Gardens, Florida
Landscape Plan



100 201

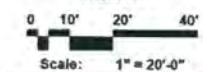

Date:	07-10-2015
Project No.:	88-039.020
Designed By:	NM
Drawn By:	LMB/KWK
Checked By:	NM
Revision Dates:	
07.17.2015	LMB CITY SUBMITTAL
02.06.2016	KWK CITY RESUBMITTAL
04.20.2015	KWK CITY RESUBMITTAL
06.29.2015	KWK CITY RESUBMITTAL
07.20.2015	KWK CITY RESUBMITTAL

LP-10
of 15

Alton Town Center Prepared for NADG & Brock Development Group Palm Beach Gardens, Florida Landscape Plan

Drawing name: LP-11.dwg Date: 07/10/2015 Author: The Urban Design Kilday Studios, LLC



NORTH


Scale: 1" = 20'-0"

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07/20/2016 KWK CITY RESUBMITTAL
09/06/2016 KWK CITY RESUBMITTAL

LP-11
of 15

KEY MAP

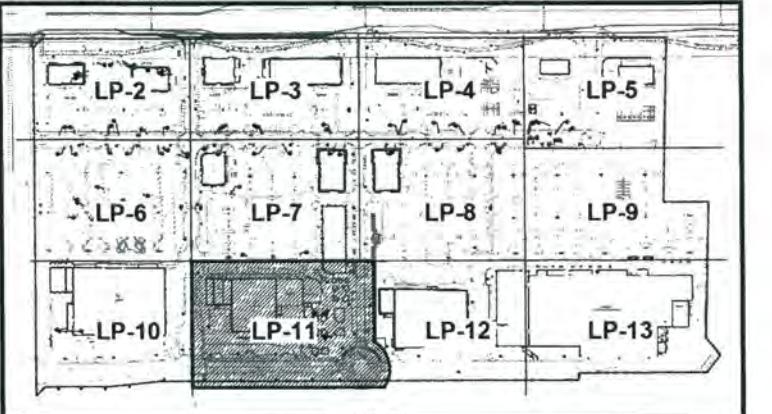

PAVER LEGEND

TREES	CODE	QTY	BOTANICAL NAME / COMMON NAME
BS	31	1	Burfordiavera / Umbrella Limbo Min. 12' Ht. x 5' Sp. 2.5" Cal. Single Straight Trunk, Full Canopy
CB	33	1	Celtislindheimeri / Blackjack Baldcypress Min. 12' Ht. x 4' Sp. 2.5" Cal. Single Straight Trunk, Full Canopy
CO	36	1	Conocarpus erectus / Green Buttonwood Min. 12' Ht. x 5' Sp. 2.5" Cal. Single Straight Trunk, Full Canopy
GE	60	1	Conocarpus erectus heterophyllus / Silver Buttonwood Min. 12' Ht. x 5' Sp. 2.5" Cal. Single Straight Trunk, Full Canopy
ED	33	1	Elaeocarpus decipiens / Japanese Holly Tree Min. 12'-14' Ht. x 5' Sp. 2" Cal. Single Straight Trunk, Full Canopy
IC	31	1	Ficus elastica / Indian Holly Min. 12' Ht. x 5' Sp. 2" Cal. Foliage #1, Straight Trunk, Full Canopy
LT	26	1	Lagerstroemia indica / Tallowtree Crepe Myrtle Min. 12' Ht. x 5' Sp. 2.5" Cal. Total, Multi-Trunk, Full Canopy
LJ	115	1	Liquidambar styraciflua / Japanese Sweetgum Tree Min. 8' Ht. x 4' Sp. 2" Cal. Total, Multi-Trunk, Full Canopy
MC	36	1	Mitchella repens / Wild Strawberry Min. 30 Gal. x 4' Sp. Foliage #1, Full to base, Multi-trunk
PD	65	1	Pithecellobium dulce / South Florida Flamboyant Min. 18' Ht. x 5' Sp. 3" Cal. Single Straight Trunk, Full Canopy, Equally spreading at 14', 15' & 16' Ht., Very height in clusters
SV	65	1	Syzygium jambos / Lime Guava Min. 10' Ht. x 5' Sp. 4" Cal. Single Straight Trunk, Full and Even Canopy, No Low Crest
TC	43	1	Quercus imbricaria / Shingle Oak / Shingle Oak Live Oak Min. 22' Ht. x 4' Sp. 3" Cal. Ball, Florida Fancy, straight trunk, Full canopy, Matching Holes, IPO, Single Source live oak branch tree fragrance

PLANT LIST

TREES	CODE	QTY	BOTANICAL NAME / COMMON NAME
AM	77	1	Azadirachta indica / Chinaberry Tree Min. 8' Cal. Triple Trunk, Full Head, No Scared Trunk
BN	3	1	Bixa orellana / Brazil Nut Tree Min. 12' Ht. x 12' Sp. 4" Cal. Single Trunk, Full Canopy, Matching
CM	18	1	Carica papaya / Papaya Tree Min. 12' Cal. Single Trunk, Full Head, No Scared Trunk
PH	62	1	Prunus domestica / Mespilus / Meadow Sweet Pines Min. 20' CF measures from base of stem, 64Gal, Panda Fancy, Clustered cal, Full crown, Matching heights, No Scared Trunk
PS	61	1	Phoenix sylvestris / Wild Date Palm Min. 15' Cal. 2.5" Sp. 1" Cal. Diamond Cut, Full Head, No Scared Trunk
RL	71	1	Roxburghia alata / Pandanus Tectorius Min. 10' Ht. x 5' Sp. 2" Cal. Foliage #1, Single Trunk, Full Head, No Scared Trunk
SP	198	1	Elaeis guineensis / Common Palms Min. 15'-22' Cal. 80A, 100A, 120A, 13260A,

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Alton Town Center
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Landscape Plan




108

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09.06.2016	KWIC CITY RESUBMITTAL

LP-12
of 15

KEY MAP

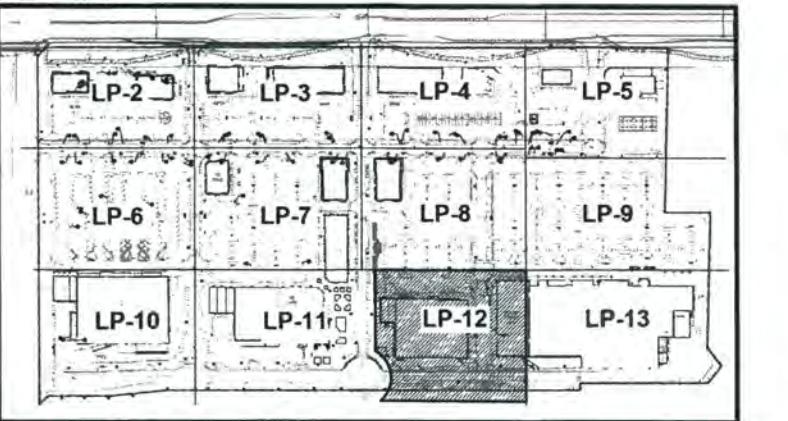

AVER LEGEND

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PLANT LIST

TREES	CODE	QTY	BOTANICAL NAME / COMMON NAME
	BS	61	<i>Bixa orellana</i> / Bignon Tree Min. 12' Ht. x 5' Sp. 2.5' Cal. Single Straight Trunk, Full Canopy
	CB	33	<i>Caryocarpus lophanthoides</i> / Brazilian Breadfruit Min. 12' Ht. x 5' Sp. 2.5' Cal. Single Straight Trunk, Full Canopy
	CB	136	<i>Conocarpus erectus</i> / Queen's Bushwood Min. 12' Ht. x 5' Sp. 2.5' Cal. Single Straight Trunk, Full Canopy
	CE	82	<i>Conocarpus erectus microphyllus</i> / Silver Bushwood Min. 12' Ht. x 5' Sp. 2.5' Cal. Single Straight Trunk, Full Canopy
	ED	236	<i>Elaeocarpus discolor</i> / Japanese Strawberry Tree Min. 12' Ht. x 5' Sp. 2' Cal. 1' trunk, Florida Fancy, straight trunk, full canopy
	EG	31	<i>Ficus aurea</i> / Daboen Holly Min. 12' Ht. x 5' Sp. 2' Cal. Florida #1, Straight Trunks, Full canopy
	EL	26	<i>Liquidambar styraciflua</i> / Tulipwood, Crape Myrtle Min. 12' Ht. x 5' Sp. 2.5' Cal. Full, Multi-Trunk, Full Canopy
	EL	115	<i>Liquidambar japonica</i> / Japanese Sweetgum Tree Min. 8' Ht. x 5' Sp. 2.5' Cal. Total, Full, Multi-Trunk, Full Canopy
	MC	28	<i>Mitchella repens</i> / Mayapple Min. 30' Diam. Ht. x 5' Sp. 2' Cal. Florida #1, Full to base, Multi-Trunk
	PD	65	<i>Phoebe australis</i> / South Florida Slave Pine Min. 14' Ht. x 5' Sp. 3' Cal. Wine Basswood, Florida #1, Full to base, Multi-Trunk, Full Canopy, Scattered at 14', 16', 18', 332', 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SEE SHEET LP-8

SEE SHEET LP-8

This detailed architectural landscape plan illustrates the design for the Garden Center area, spanning 19,379 SF. The plan includes a central building footprint of 36,420 SF and an adjacent structure of 2,700 SF. Key features include a primary street at the bottom, a garden center gate on the right, and various plantings such as St. Augustine sod, replica turf, and shrubs. Labels indicate 'GARDEN CENTER GATE' and 'PRIMARY STREET'. Numerous hexagonal callouts provide specific details for elements like root barriers, pedestrian pavers, and curb ground planters. A large letter 'S' is positioned in the center of the plan.

SEE SHEET LP-11

Alton Town Center Prepared for NADG & Brock Development Group Palm Beach Gardens, Florida Landscape Plan

Brown = Hardscape, Tan = Landscaping, Green = Water



NORTH


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Scale: 1" = 20'-0"

Date: 07-10-2015
Project No.: 88-039-020
Designed By: NM
Drawn By: LMB/KWK
Checked By: NM
Revision Dates:
07-17-2015 LMB CITY SUBMITTAL
02-09-2016 KWK CITY RESUBMITTAL
04-20-2016 KWK CITY RESUBMITTAL
06-29-2016 KWK CITY RESUBMITTAL
07-20-2016 KWK CITY RESUBMITTAL
09-06-2016 KWK CITY RESUBMITTAL

LP-13
of 15

KEY MAP

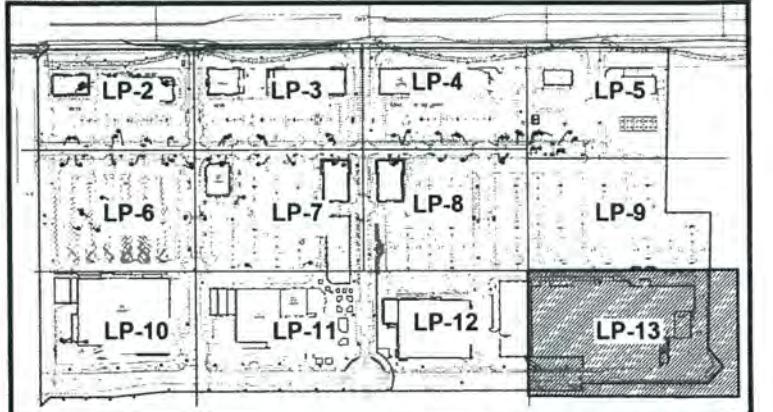

SEE SHEET LP-9

PAVER LEGEND

PEDESTRIAN HERRINGBONE PAVEMENT - PLANK HERRINGBONE 4" X 16" COLOR - LIGHT GRAY MIX		
INTERSECTIONS PAVEMENT - PLANK HERRINGBONE 4" X 16" COLOR - MEDIUM GRAY MIX		
ROADWAYS PAVEMENT - PLANK HERRINGBONE 4" X 12" COLOR - MEDIUM GRAY MIX		
PEDESTRIAN CROSS WALKS PAVEMENT - PLANK HERRINGBONE 4" X 12" COLOR - LIGHT BEIGE MIX		
PARALLEL PARADES PAVEMENT - COBBLESTONE 4" X 12" COLOR - DARK GRAY MIX		


SEE SHEET LP-9

PLANT LIST

TREES CONTINUED		
QV	55	Quercus virginiana / Live Oak Min. 48" H. x 6' Sp. 2.5" Cal. Single Straight Trunk, Full Canopy, No Low Crook
QV2	43	Quercus virginiana / Spanish Moss Min. 22' H. x 6' Sp. 2.5" Cal. Single Straight Trunk, Full Canopy, No Low Crook
AM	77	Adonidia merillii / Chusan Palm Min. 8' Cal. Single Straight Trunk
BN	1	Bismarckia nobilis / Riesenpalme Min. 12' H. x 12' Sp. 2.5" Cal. Single Straight Trunk, Full Canopy
CM	18	Caryota mitis / Fiddle Leaf Palm Min. 12' H. x 6' O.A. Single Trunk, Full Head, No Scanned Trunk
PH	42	Phoenix roebelenii / Mexican Date Palm Min. 20' CW measure from base of tree, 6400, Florida Fancy, Classic Cal. Full crown, Matched Trunks, No Scanned Trunk
PS	61	Phoenix sylvestris / Date Palm Min. 15' Cl. 2.5" Sp. 2.5" Cal. Total Multi-Trunk, Full Head, No Scanned Trunk
RE	71	Rhapis excelsa #2 / Lady Royal Fern Min. 6' Cl. 2.5" Sp. 2.5" Cal. Single Trunk, Full Head
SP	149	Rubus phoenicolasius / Rubus Parviflorus Min. 12' Cl. 2.5" Sp. 2.5" Cal. Single Trunk
VM	230	Vitis montevidensis / Montevideo Palm Min. 22' Cl. 2.5" O.A. H. Triple Trunk, Full Head, No Scanned Trunk

SHRUBS

SHRUB AREAS		
AJC	109	Crinum asiaticum / Queen Emma / Queen Exuma Min. 7' Cal. 12" H. x 12" Sp. 2.5" Cal. Full and Dense Shrub, Full to Base
DYP	479	Dyphelia integrifolia / Acaia Palm Min. 10' H. x 8' Sp. 2.5" O.C. Full and Dense Shrub, Full to Base
FIC	407	Elaeagnus pungens / Creeping Eg Min. 3' Clad. 12" H. x 12" Sp. 2.5" O.C. Full and Dense Shrub, Full to Base
PDO	418	Podocarpus macrophyllus / Podocarpus Min. 3' Cal. 24" H. x 24" Sp. 3" O.C. Full and Dense Shrub, Full to Base
THC	51	Hedera helix 'gracilis' / Sky Vine Min. 7' Cal. 24" O.C. Full to Base
JAC	32	Trachelospermum jasminoides / Confederate Jasmine Min. 3' Cal. 24" O.C. Full to Base
ALC	1499	Marmessus marmessus / Marmessus Marmessus Min. 3' Cal. 18" H. x 18" Sp. 2.5" O.C. Full and Dense Shrub, Full to Base
CHR	3495	Chrysanthemum coccineum / Red Rap / Red Rap Cocoon Min. 7' Cal. 24" H. x 24" Sp. 3" O.C. Full and Dense Shrub, Full to Base
CLU	1744	Clusia guianensis / Dwarf Clusia Min. 3' Cal. 12" H. x 12" Sp. 2.5" O.C. Full and Dense Shrub, Full to Base
CLU2	1499	Clusia guianensis / Dwarf Clusia Min. 3' Cal. 12" H. x 12" Sp. 2.5" O.C. Full and Dense Shrub, Full to Base
CHM	228	Confocalia reticulata / Marmsey / Marmsey Croton Min. 3' Cal. 24" H. x 24" Sp. 3" O.C. Full and Dense Shrub, Full to Base
FOH	48	Equisetum hyemale / Horsetail Reed Grass Min. 1' Cal. 12" H. x 12" Sp. 2.5" O.C. Full and Dense Shrub, Full to Base
FIC	13387	Ficus microcarpa 'Ginseng Island' / Ginseng Island Ficus Min. 3' Cal. 12" H. x 12" Sp. 2.5" O.C. Full and Dense Shrub, Full to Base
FIC4	1404	Ficus microcarpa 'Dwarf Ficus' Min. 3' Cal. 18" H. x 18" Sp. 2.5" O.C. Full and Dense Shrub, Full to Base
JAS	1421	Jasminum polyanthum / Star Jasmine Min. 3' Cal. 18" H. x 18" Sp. 2.5" O.C. Full and Dense Shrub, Full to Base
JUN	154	Juncus effusus 'Parsons' / Parsons' Amber Min. 3' Cal. 12" H. x 12" Sp. 2.5" O.C. Full and Dense Shrub, Full to Base
MUL	1772	Muhlenbergia capillaris / Pine Muhly Grass Min. 3' Cal. 24" H. x 24" Sp. 3" O.C. Full and Dense Shrub, Full to Edge of Pot
POD2	1727	Podocarpus macrophyllus / Podocarpus Min. 7' Cal. 24" H. x 24" Sp. 3" O.C. Full and Dense Shrub, Full to Base
POD3	1750	Podocarpus macrophyllus / Podocarpus Min. 15' Cal. 30" H. x 24" Sp. 3" O.C. Full and Dense Shrub, Full to Base
POD4	267	Podocarpus macrophyllus 'Deep Purple' / Deep Purple Podocarpus Min. 3' Cal. 18" H. x 18" Sp. 2.5" O.C. Full and Dense Shrub, Full to Base
RHA	3170	Rhamnus cathartica 'Alba' / White Indian Hawthorn Min. 3' Cal. 18" H. x 18" Sp. 2.5" O.C. Full and Dense Shrub, Full to Base
SAT	1093	Schizandra chinensis / Chinese Schizandra Min. 3' Cal. 18" H. x 18" Sp. 2.5" O.C. Full and Dense Shrub, Full to Base
SFA	5398	Sophora japonica 'Samurai' / Samuri Coral Grass Min. 3' Cal. 24" H. x 24" Sp. 3" O.C. Full and Dense Shrub, Full to Edge of Pot
TRB	3518	Tropaeolum speciosum / Desert Kalanchoe Grans Min. 3' Cal. 12" H. x 12" Sp. 2.5" O.C. Full and Dense Shrub, Full to Base
VIB	499	Viburnum obovatum / Deutzia / Walter's Viburnum Min. 3' Cal. 12" H. x 12" Sp. 2.5" O.C. Full and Dense Shrub, Full to Base
ZAM	729	Zamia furfuracea / Cycad Min. 3' Cal. 12" H. x 12" Sp. 2.5" O.C. Full foliage, No Spots
GROUNDCOVERS	ABN	Annual / Annual Min. 4' H. x Min. 1' Sp. Min. 4 pop., Fully rooted Min. 4' H. x Min. 1' Sp. Min. 4 pop., Fully rooted
MHN	6967	Trachelospermum jasminoides / Star Jasmine Min. 4' H. x Min. 1' Sp. Min. 4 pop., Fully rooted Min. 4' H. x Min. 1' Sp. Min. 4 pop., Fully rooted
REP	5,546 M	Turf Soil Replica / Reclad Turf

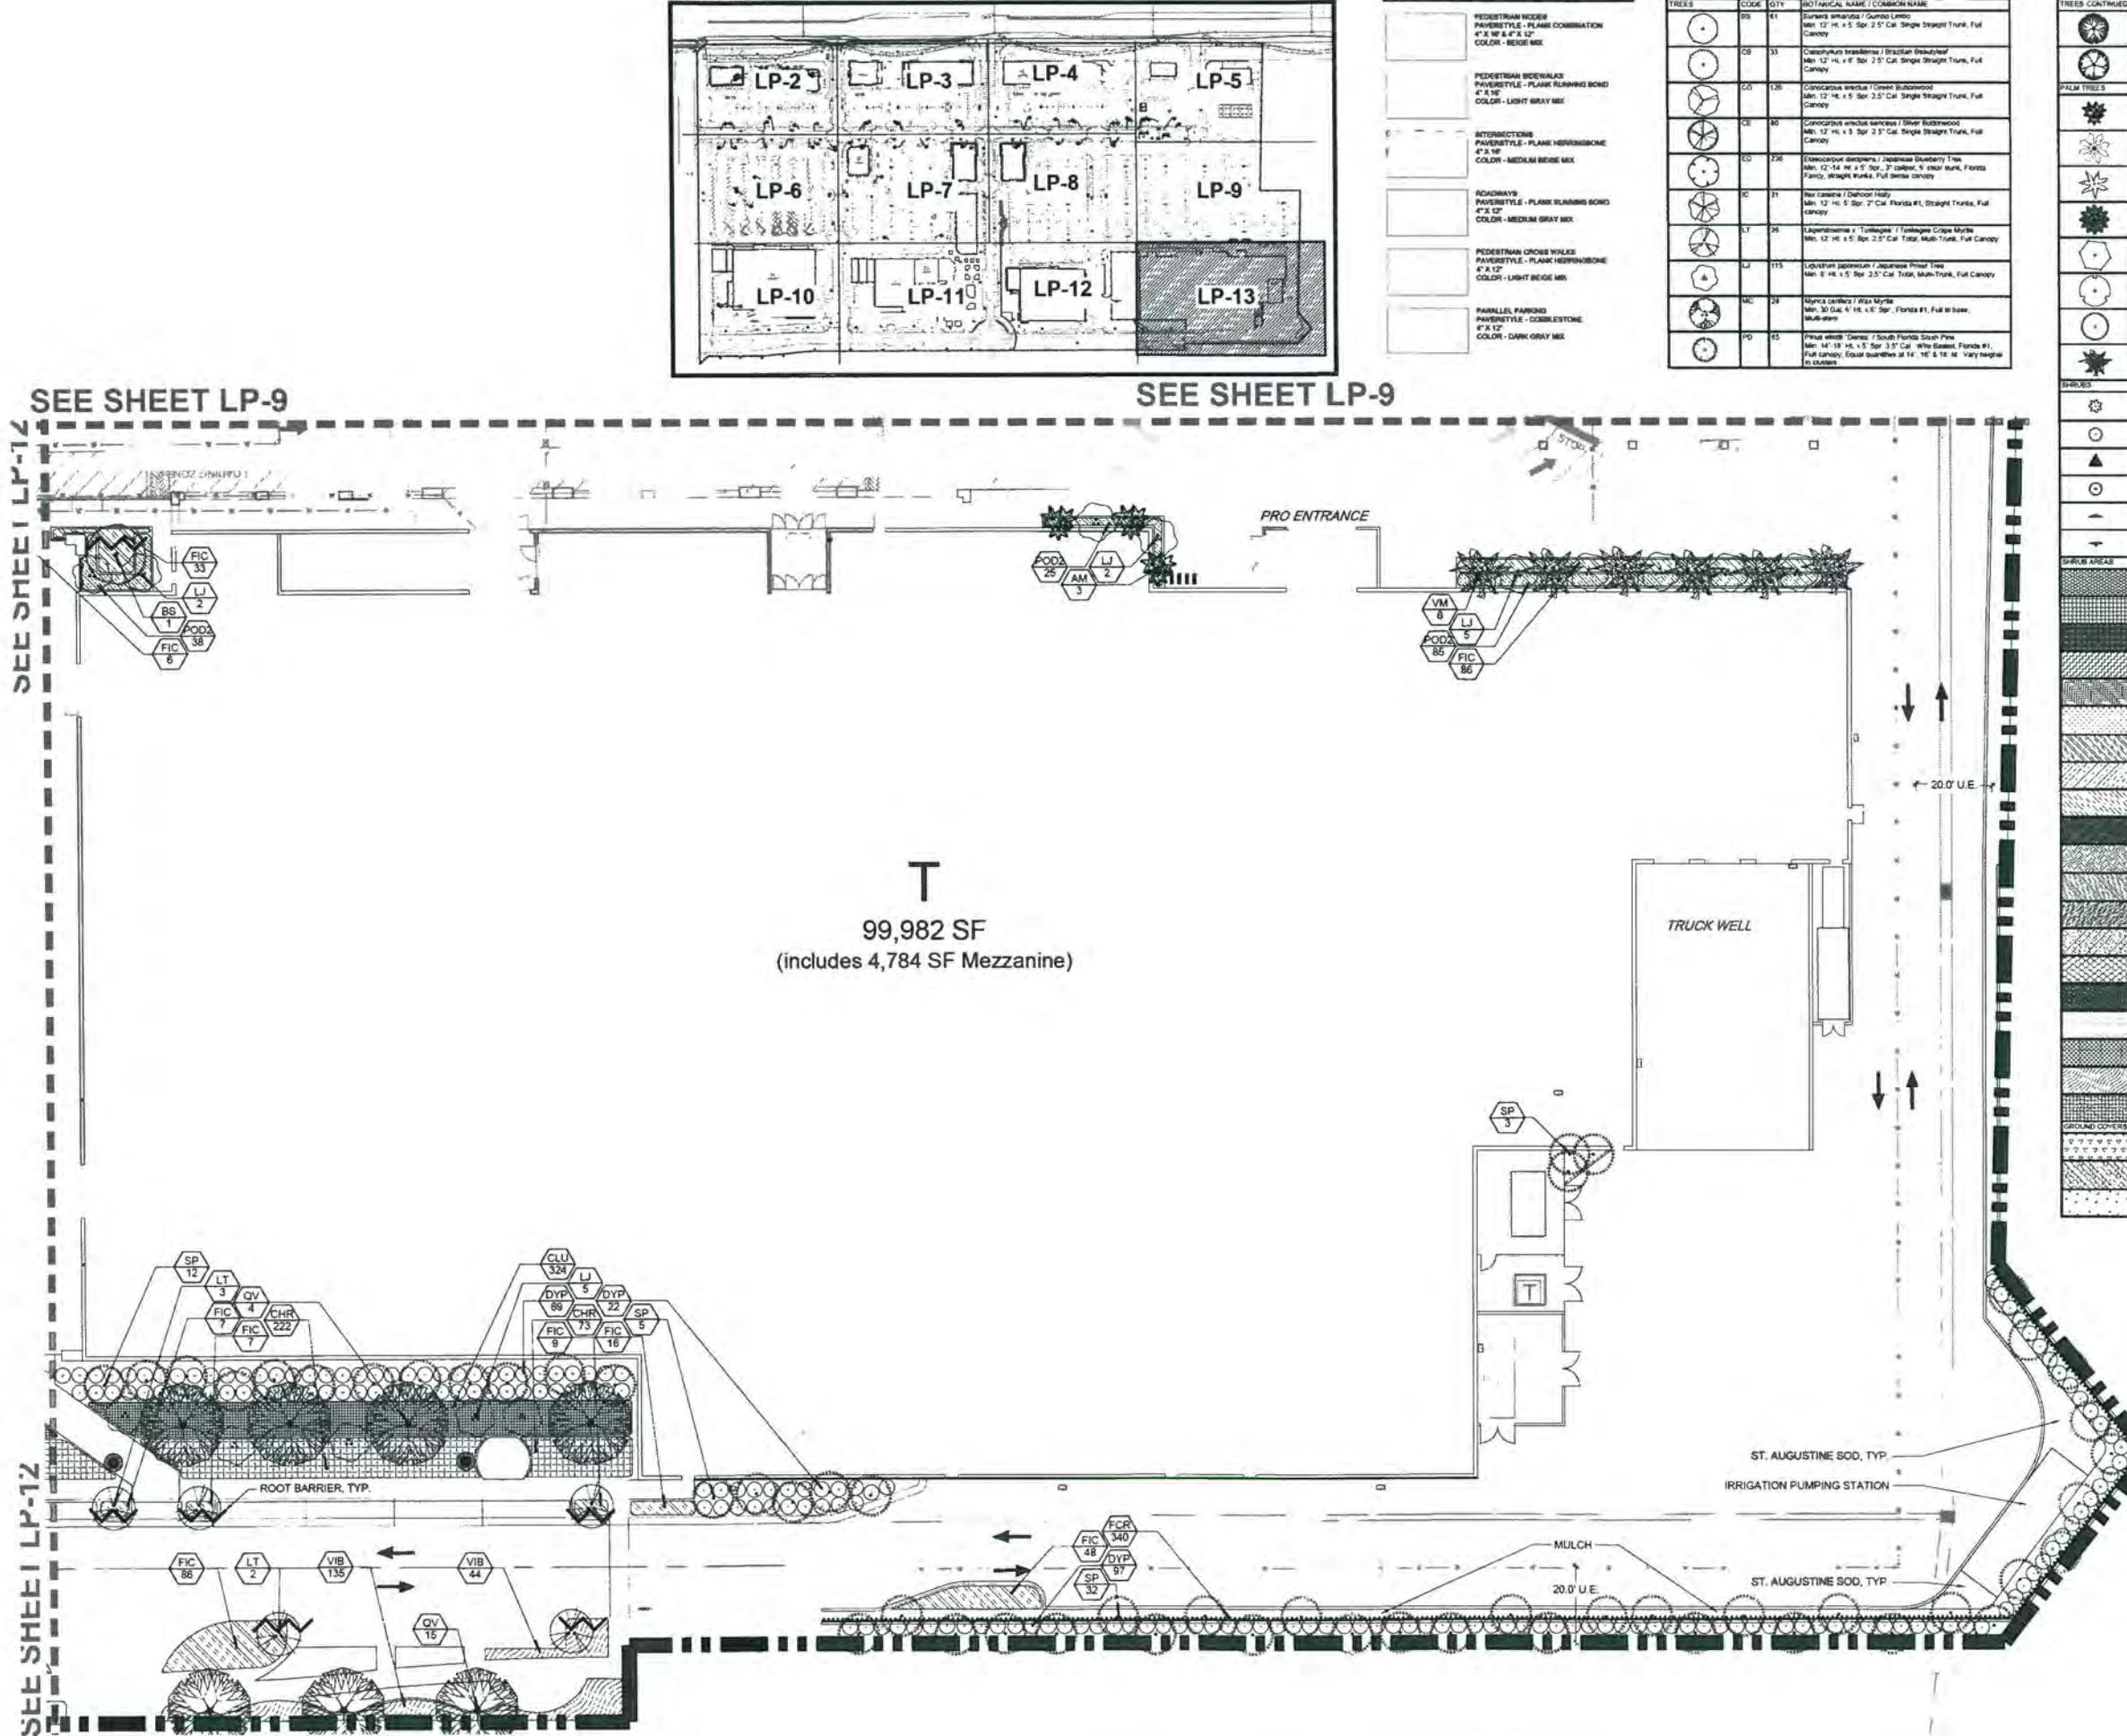

Alton Town Center Prepared for NADG & Brock Development Group

Palm Beach Gardens, Florida
Landscape Details
Drawing Name: H2015-0725-01-LP14-01



NORTH


Scale: 1" = 20'-0"

Date: 07-10-2015
Project No.: 88-039.020
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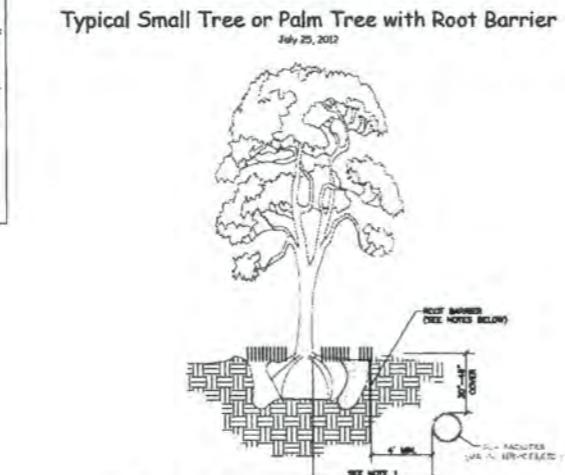
Root Barrier

Root Barrier Symbol





Typical Canopy Tree, Large or Exotic Palm Tree with Root Barrier

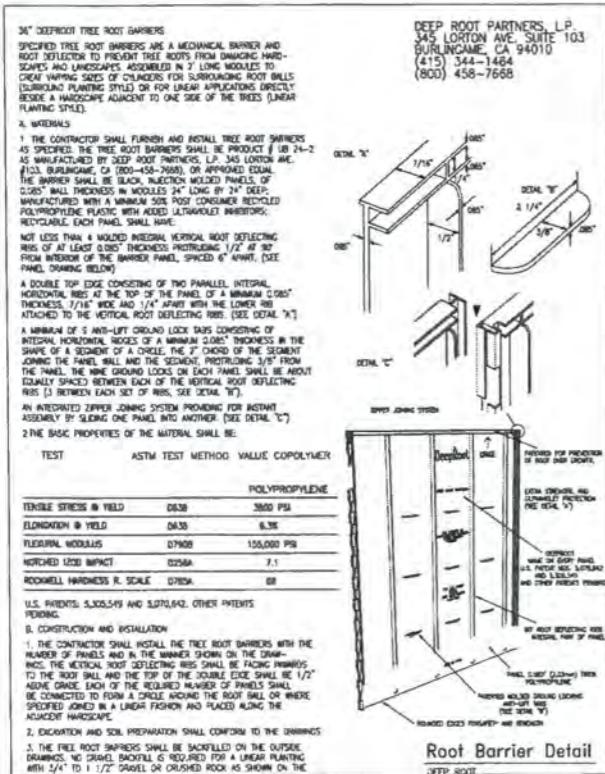July 25, 2012




Typical Small Tree or Palm Tree with Root Barrier

July 25, 2012

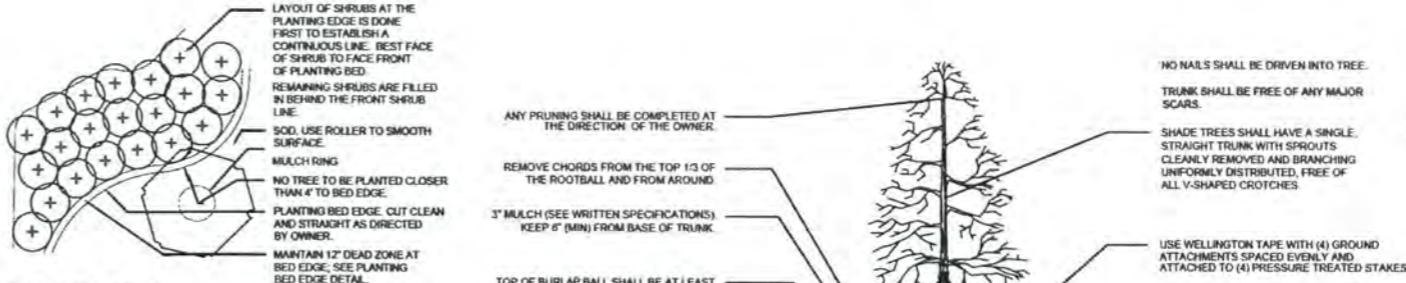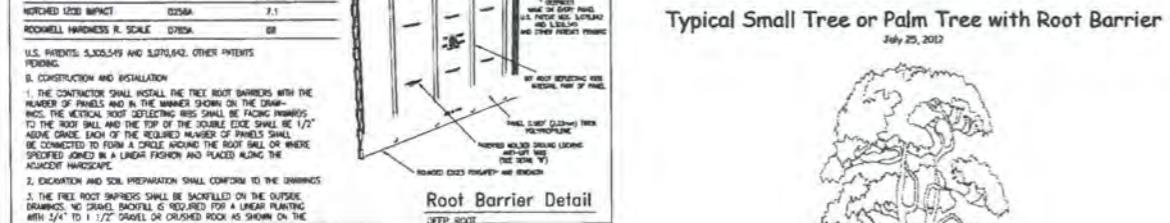

SHRUB AND GROUND COVER LAYOUT

N.T.S.

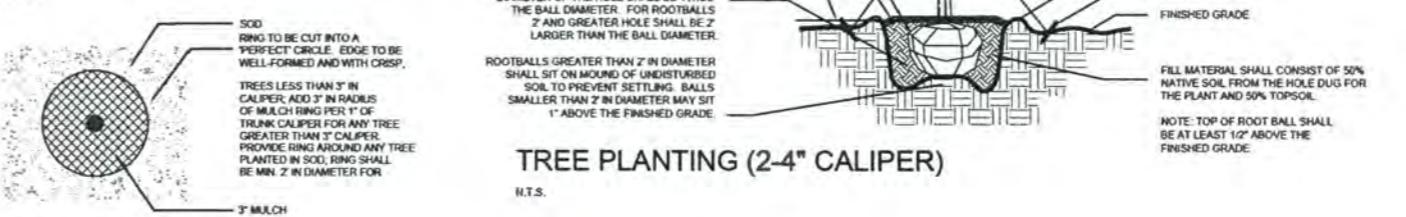

TREE PLANTING (2-4" CALIPER)

N.T.S.

MULCH RING

N.T.S.



GROUND COVERS AND ROOTED CUTTINGS

N.T.S.




IRREGULAR & MULTI-STEM TREE

N.T.S.

PLANTING BED EDGE

N.T.S.

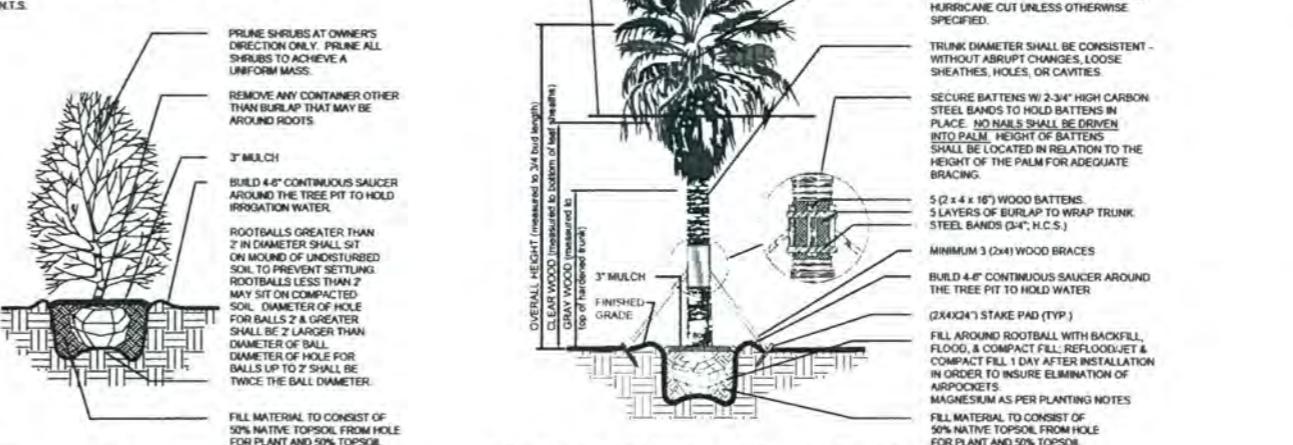

SHRUB PLANTING

N.T.S.

TYPICAL PALM TREE PLANTING

N.T.S.


Alton Town Center Prepared for NADG & Brock Development Group Palm Beach Gardens, Florida Landscape Specifications

Drawing number: HCD-16-0001 Date: 10/20/2016 Owner: NADG & Brock Development Group, LLC



www.callsunshine.com

Last updated March 2013

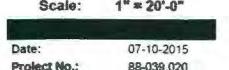

NORTH

Scale: 1" = 20'-0"

Date: 07-10-2015

Project No.: 88-039-020

Designed By: NM

Drawn By: LMB/KWK

Checked By: NM

Revision Dates:

02/17/2016 LMB CITY SUBMITTAL

02/09/2016 KWK CITY RESUBMITTAL

04/20/2016 KWK CITY RESUBMITTAL

06/29/2016 KWK CITY RESUBMITTAL

07/20/2016 KWK CITY RESUBMITTAL

09/06/2016 KWK CITY RESUBMITTAL

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02/17/2016 KWK CITY RESUBMITTAL

KRENT
WIELAND
DESIGN, INC.




KRENT WIELAND DESIGN, INC.
LANDSCAPE ARCHITECTURE

101 Southeast Second Avenue
Delray Beach, FL 33444
TEL: (561) 243-8773
FAX: (561) 243-8774
E-Mail: design@kwdesign.net
Krent L. Wieland, FL Reg LA 1039
Cart of Authorization: LC-26000275

Alton Town Center

Palm Beach Gardens, FL

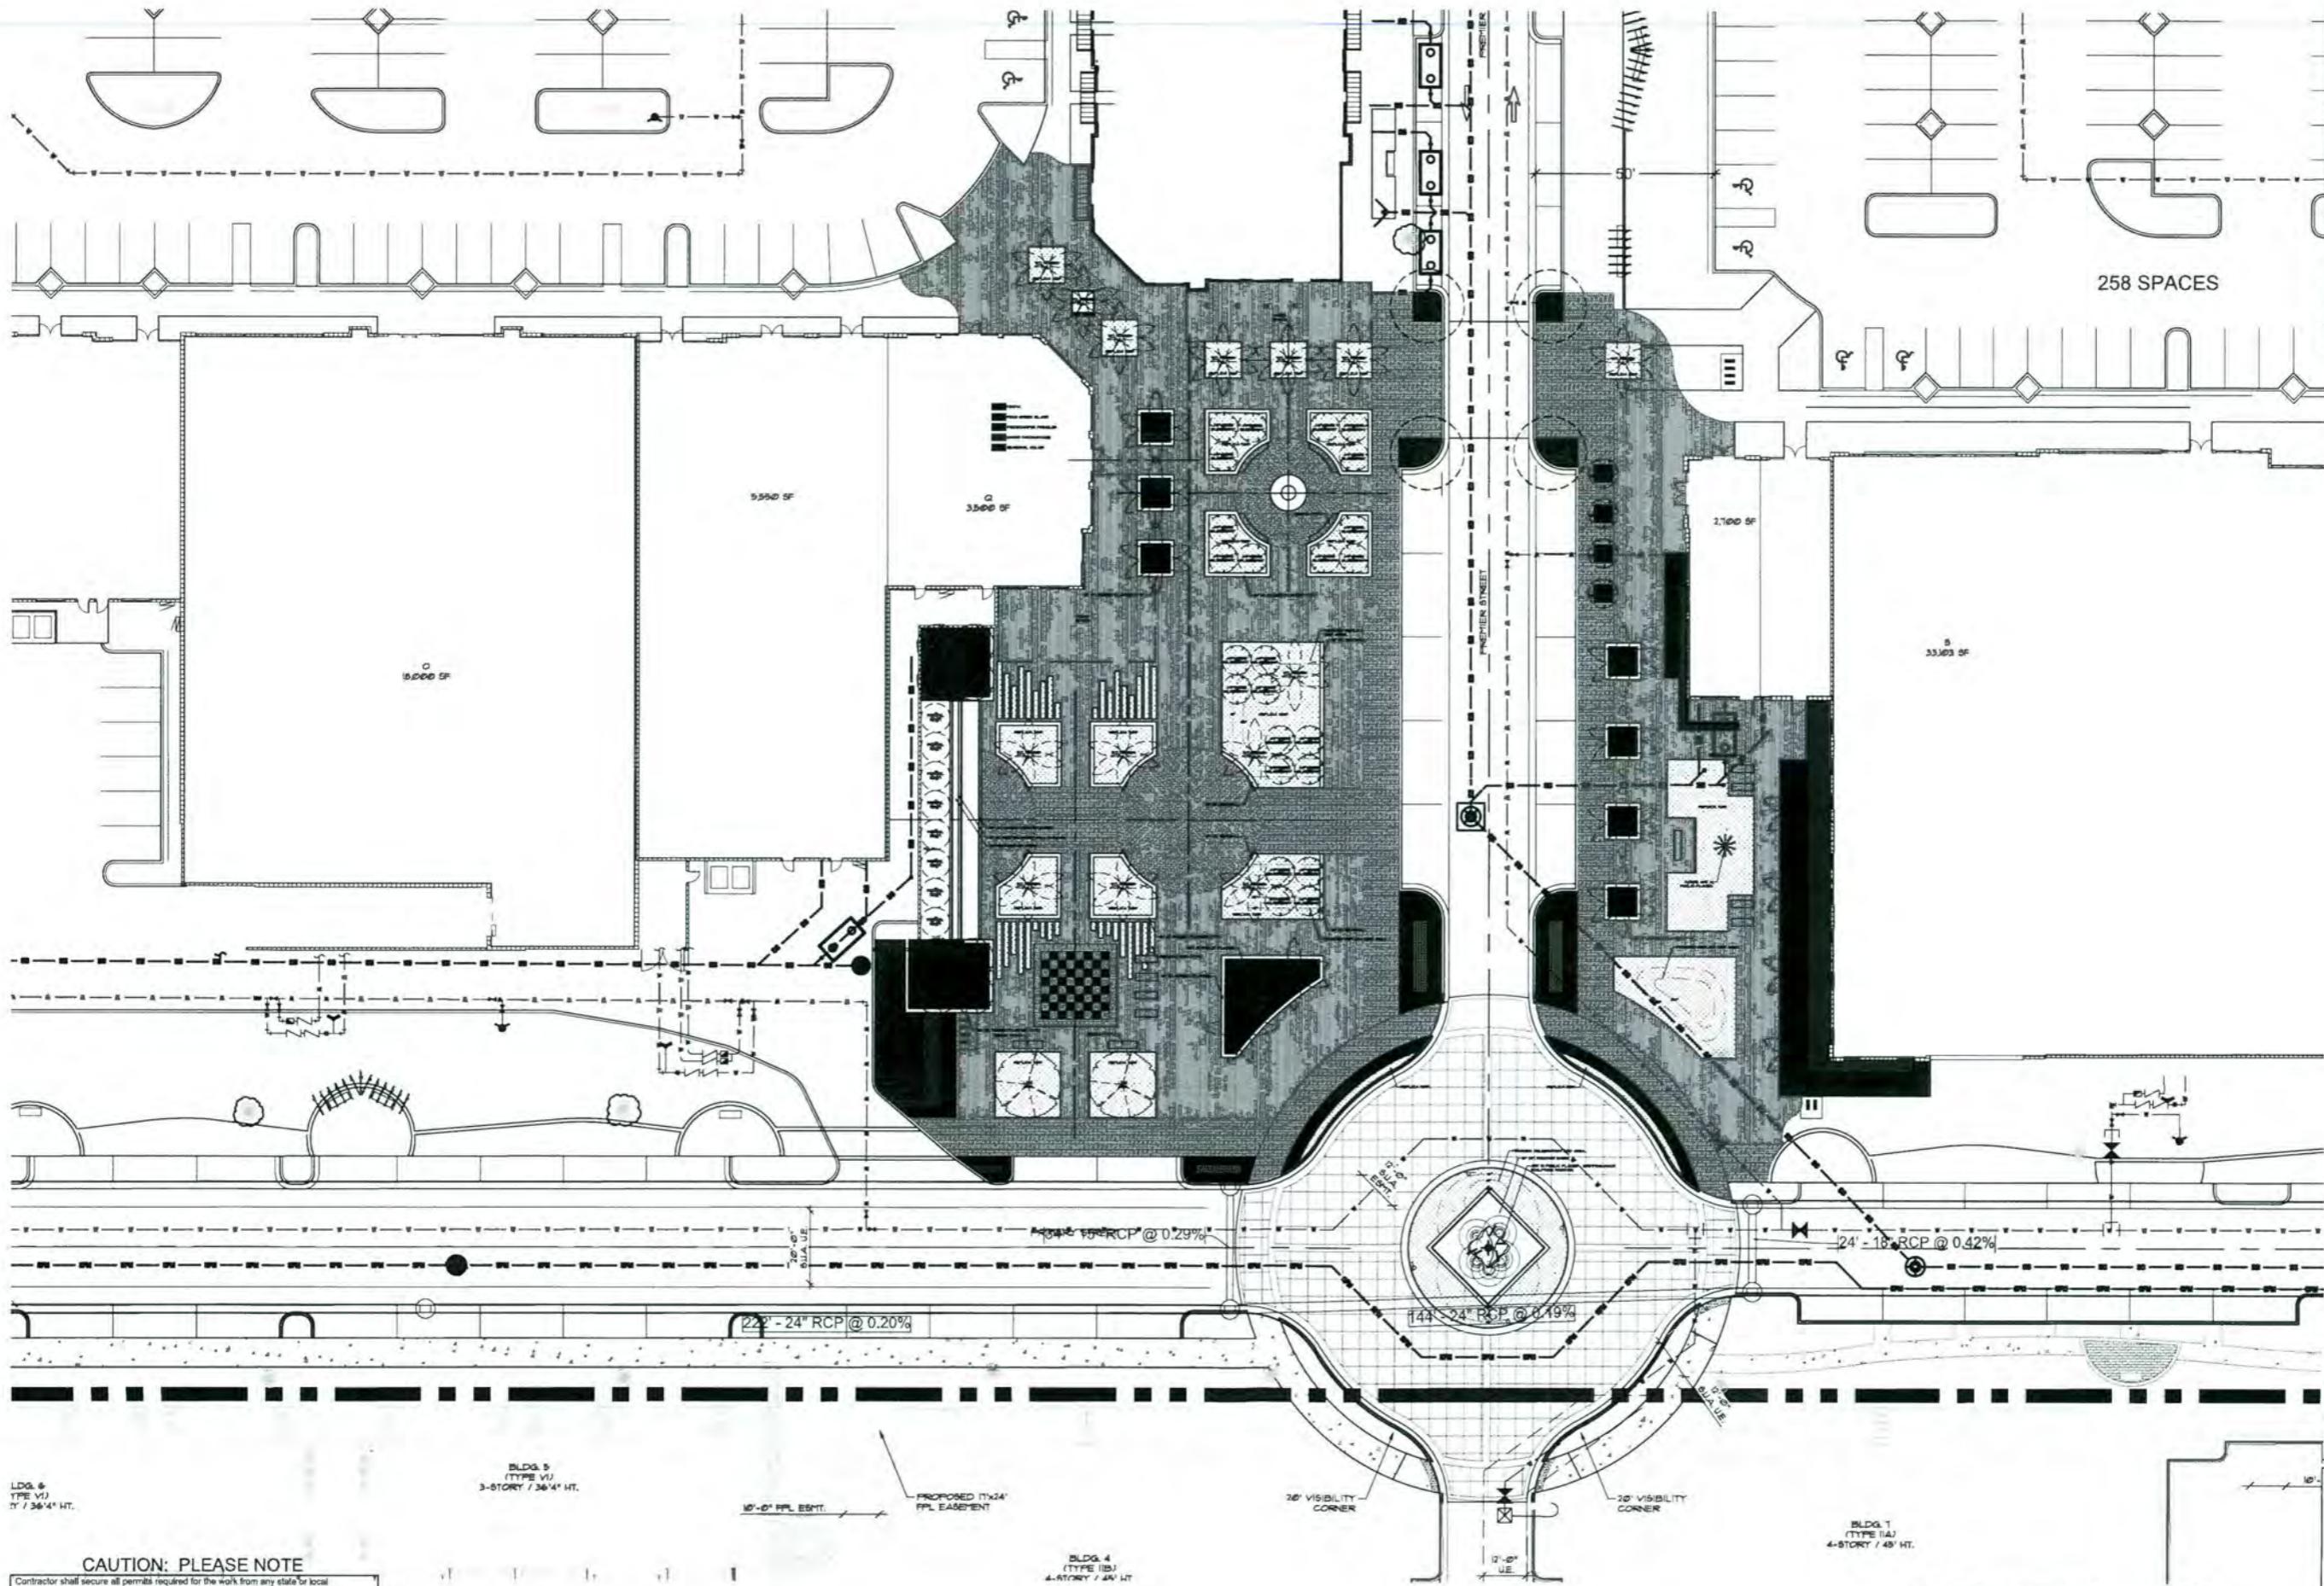

FOR SUBMISSION
07/15/16

0 10 20 30 40 50
SCALE 1' = 20' 0"



ISSUE HISTORY
COMM NO. 15022A
PROJ MGR. BD
DRAWN BY BD
CHECKED BY KW


DRAWING TITLE	CONCEPT PLAZA LAYOUT
Sheet	C-1

CAUTION: PLEASE NOTE

Contractor shall secure all permits required for the work from any state or local departments, utility companies or jurisdiction affected by the work. The Contractor shall have permits "in hand" prior to starting work. The Landscape Architect and/or Owner shall bear no responsibility for work performed without permitted drawings. The Contractor shall be responsible for all changes to Work, at no additional cost to Owner, as a result of unauthorized work prior to receipt of permit.

THIS DRAWING HAS NOT BEEN REVIEWED
BY A STRUCTURAL ENGINEER
VERIFY WITH STRUCTURAL ENGINEER
PRIOR TO CONSTRUCTION

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CONDITIONS:

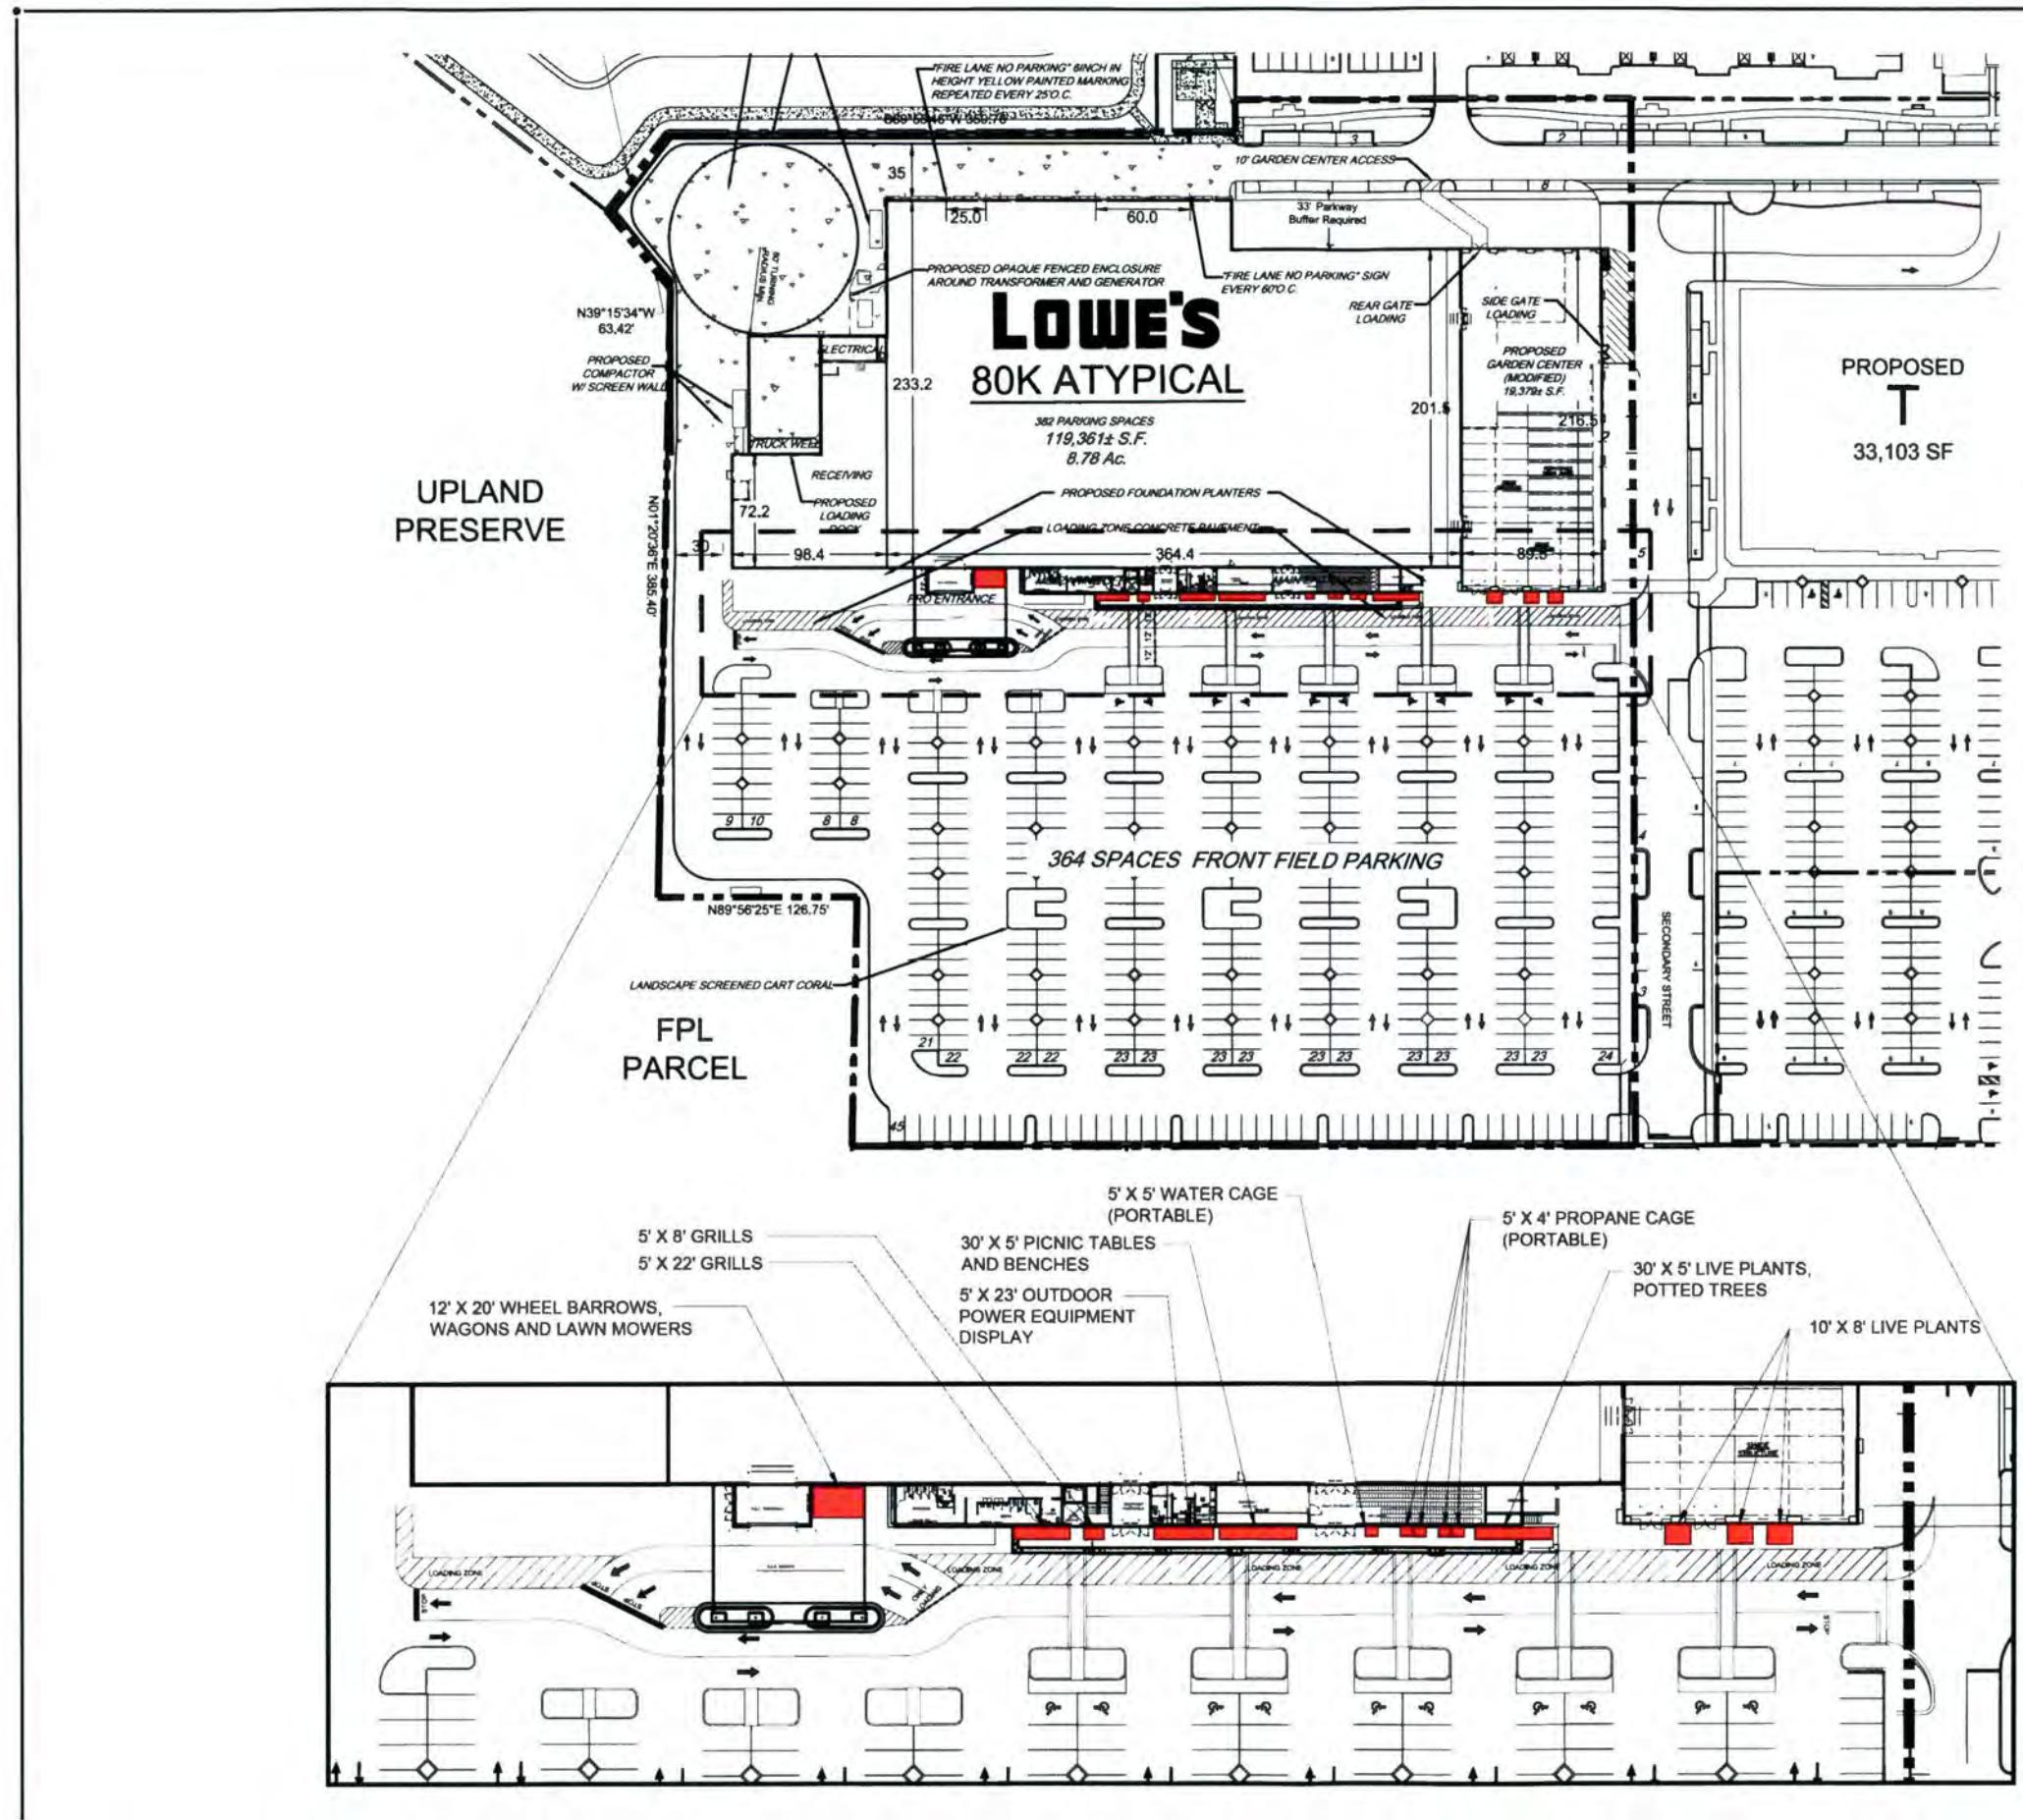1. WHERE OUTDOOR MATERIAL IS ALLOWED,
NO PRODUCT SHALL BE STACKED
GREATER THAN 8 FT. IN HEIGHT.

SUBJECT TO REVISIONS
PER CITY OF PALM BEACH
GARDENS REQUIREMENTS



NEW CONSTRUCTION FOR:
ALTON TOWN CENTER
 Palm Beach Gardens, Florida

SHEET INDEX


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ZONING RESUBMITTAL 09 06 16						
ARCHITECTURAL	GLIDDEN SPINA & PARTNERS					
CVR	COVER SHEET	01 06 16	04 15 16	06 29 16	07 20 16	
Z1-0	BUILDING A-(B)-C - FLOOR PLAN	01 06 16	04 15 16	06 29 16	07 20 16	
Z1.1	BUILDING A-(B)-C - ROOF PLAN	01 06 16	04 15 16	06 29 16	07 20 16	
Z1.2	BUILDING A-(B)-C - ELEVATIONS	01 06 16	04 15 16	06 29 16	07 20 16	
Z2.0	BUILDING D - PLANS	01 06 16	04 15 16	06 29 16	07 20 16	09 06 16
Z2.1	BUILDING D - ELEVATIONS	01 06 16	04 15 16	06 29 16	07 20 16	09 06 16
Z3.0	BUILDING E - PLANS	01 06 16	04 15 16	06 29 16	07 20 16	09 06 16
Z3.1	BUILDING E - ELEVATIONS	01 06 16	04 15 16	06 29 16	07 20 16	09 06 16
Z4.0	BUILDING F - PLANS	01 06 16	04 15 16	06 29 16	07 20 16	09 06 16
Z4.1	BUILDING F - ELEVATIONS	01 06 16	04 15 16	06 29 16	07 20 16	09 06 16
Z5.0	BUILDING G - PLANS	01 06 16	04 15 16	06 29 16	07 20 16	09 06 16
Z5.1	BUILDING G - ELEVATIONS	01 06 16	04 15 16	06 29 16	07 20 16	09 06 16
Z6.0	BUILDING H PLANS				07 20 16	09 06 16
Z6.1	BUILDING H - ELEVATIONS				07 20 16	09 06 16
Z7.0	BUILDING I - PLANS	01 06 16	04 15 16		07 20 16	09 06 16
Z7.1	BUILDING I - ELEVATIONS	01 06 16	04 15 16		07 20 16	09 06 16
Z8.0	BUILDING J - PLANS	01 06 16	04 15 16		07 20 16	09 06 16
Z8.1	BUILDING J - ELEVATIONS	01 06 16	04 15 16		07 20 16	09 06 16
Z9.0	BUILDING K - PLANS	01 06 16	04 15 16	06 29 16	07 20 16	
Z9.1	BUILDING K - ELEVATIONS	01 06 16	04 15 16	06 29 16	07 20 16	
Z10.0	NOT USED					
Z11.0	BUILDING L-M - PLANS	01 06 16	04 15 16	06 29 16	07 20 16	
Z11.1	BUILDING L-M - ELEVATIONS	01 06 16	04 15 16	06 29 16	07 20 16	
Z12.0	BUILDING N - PLANS	01 06 16	04 15 16	06 29 16	07 20 16	09 06 16
Z12.1	BUILDING N - ELEVATIONS	01 06 16	04 15 16	06 29 16	07 20 16	09 06 16
Z13.0	BUILDING O / P / Q - FLOOR PLAN	01 06 16	04 15 16	06 29 16	07 20 16	09 06 16
Z13.1	BUILDING O / P / Q - ROOF PLAN	01 06 16	04 15 16	06 29 16	07 20 16	09 06 16
Z13.2	BUILDING O / P / Q - ELEVATIONS	01 06 16	04 15 16	06 29 16	07 20 16	09 06 16
Z14.0	BUILDING R - PLANS	01 06 16	04 15 16	06 29 16	07 20 16	
Z14.1	BUILDING R - ELEVATIONS	01 06 16	04 15 16	06 29 16	07 20 16	
Z15.0	BUILDING S - FLOOR PLAN	01 06 16	04 15 16	06 29 16	07 20 16	
Z15.1	BUILDING S - ROOF PLAN	01 06 16	04 15 16	06 29 16	07 20 16	
Z15.2	BUILDING S - ELEVATIONS	01 06 16	04 15 16	06 29 16	07 20 16	
Z16.1	TRELLIS - PLANS			06 29 16	07 20 16	
Z16.2	TRELLIS X - ELEVATIONS			06 29 16	07 20 16	



NOTE - RESTROOMS SHOW ONLY IN SMALLER SPEC TENANT SPACES. ALL BUILDINGS WITHOUT RESTROOMS SHOWN WILL HAVE RESTROOMS LOCATED BY TENANT LAYOUT

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BUILDING A/(B)/C - FLOOR PLAN

ZONING SUBMITTAL

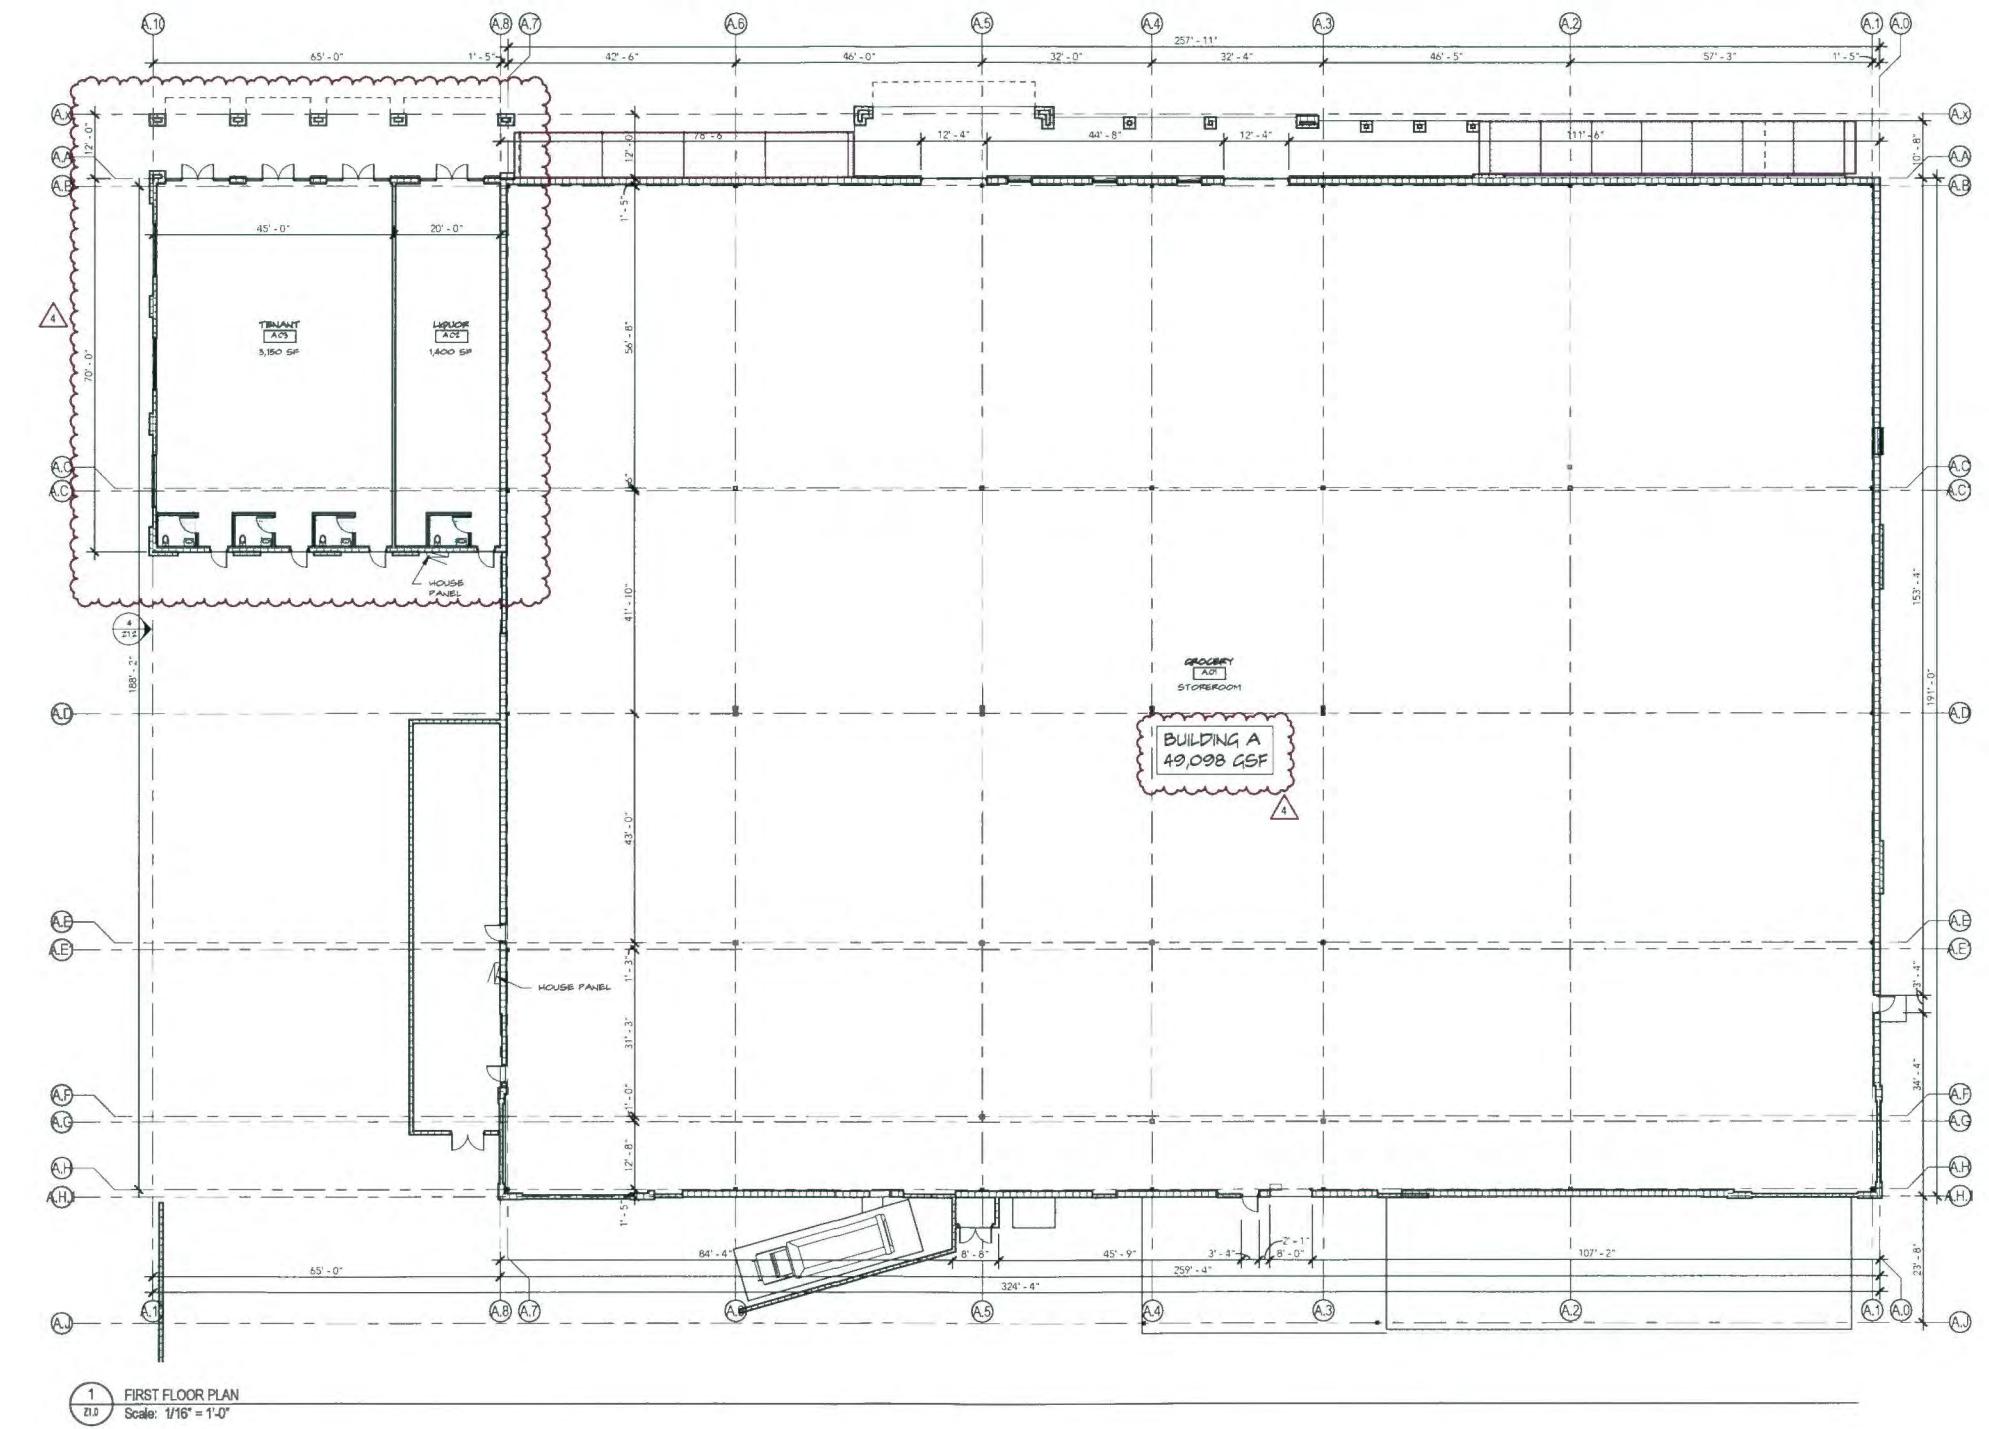NEW CONSTRUCTION FOR:
ALTON TOWN CENTER
BUILDING A/(B)/C
PALM BEACH GARDENS, FLORIDA

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Revisions:
1 REVISION TO 010616 SUBMITTAL
2 REVISION TO 041516 SUBMITTAL
3 REVISION TO 062916 SUBMITTAL
4 REVISION TO 072016 SUBMITTAL

Project no.: 13273
Date: 07/10/2015
Drawn by: AC
Project Architect: AC
Partner: KAS




Z1.0

ZONING SUBMITTAL

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West Palm Beach Florida 33401
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BUILDING A(B)/C - ROOF PLAN

Project no. 13273
Date: 07/10/2015
Drawn by: AC
Project Architect: AC
Partner: KAS
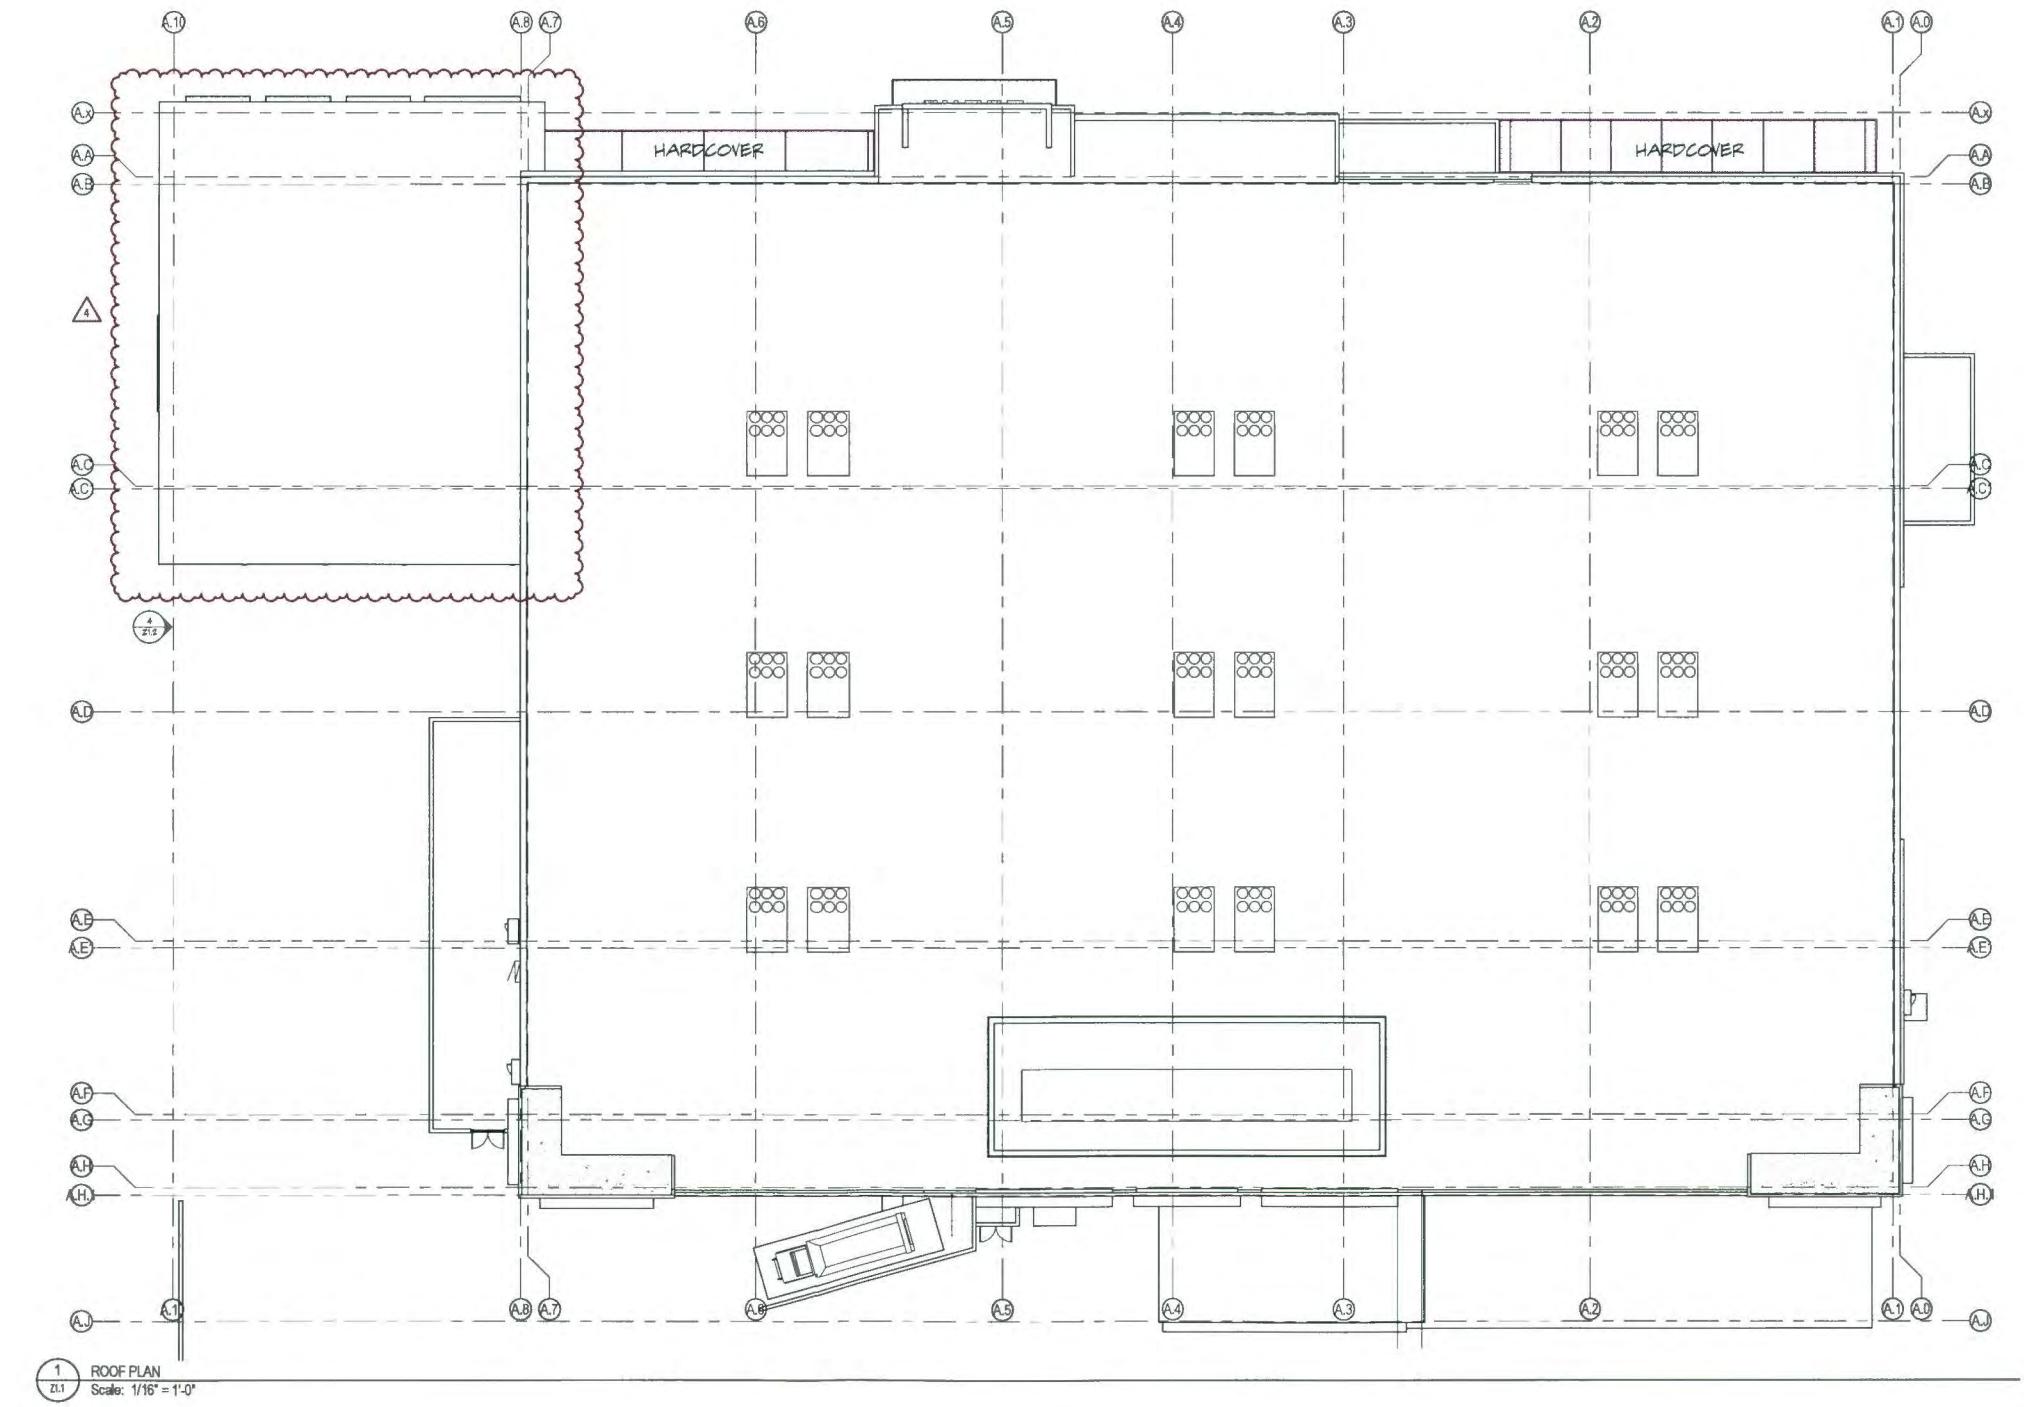
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SUBMITTAL
- 2 REVISION TO 04/15/16
SUBMITTAL
- 3 REVISION TO 06/29/16
SUBMITTAL
- 4 REVISION TO 07/20/16
SUBMITTAL

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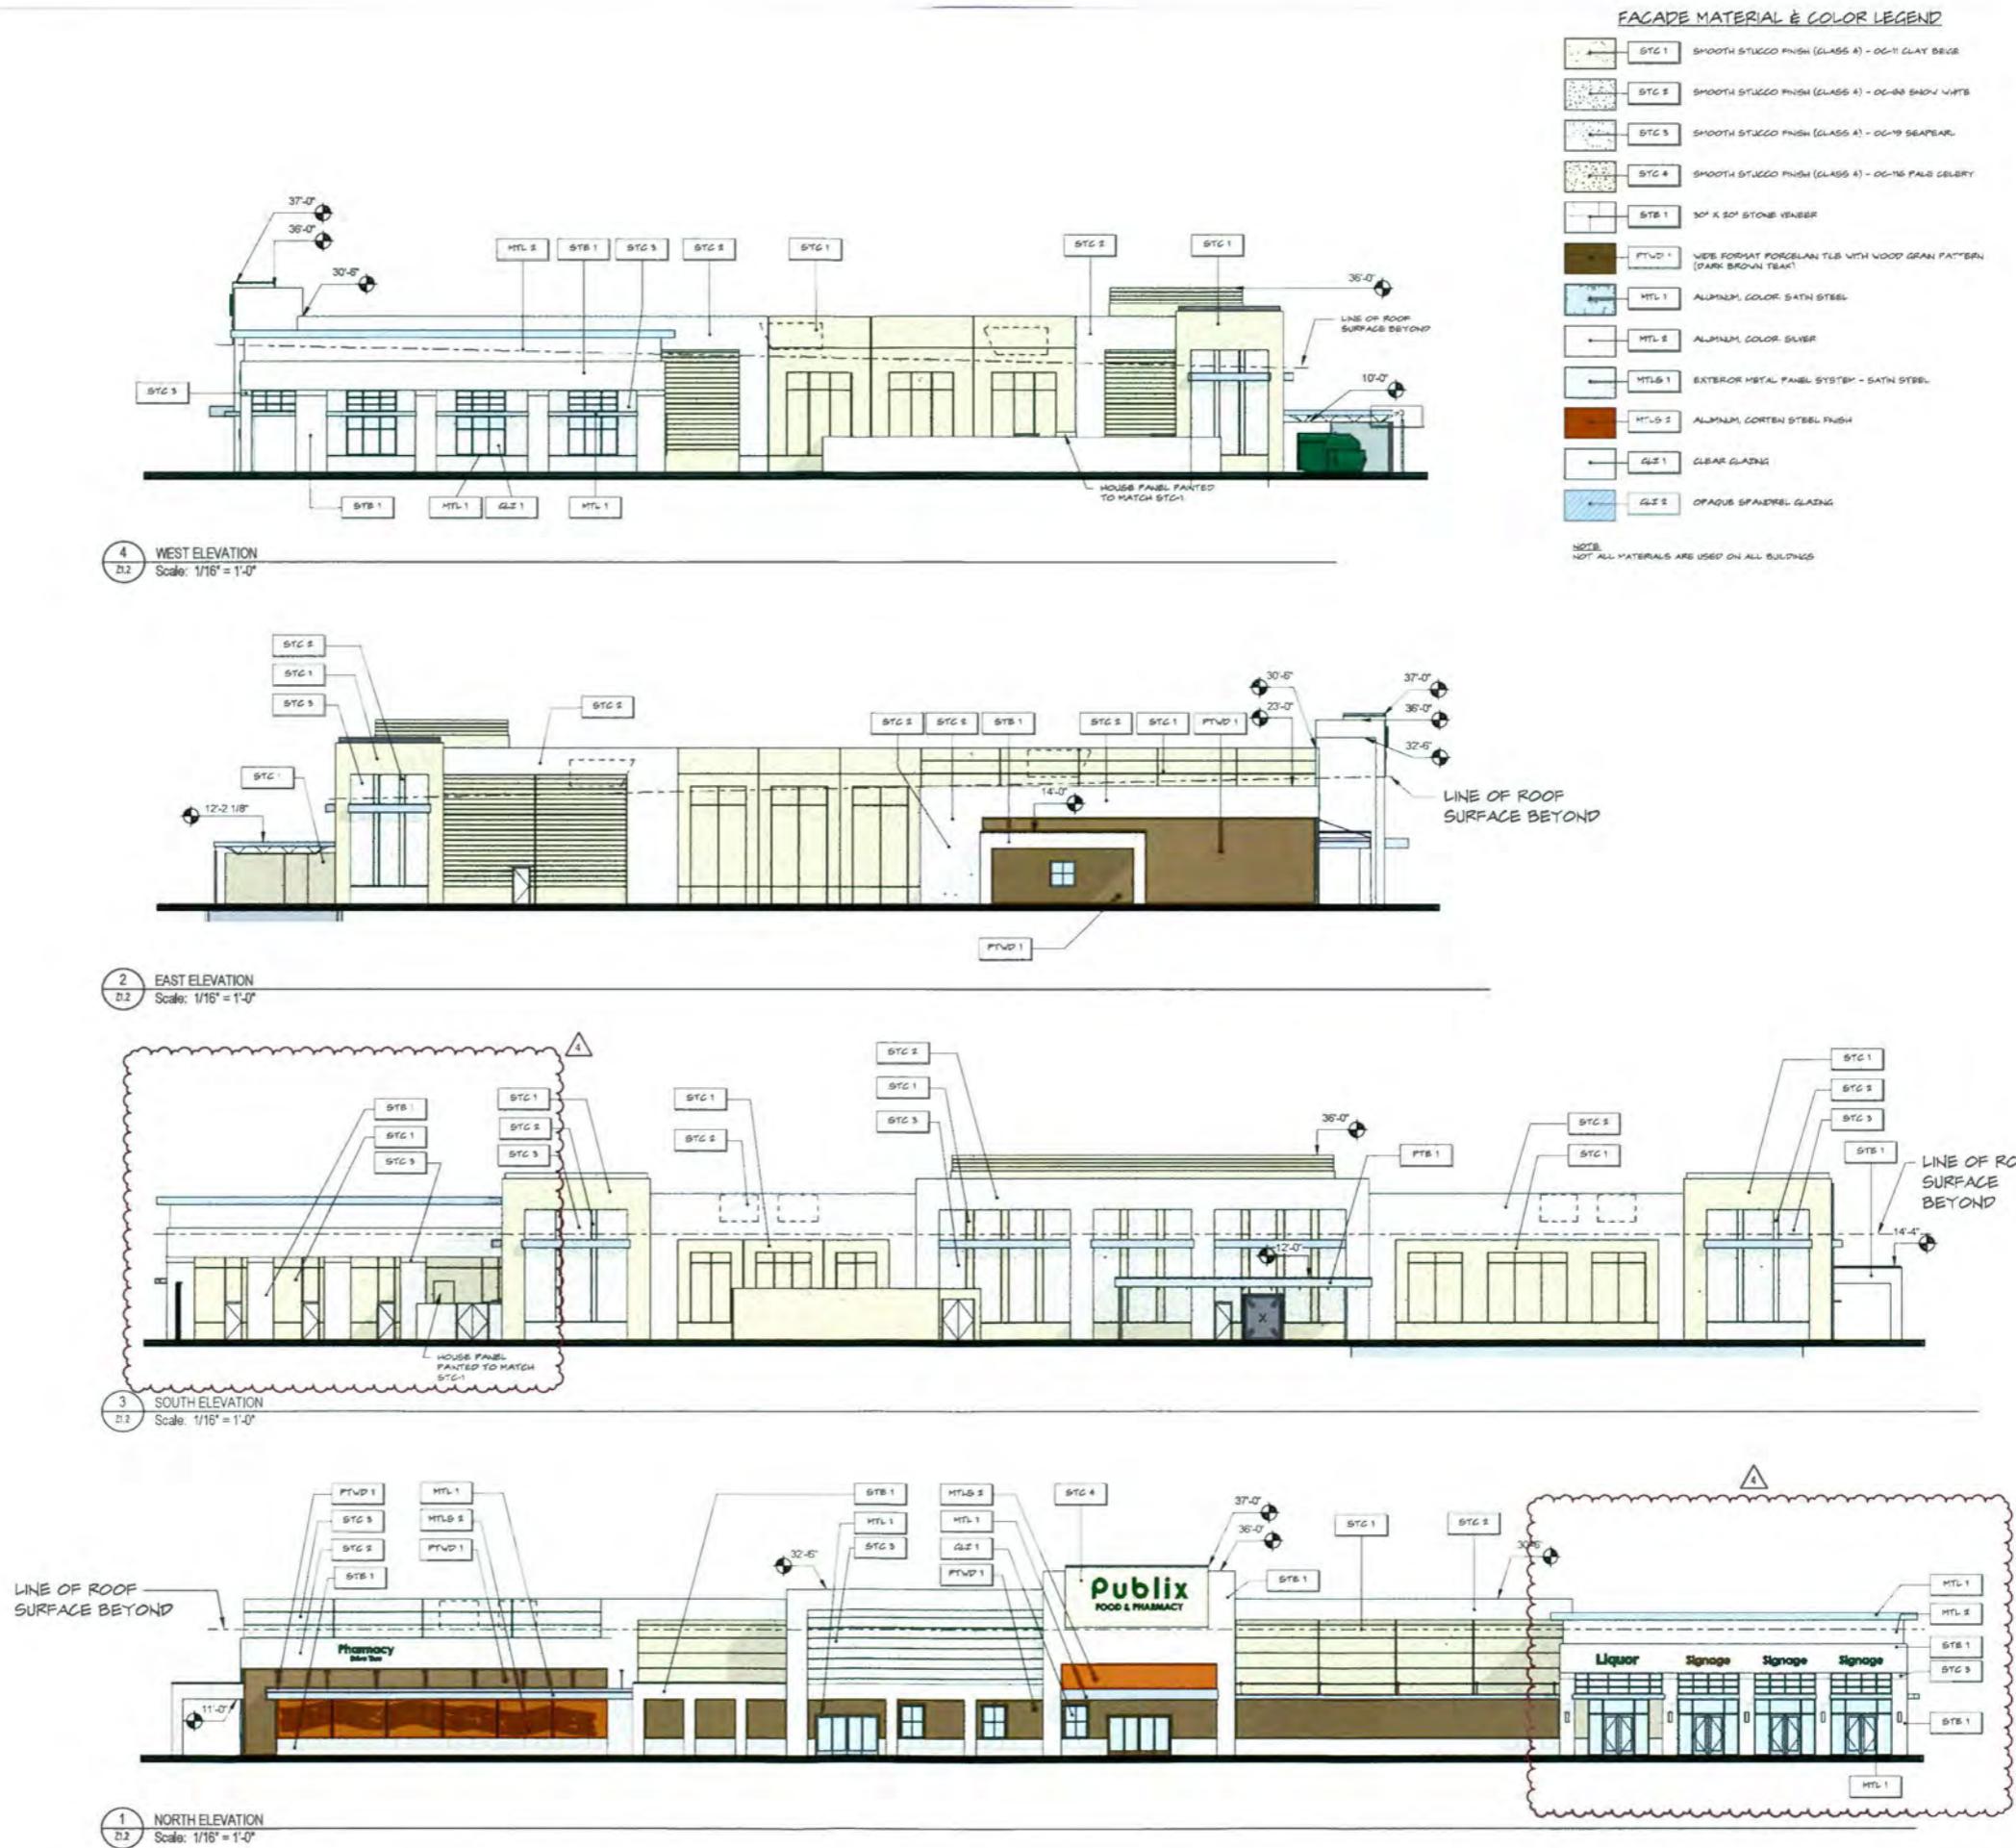
NEW CONSTRUCTION FOR:
ALTON TOWN CENTER
BUILDING A(B)/C
PALM BEACH GARDENS, FLORIDA

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West Palm Beach Florida 33401
561.684.6844 • Fax 561.684.5594
gliddenspina.com
Fl. Lic. #AC202399

Architecture + Interior Design
John Glidden • Ruth M. Spina • Al 319



7/19/2016 3:00:56 PM



Da
Dr
Pr
Pa

Project No: 13273
Date: 07/10/2015
Drawn by: AC
Project Architect: AC
Partner: KAS



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Architecture+Interior Design
John Olden & Associates • Keith M. Spina # ARI3419

NEW CONSTRUCTION FOR:
ALTON TOWN CENTER
BUILDING A/(B/C)

ZONING SUBMIT



BUILDING D - PLANS

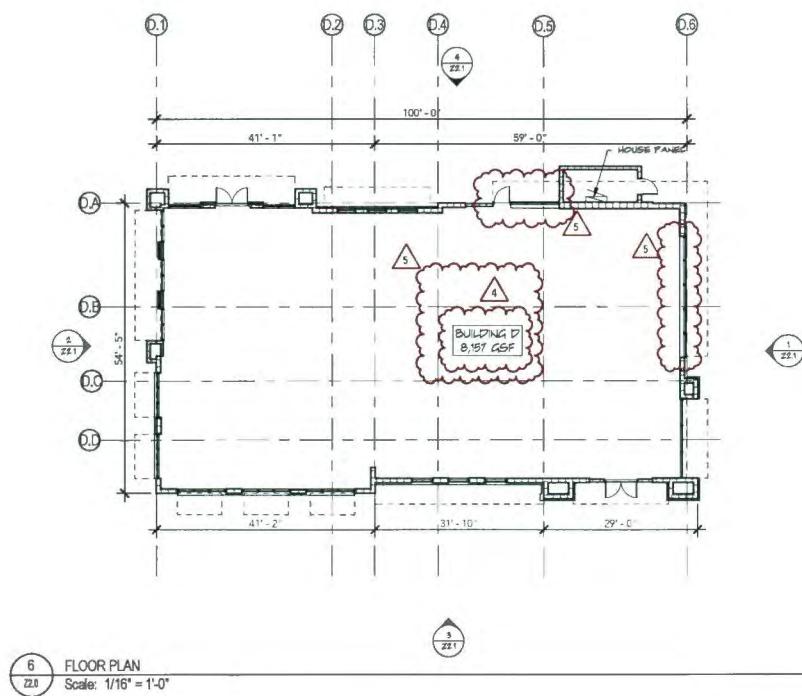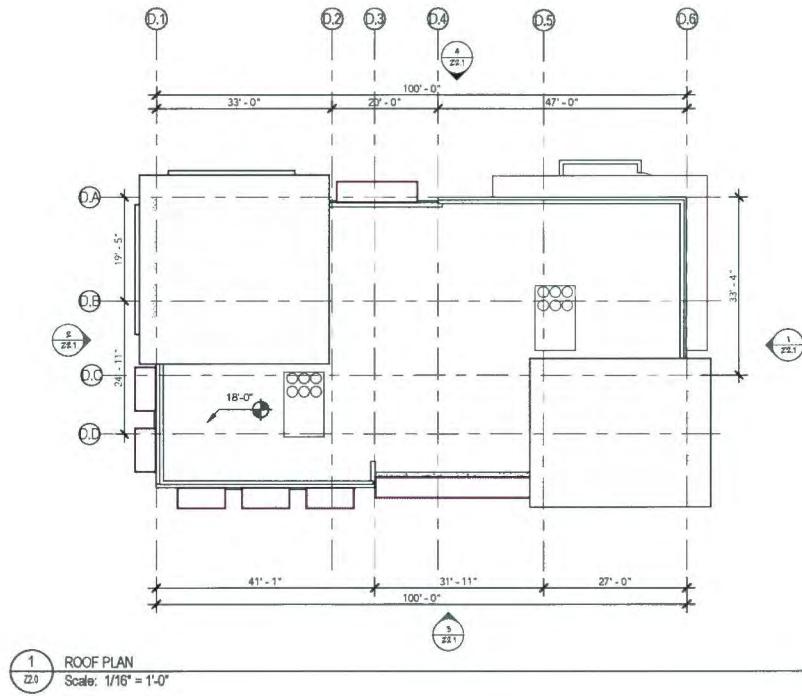ZONING SUBMITTAL

NEW CONSTRUCTION FOR:
ALTON TOWN CENTER
BUILDING D
PALM BEACH GARDENS, FLORIDA

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- 2 REVISION TO 04.15.16
- 3 REVISION TO 06.29.16
- 4 REVISION TO 07.20.16
- 5 REVISION TO 09.06.16

Project no.: 13273
Date: 07/10/2015
Drawn by: MA
Project Architect: AC
Partner: KAS



Z2.0

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ALTON TOWN CENTER
BUILDING D
PALM BEACH GARDENS, FLORIDA

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VISION TO	06-29-16
UBMITTAL	
VISION TO	07-20-16
UBMITTAL	
VISION TO	9-08-16
UBMITTAL	

ject no: 13273
e: 07/10/2015
own by: MA

Project Architect: AC
Partner: KAS

13

N

W E

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Page 1

10 of 10


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10 of 10

ZONING SUBMITTAL



BUILDING E - PLANS

Z3.0
ZONING SUBMITTAL

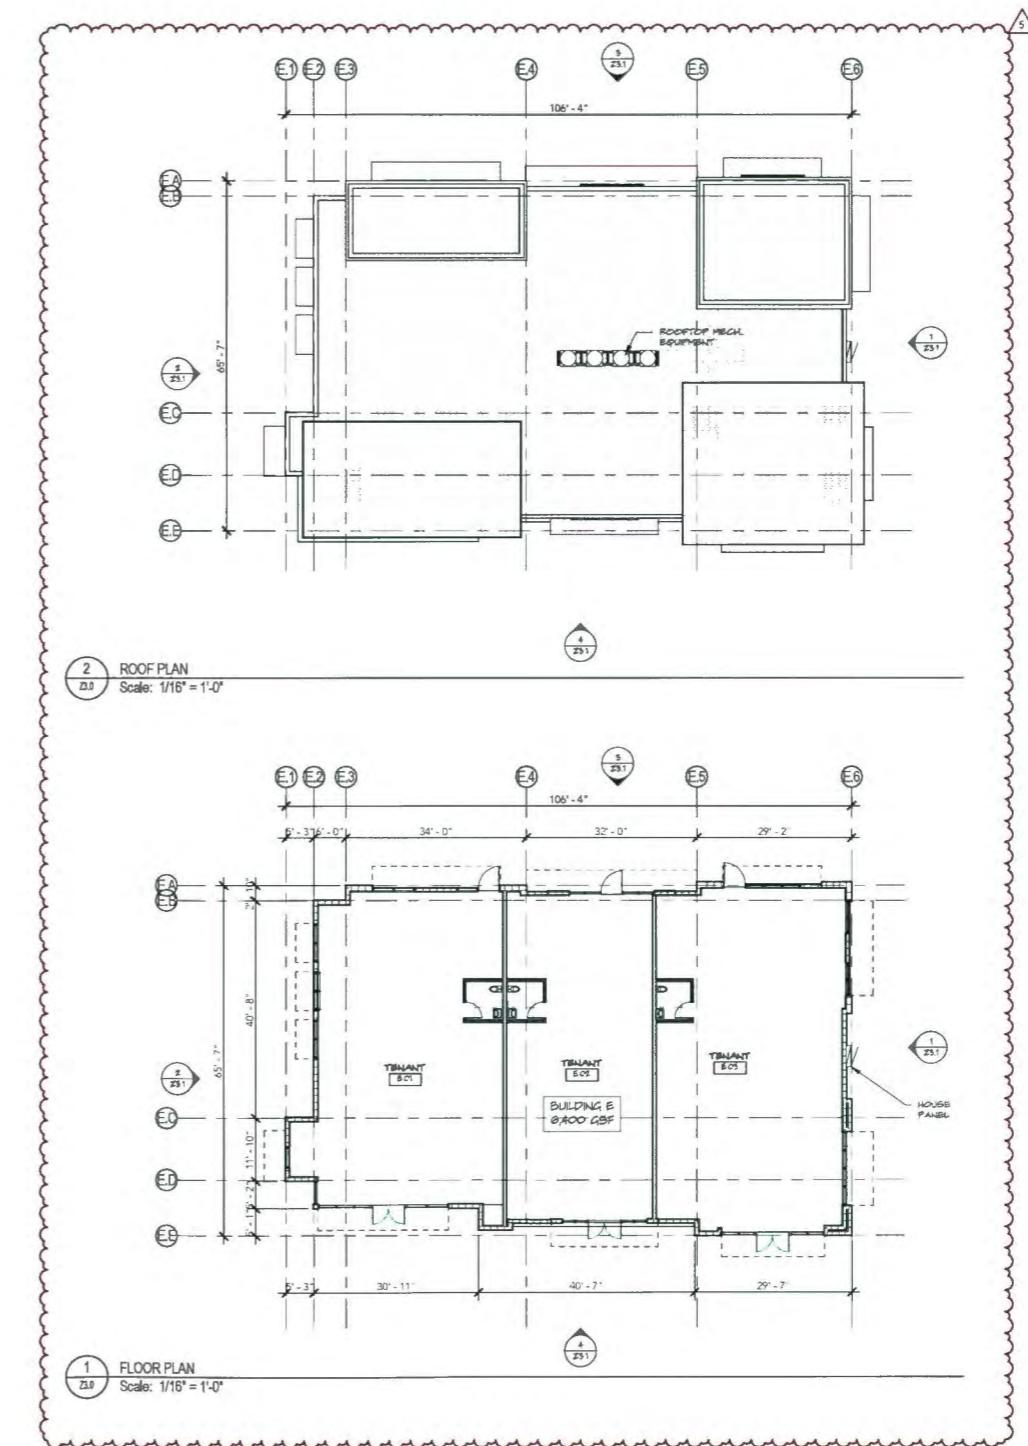PROPOSED NEW CONSTRUCTION:
ALTON TOWN CENTER
BUILDING E
PALM BEACH GARDENS, FLORIDA

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3 REVISION TO 06.29.16 SUBMITTAL
4 REVISION TO 07.20.16 SUBMITTAL
5 REVISION TO 09.06.16 SUBMITTAL

Project no.: 13273
Date: 07/10/2015
Drawn by: MA
Project Architect: AC
Partner: KS




Z3.0

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gliddenspina.com
PLC • AIA/SA/ASID/CIPI

**FAÇADE MATERIAL & COLOR LEGEND**

STG 1	SMOOTH STUCCO FINISH (CLASS A) - OC-11 CLAY BRIGE
STG 2	SMOOTH STUCCO FINISH (CLASS A) - OC-08 SNOW WHITE
STG 3	SMOOTH STUCCO FINISH (CLASS A) - OC-18 SEA PEARL
STG 4	SMOOTH STUCCO FINISH (CLASS A) - OC-14 PALE CELERY
STB 1	30" X 80" STONE VENEER
MTL 1	LIDS FORMAT PORCELAIN TILE WITH WOOD GRAIN PATTERN (DARK BROWN TEAK)
MTL 2	ALUMINUM, COLOR SATIN STEEL
MTL 3	ALUMINUM, COLOR SILVER
MTL 4	EXTERIOR METAL PANEL SYSTEM - SATIN STEEL
MTL 5	ALUMINUM, CORTEEN STEEL FINISH
GLZ 1	CLEAR GLAZING
GLZ 2	OPAQUE SPANDREL GLAZING

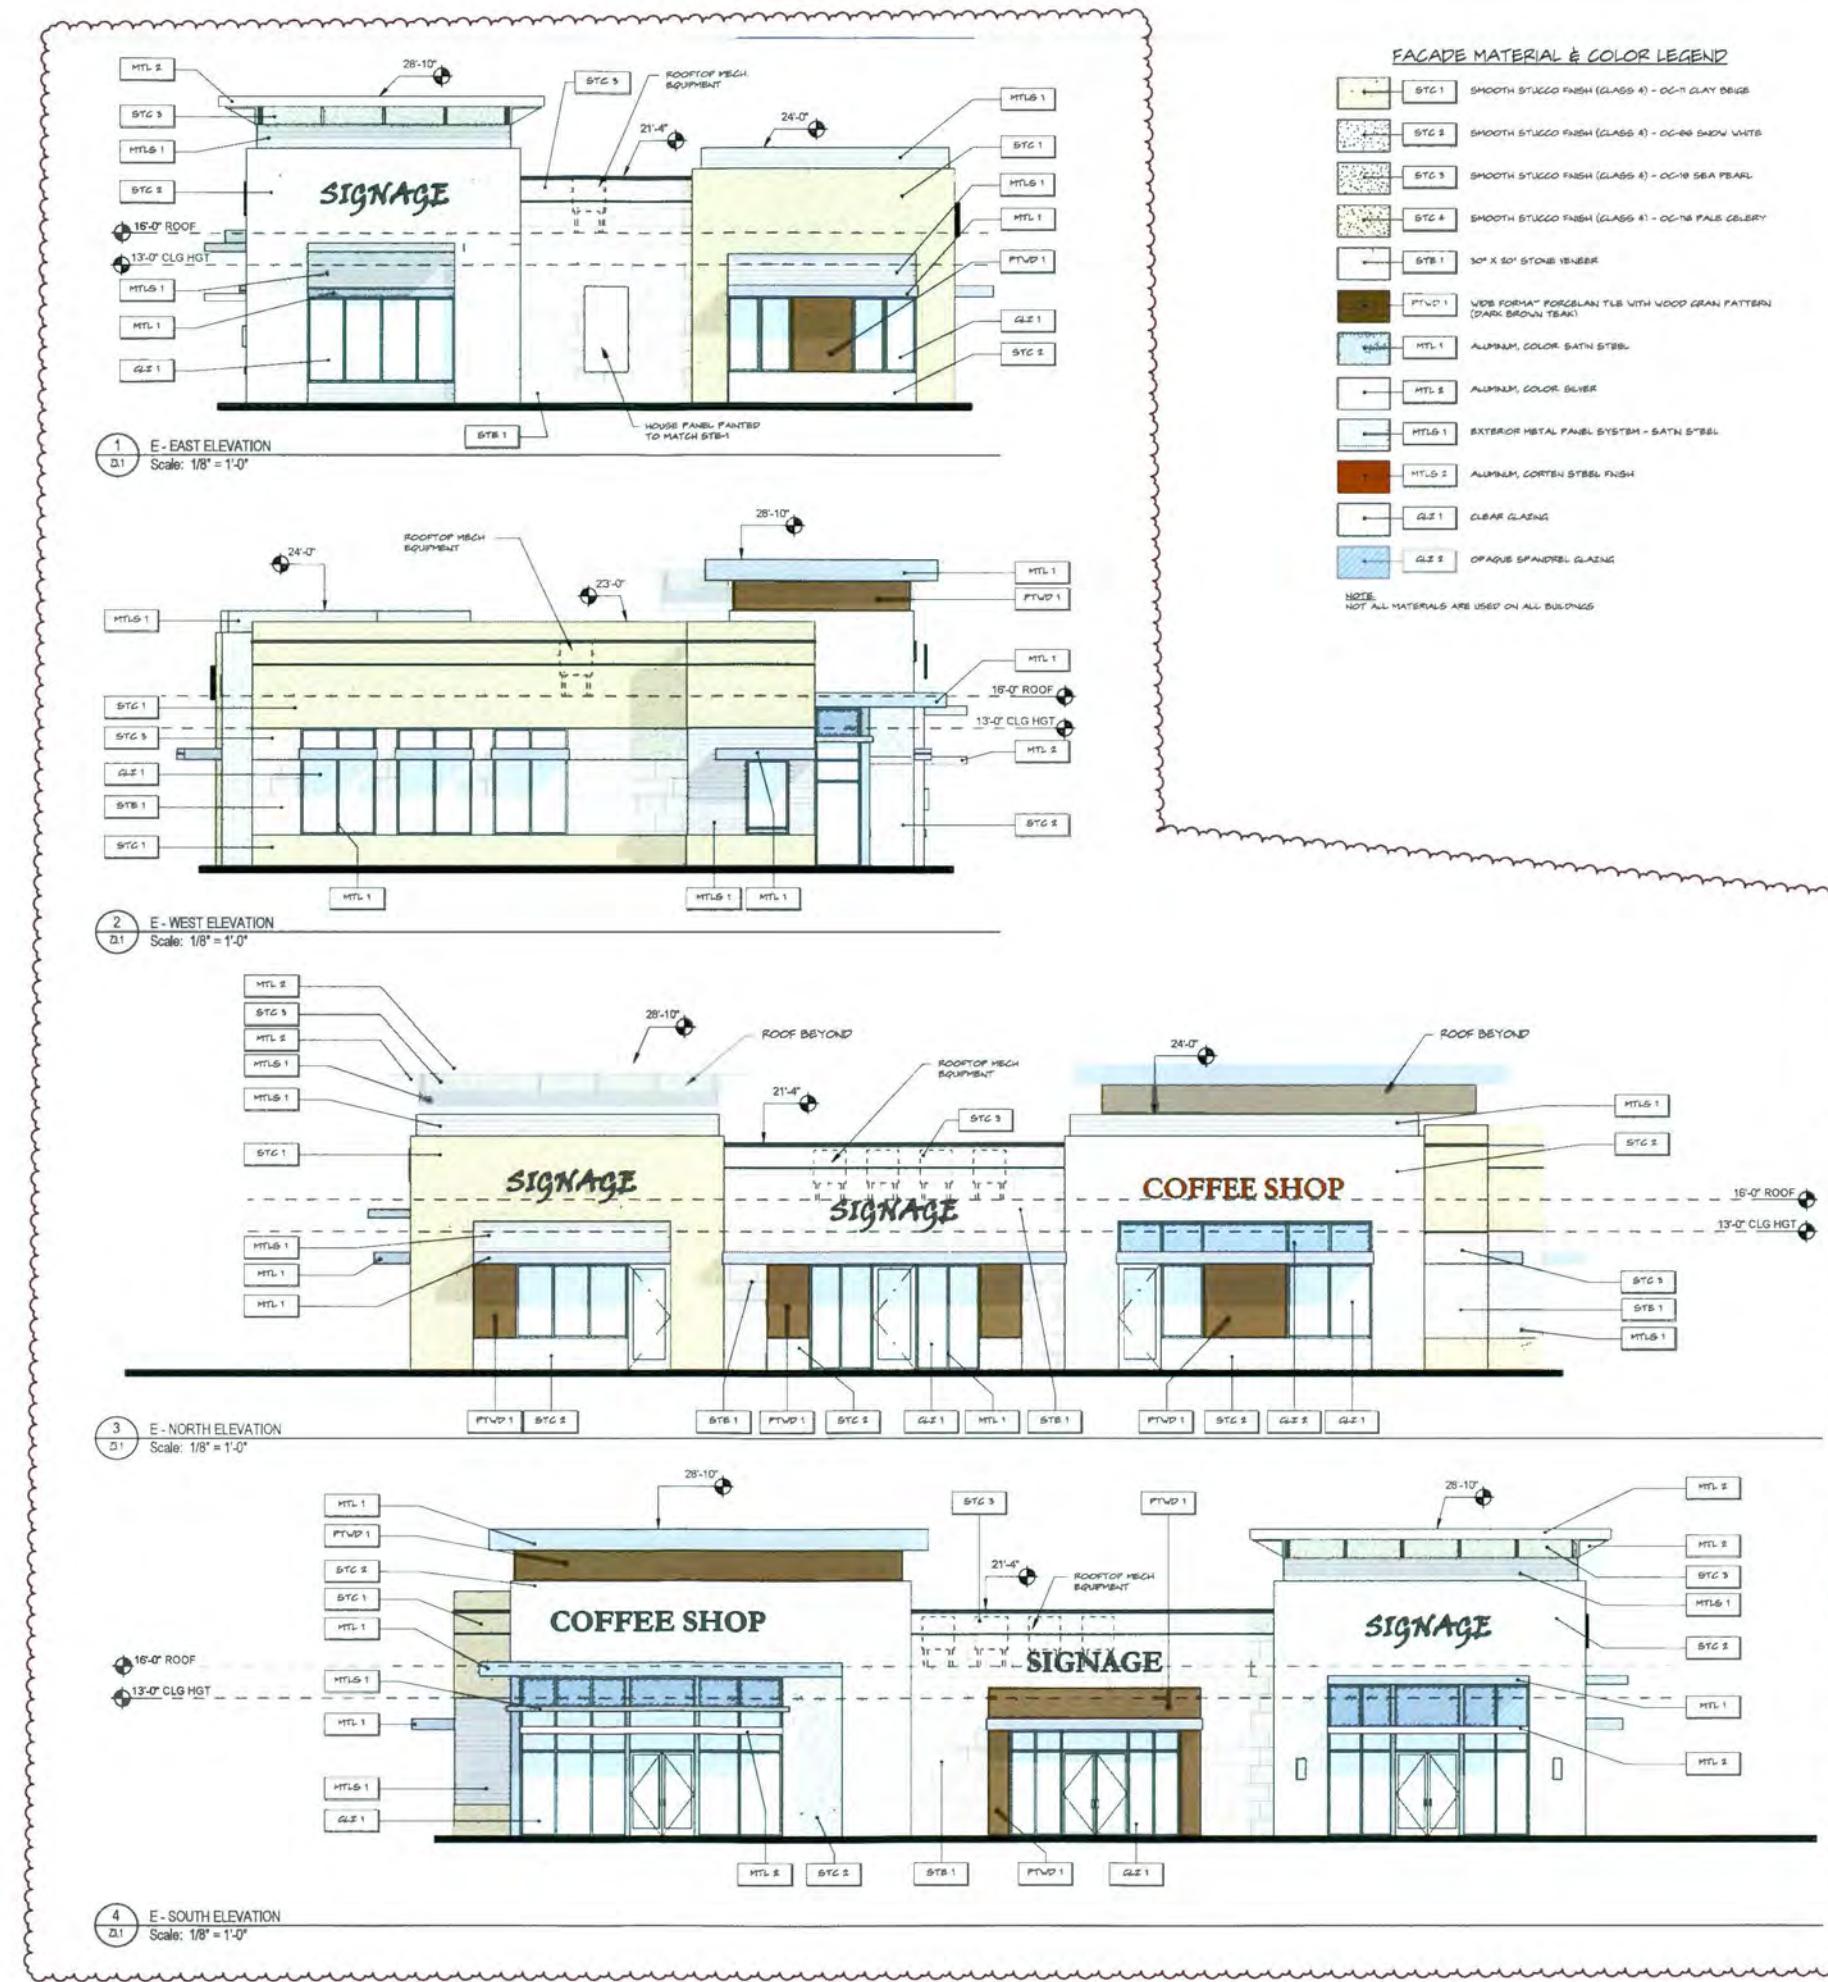NOTE: NOT ALL MATERIALS ARE USED ON ALL BUILDINGS

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561.868.6844 • Fax: 561.868.5594
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R. Ira S. Akbar 2015

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John Glidden + Associates • Ruth M. Spina + Associates

PROPOSED NEW CONSTRUCTION:
ALTON TOWN CENTER
BUILDING E
PALM BEACH GARDENS, FLORIDA

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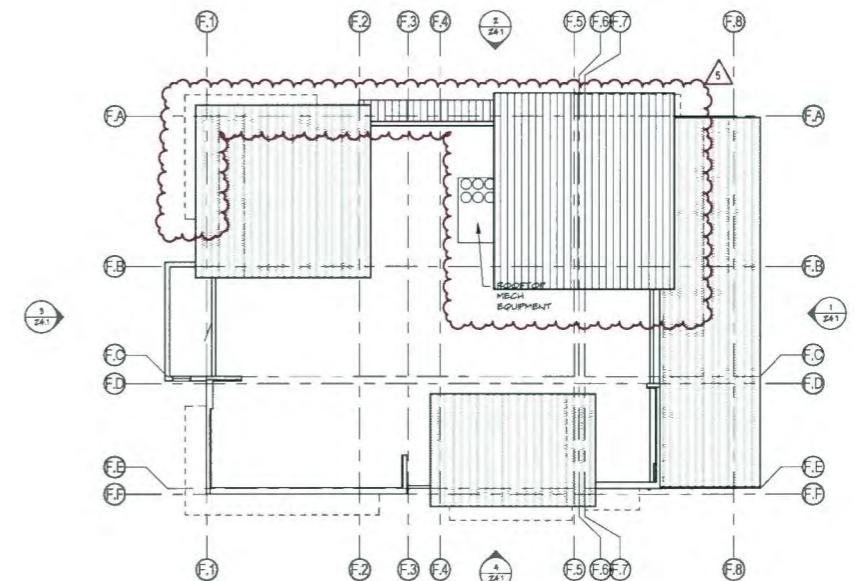
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- 3. REVISION TO 06.29.16 SUBMITTAL
- 4. REVISION TO 07.20.16 SUBMITTAL
- 5. REVISION TO 09.06.16 SUBMITTAL

Project no. 13273
Date: 07/10/2015
Drawn by: ADC
Project Architect: ADC
Partner: KS


Building E - ELEVATIONS

Z3.1

ZONING SUBMITTAL



2 ROOF PLAN
Z4.0
Scale: 1/16" = 1'-0"

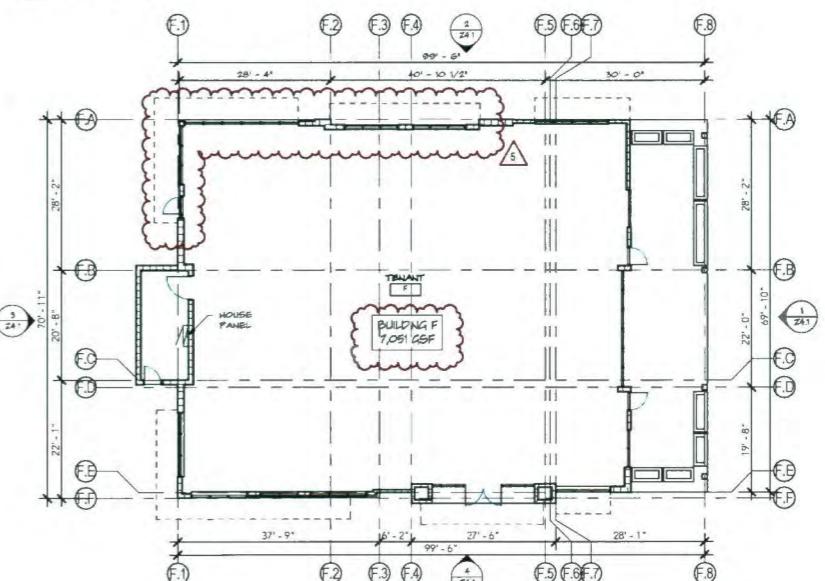

1 FLOOR PLAN
Z4.0
Scale: 1/16" = 1'-0"

BUILDING F - PLANS

Z4.0
ZONING SUBMITTAL


**NEW CONSTRUCTION FOR:
ALTON TOWN CENTER
BUILDING F
PALM BEACH GARDENS, FLORIDA**

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- 4 REVISION TO 07.20.16
SUBMITTAL
- 5 REVISION TO 09.08.16
SUBMITTAL

Project no.: 13273
Date: 07/10/2015
Drawn by: MA
Project Architect: AC
Partner: KAS



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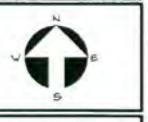


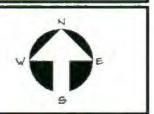NEW CONSTRUCTION FOR:
ALTON TOWN CENTER
BUILDING F
PALM BEACH GARDENS, FLORIDA

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3 REVISION TO 06.29.16
4 REVISION TO 07.20.16
5 REVISION TO 09.08.16

Project no.: 13273
Date: 07/10/2015
Drawn by: MA
Project Architect: AC
Partner: KAS



Z4.1



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BUILDING G - PLAN

Z5.0
ZONING SUBMITTAL


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BUILDING G
(ARCHITECTURAL MIRROR IMAGE)
PALM BEACH GARDENS, FLORIDA

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- 4 REVISION TO 07.20.16 SUBMITTAL
- 5 REVISION TO 9.06.16 SUBMITTAL


Project no.: 13273
Date: 07/10/2015
Drawn by: AC
Project Architect: AC
Partner: KS

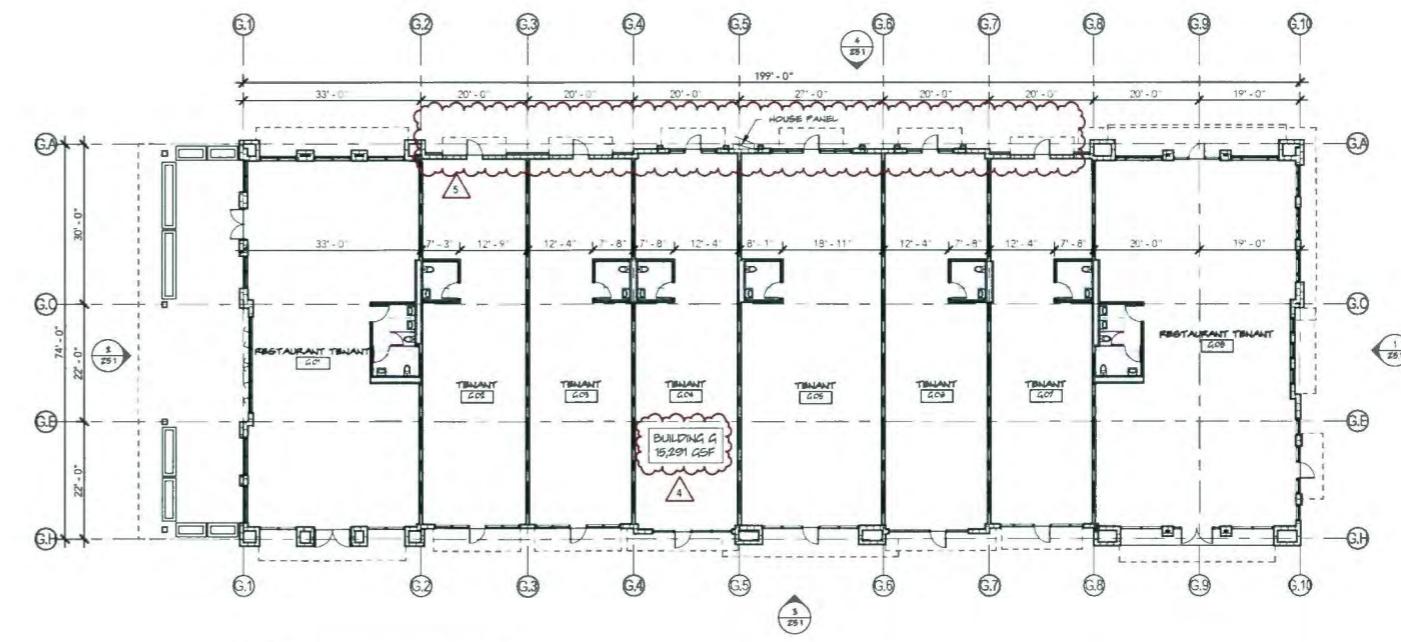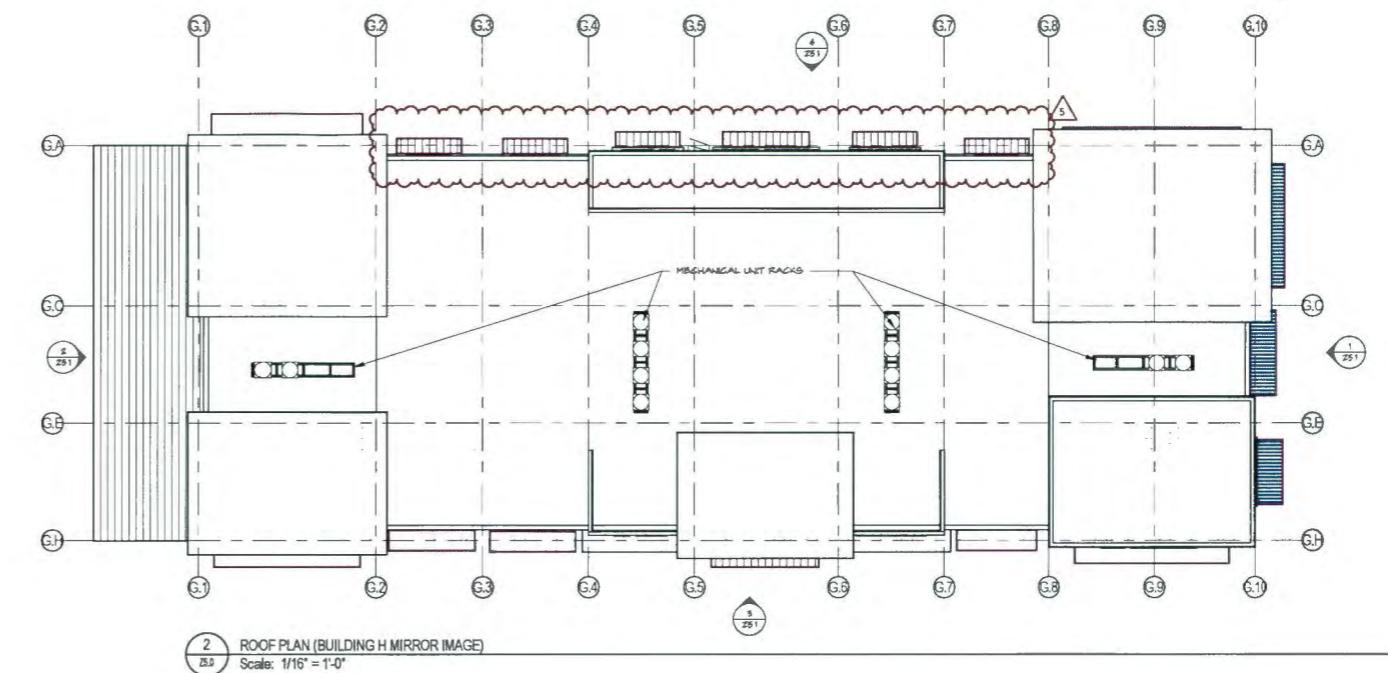

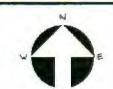

FAÇADE MATERIAL & COLOR LEGEND	
STC 1	SMOOTH STUCCO FINISH (CLASS A) - OC-11 CLAY BEIGE
STC 2	SMOOTH STUCCO FINISH (CLASS A) - OC-68 SNOW WHITE
STC 3	SMOOTH STUCCO FINISH (CLASS A) - OC-19 SEA PEARL
STC 4	SMOOTH STUCCO FINISH (CLASS A) - OC-16 FAIR CELERY
STB 1	30" X 120" STONE VENEER
HTW 1	WIDE FORMAT PORCELAIN TILE WITH WOOD GRAIN PATTERN (DARK BROWN TRIM)
HTL 1	ALUMINUM, COLOR SATIN STEEL
HTL 2	ALUMINUM, COLOR SILVER
HTL 3	EXTERIOR METAL PANEL SYSTEM - SATIN STEEL
HTL 4	ALUMINUM, CORTEZ STEEL FINISH
GLZ 1	CLEAR GLAZING
GLZ 2	OPAQUE SPANDREL GLAZING

NOTE:
NOT ALL MATERIALS ARE USED ON ALL BUILDINGS

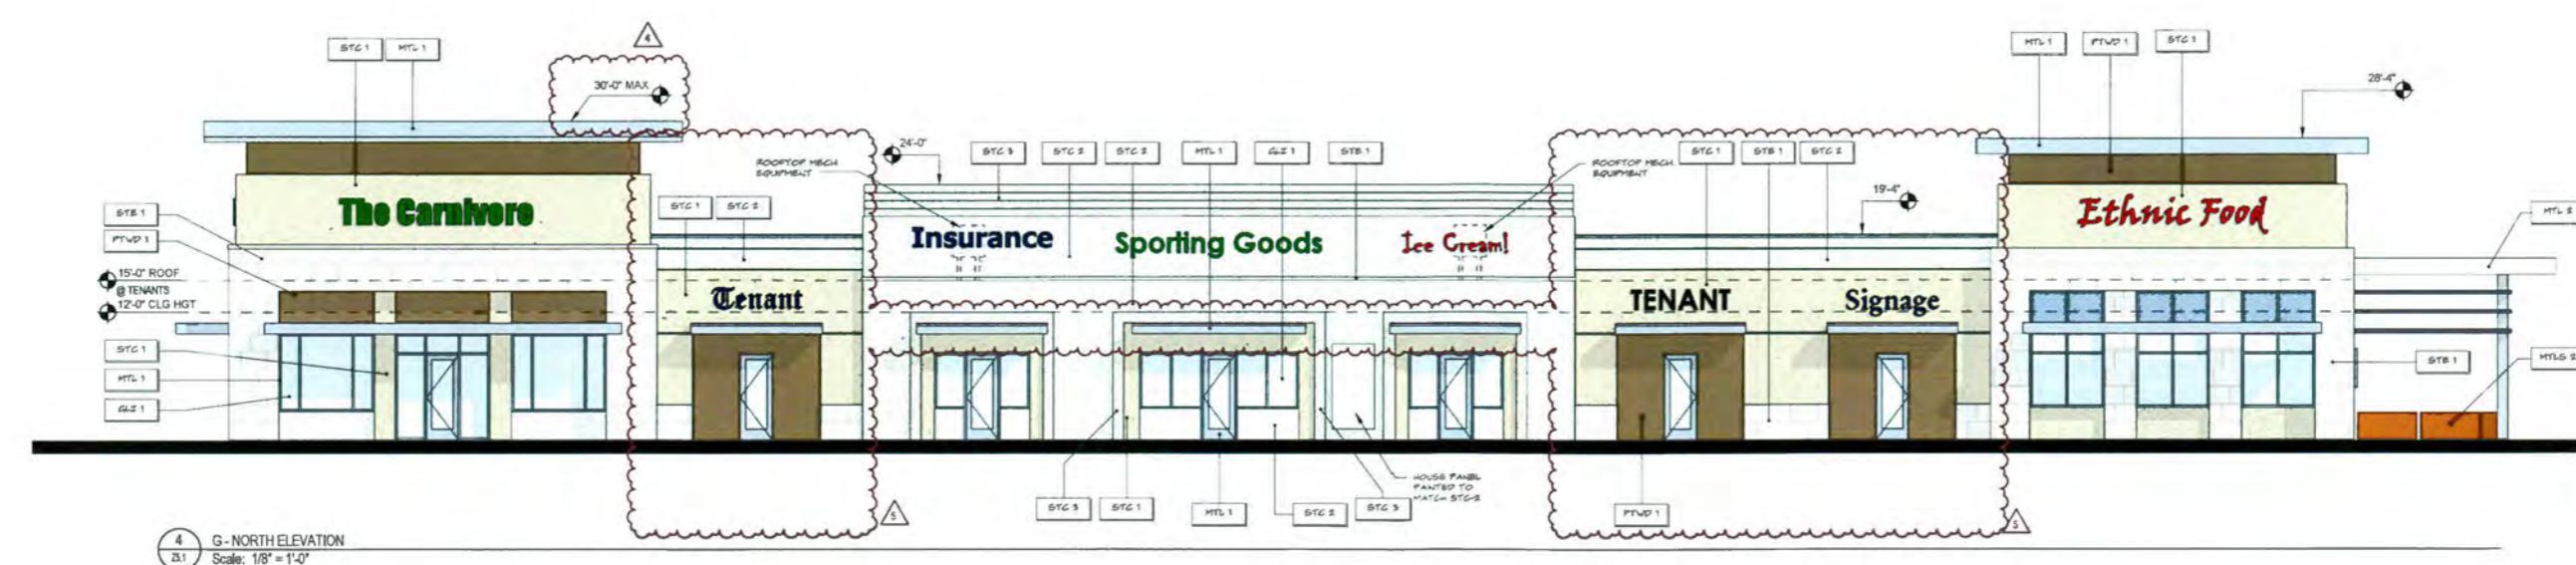

BUILDING G - ELEVATIONS

Z5.1


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NEW CONSTRUCTION FOR:
ALTON TOWN CENTER
BUILDING G
PALM BEACH GARDENS, FLORIDA

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SUBMITTAL
4 REVISION TO 07.20.16
SUBMITTAL
5 REVISION TO 09.06.16
SUBMITTAL

Project no.: 13273
Date: 07/10/2015
Drawn by: ADC
Project Architect: KM
Partner: KS



BUILDING H - PLAN

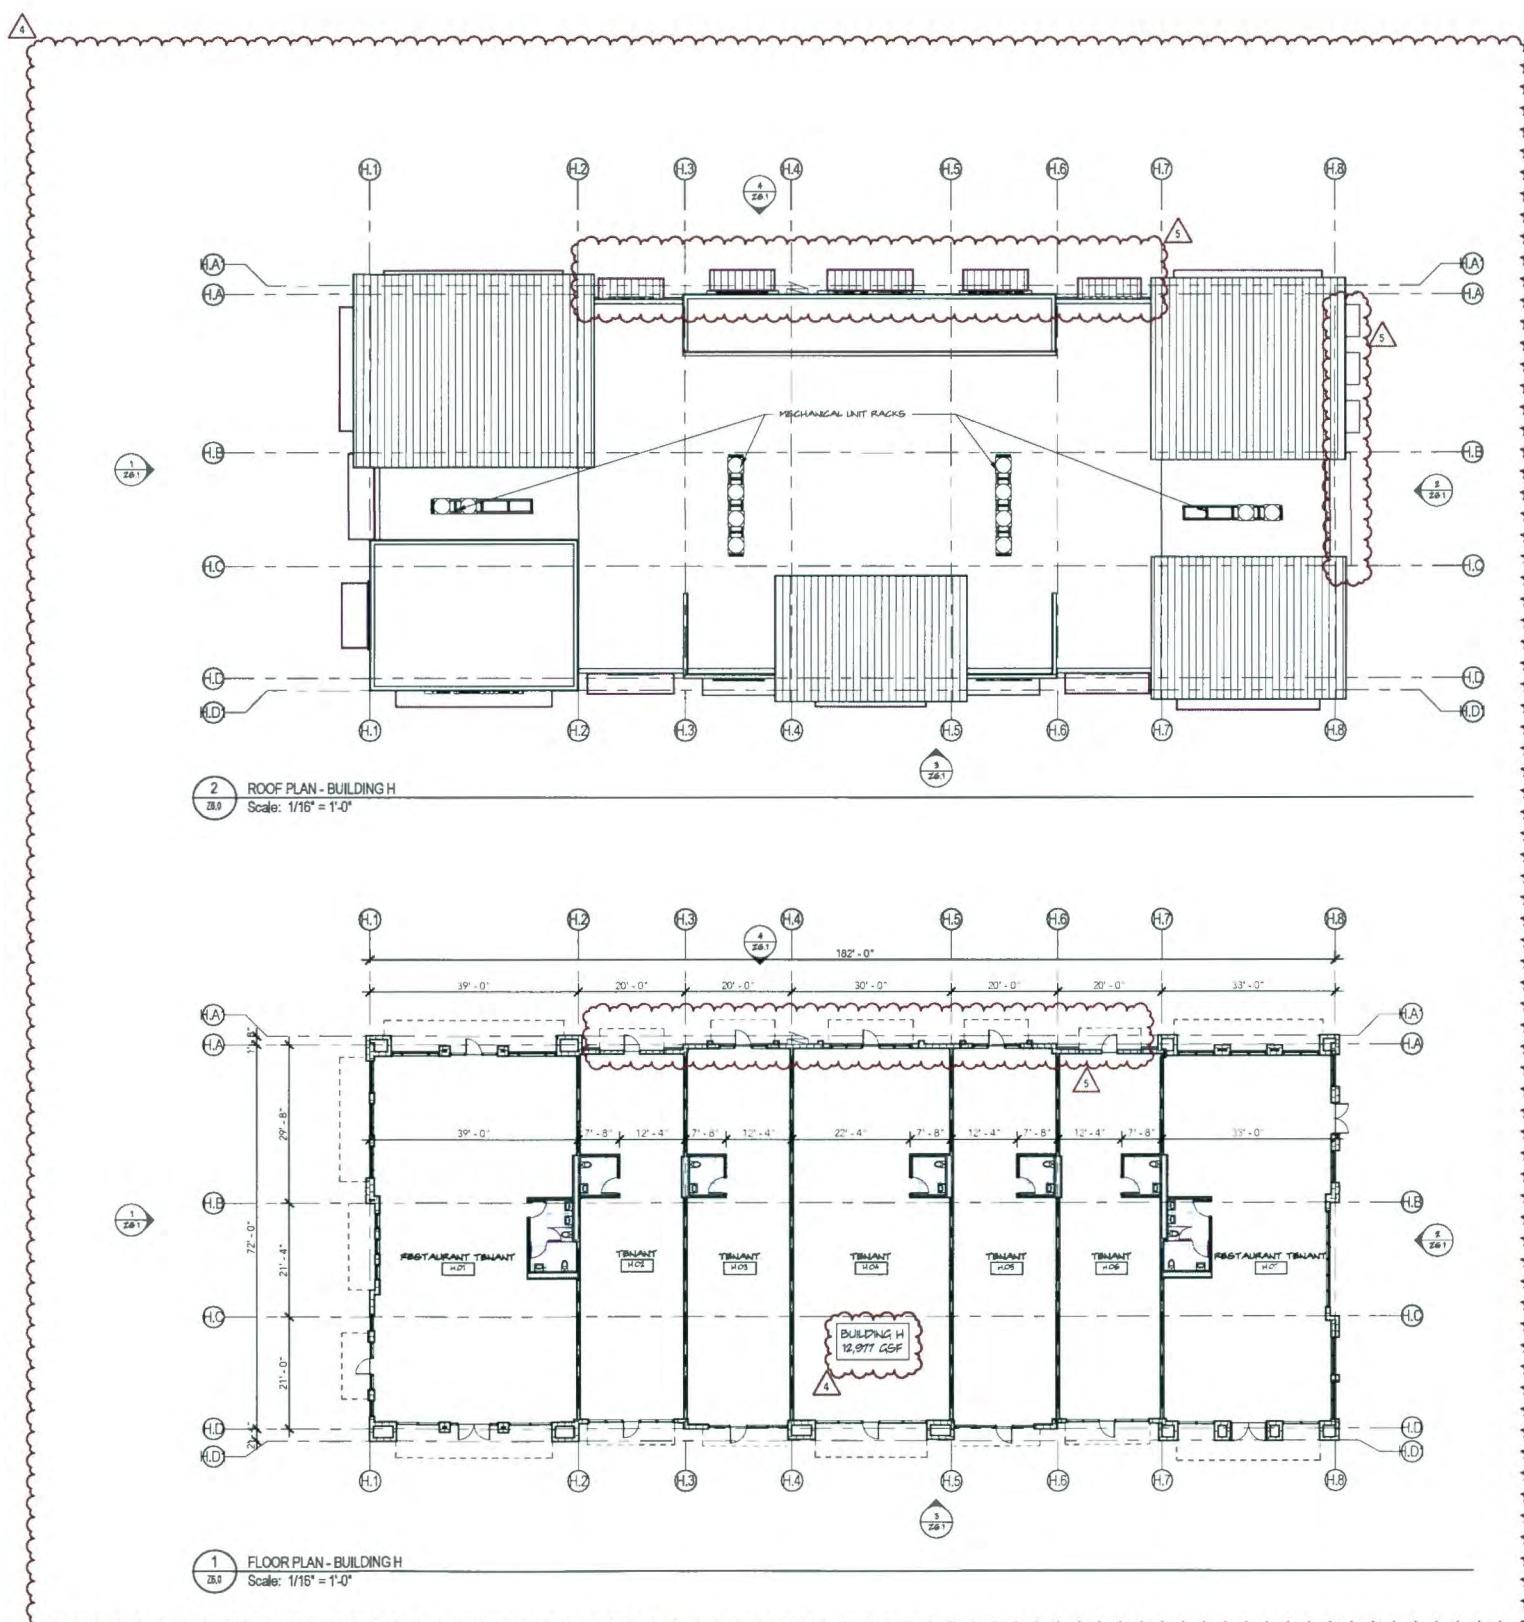Z6.0

ZONING SUBMITTAL

Project no: 13273
Date: 07/10/2015
Drawn by: KM
Project Architect: KM
Partner: KS



NEW CONSTRUCTION FOR:
ALTON TOWN CENTER
BUILDING H
PALM BEACH GARDENS, FLORIDA

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Revisions:
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SUBMITTAL

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**BUILDING H - ELEVATIONS****Z6.1**

ZONING SUBMITTAL



Project no: 13273
Date: 07/10/2015
Drawn by: ADC
Project Architect: KM
Partner: KS

Revisions:
Revision to 07/20/16
Submittal
Revision to 08/08/16
Submittal

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11

1

**ALTON TOWN CENTER
BUILDING I**
PALM BEACH GARDENS, FLORIDA
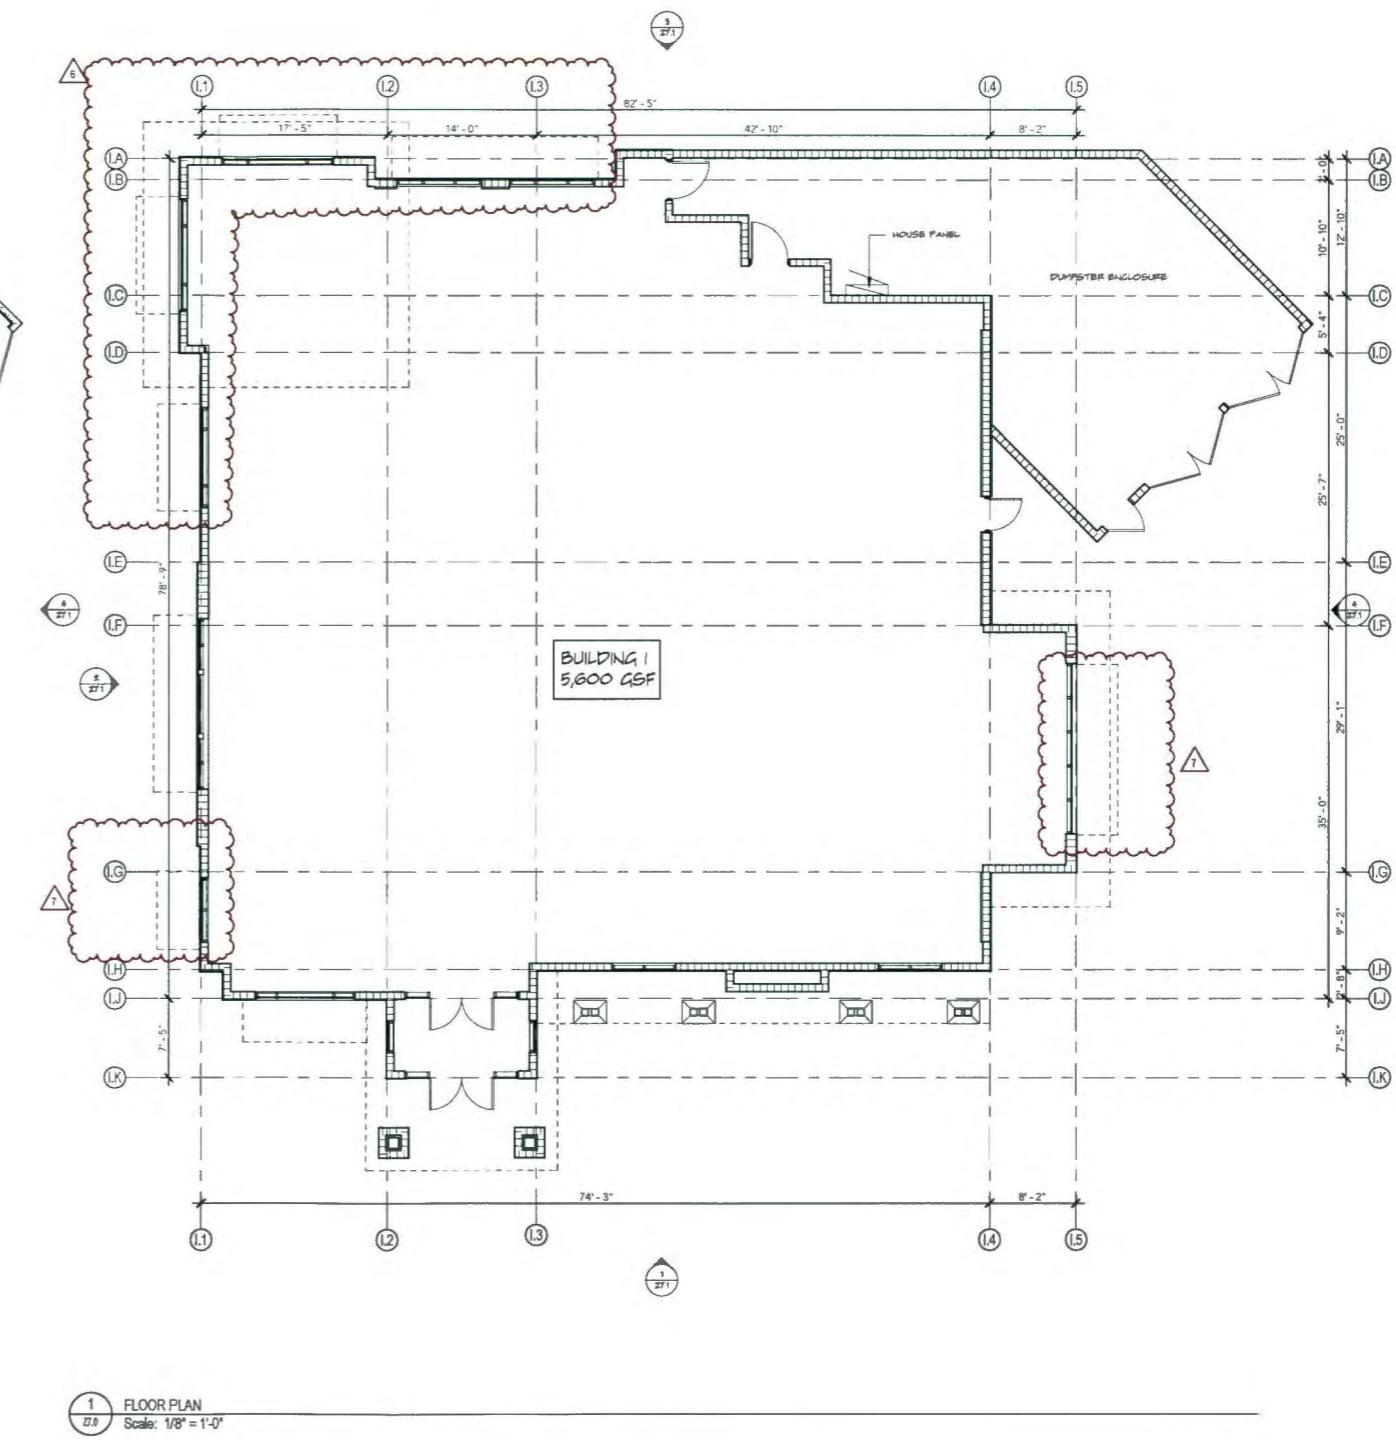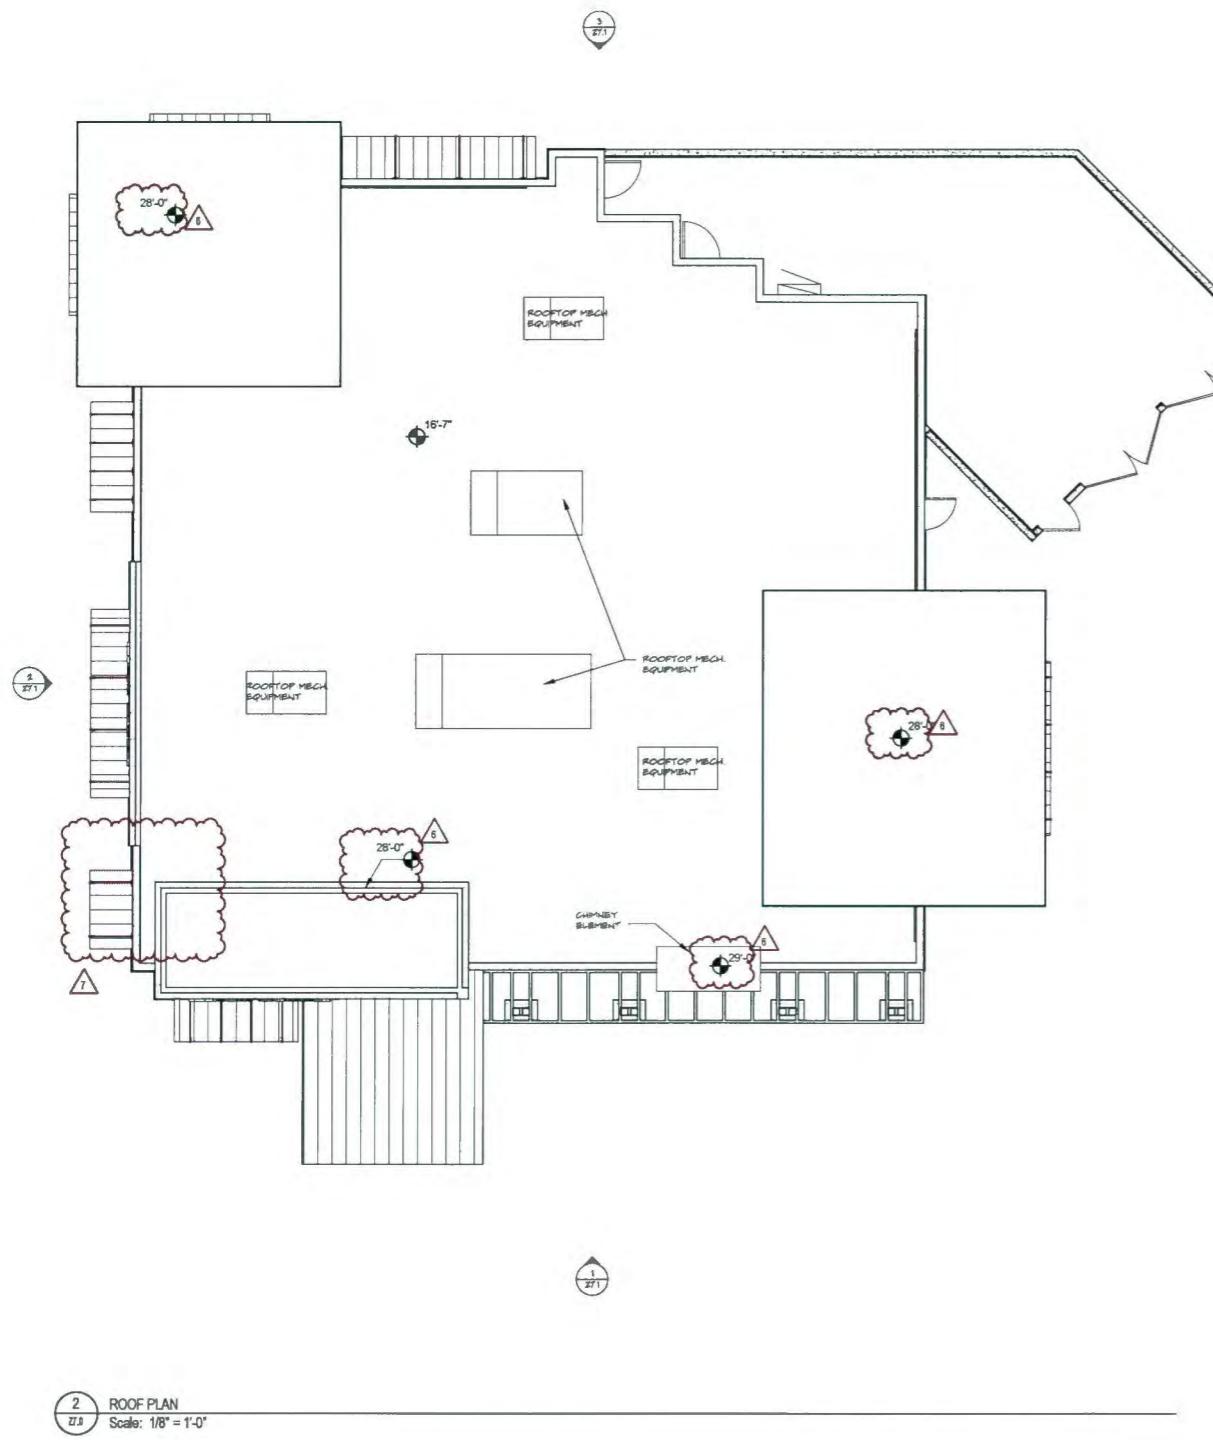
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S ON TO MITTAL	07-22-16
S ON TO MITTAL	07-28-16
S ON TO	08-06-16

ect no: 13273
: 07/10/2015
n by: AC
ct Architect: KM
er: KS


ZONING SUBMITTAL



FAÇADE MATERIAL & COLOR LEGEND	
STC 1	SMOOTH STUCCO FINISH (CLASS A) - OC-11 CLAY BEIGE
STC 2	SMOOTH STUCCO FINISH (CLASS A) - OC-08 SNOW WHITE
STC 3	SMOOTH STUCCO FINISH (CLASS A) - OC-19 SEA FOAM
STC 4	SMOOTH STUCCO FINISH (CLASS A) - OC-18 PALE CELERY
STB 1	30" X 20" STONE VENEER
PTWD 1	WDB FORMAT PORCELAIN TILE WITH WOOD GRAIN PATTERN
MTL 1	ALUMINUM, COLOR SATIN STEEL
MTL 2	ALUMINUM, COLOR SILVER
MTL 3	ALUMINUM, COLOR DARK BRONZE
MTL 4	EXTERIOR METAL PANEL SYSTEM - SATIN STEEL
MTL 5	ALUMINUM, CORTEZ STEEL FINISH
GLZ 1	CLEAR GLAZING
GLZ 2	OPAQUE SPANDREL GLAZING

NOTE:
NOT ALL MATERIALS ARE USED ON ALL BUILDINGS

NEW CONSTRUCTION FOR: ALTON TOWN CENTER BUILDING I PALM BEACH GARDENS, FLORIDA																						
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7	REVISION TO SUBMITTAL	09-06-10																				
Project no.: 13273 Date: 07/10/2015 Drawn by: ADC Project Architect: KM Partner: KS																						
BUILDING I - ELEVATIONS																						
Z7.1																						
ZONING SUBMITTAL																						

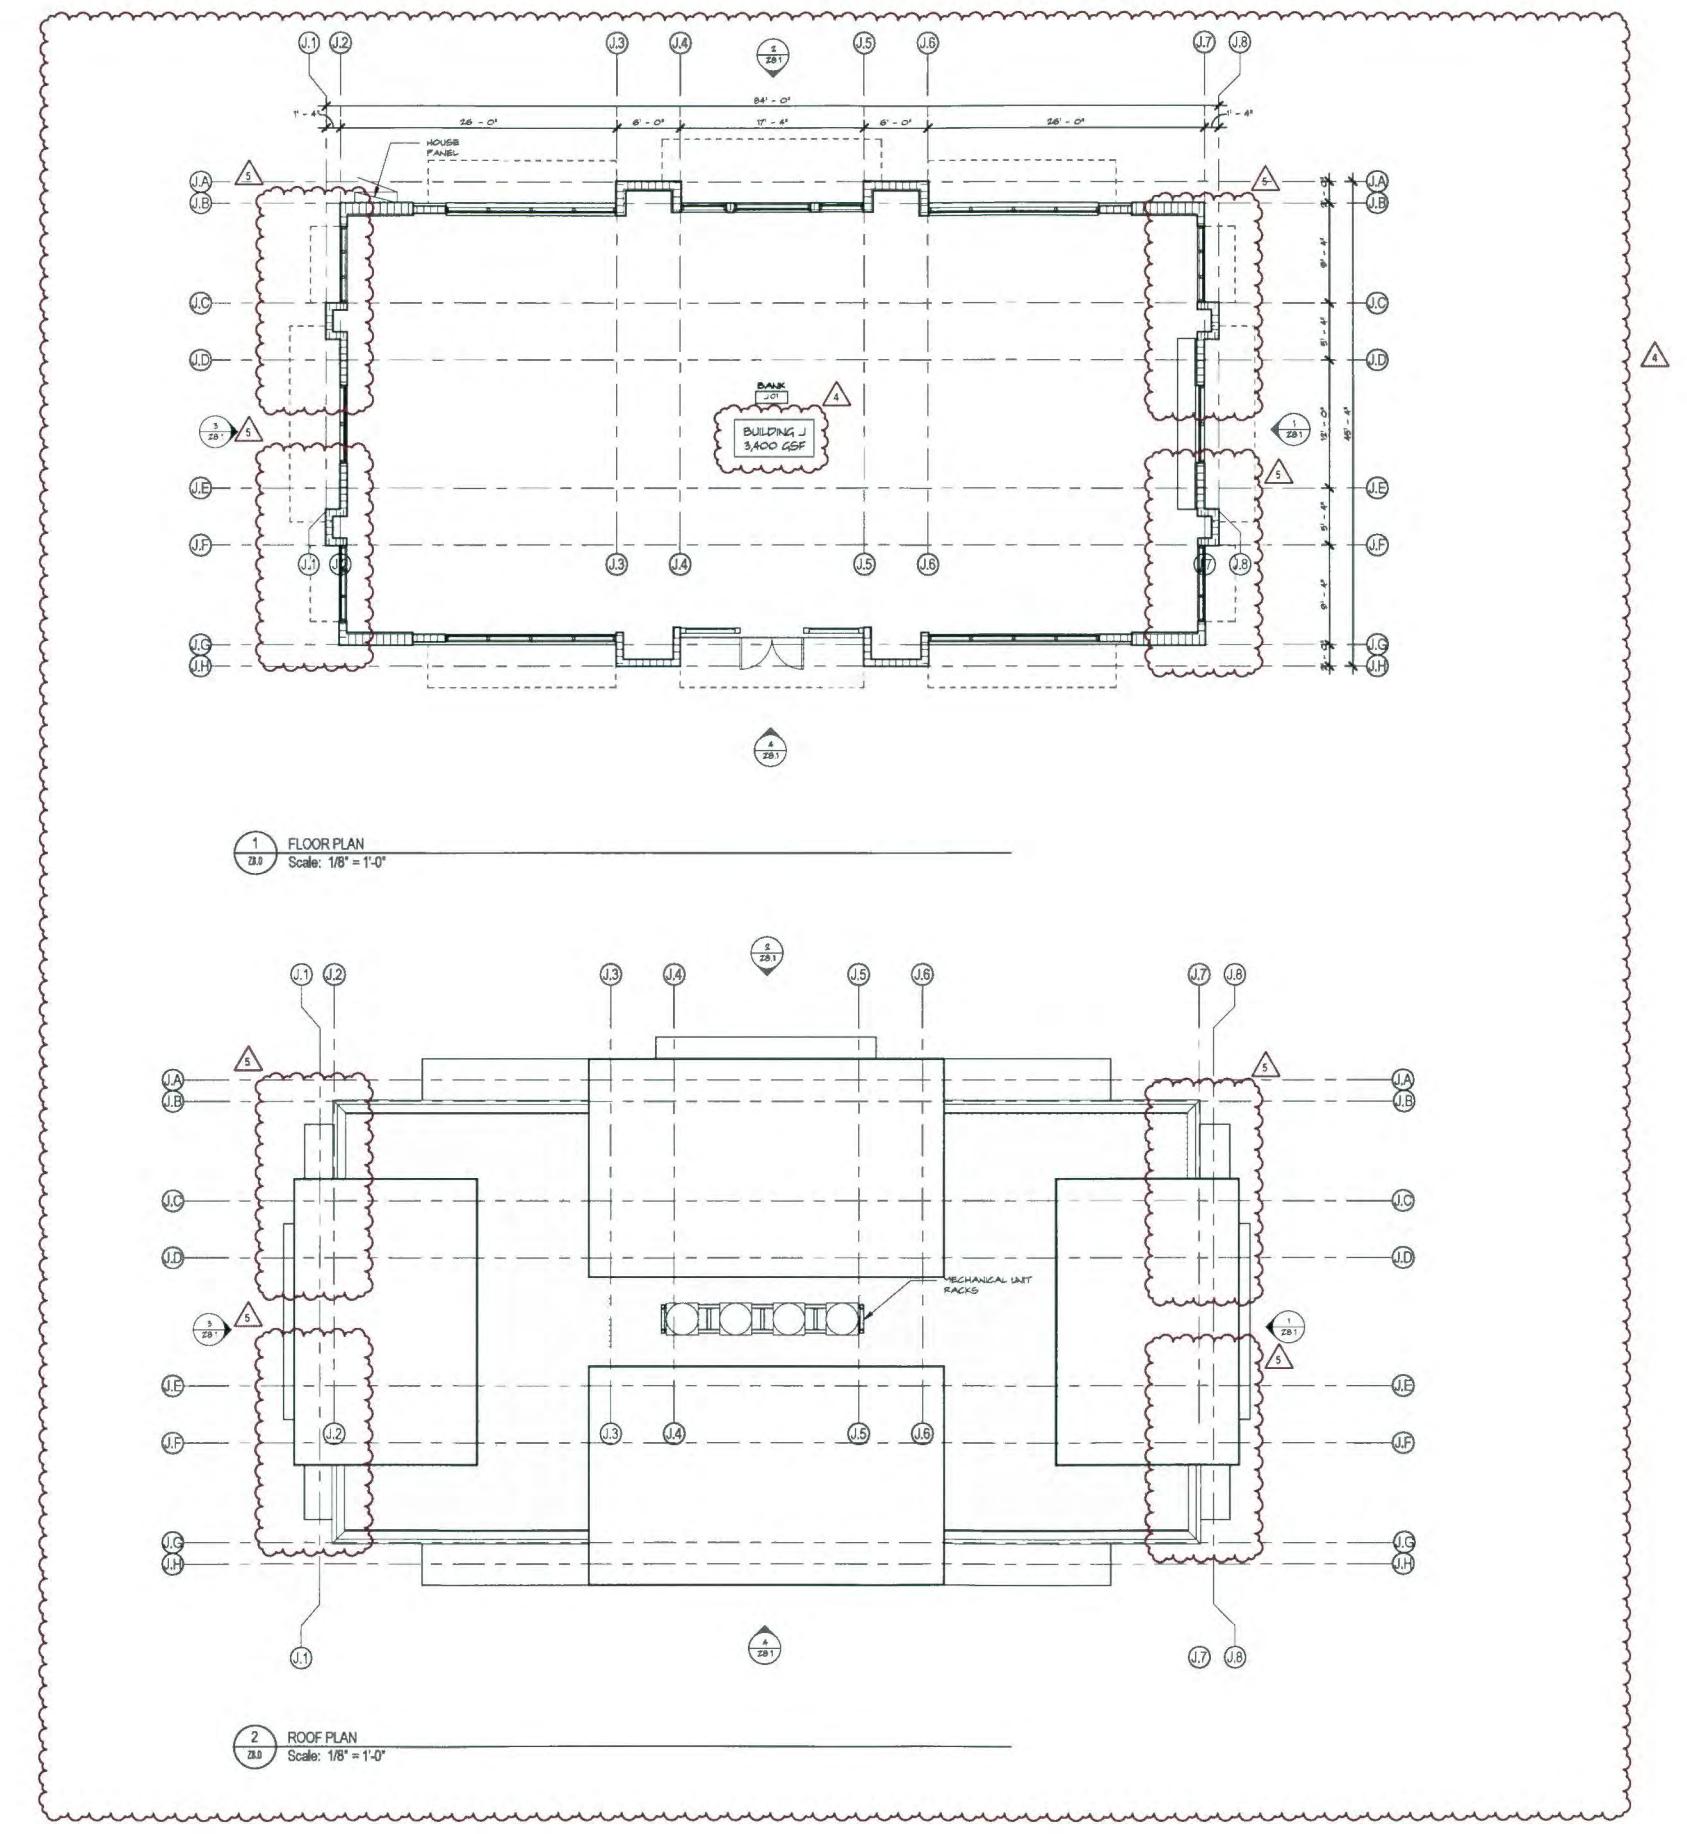

BUILDING J - PLANS

ZONING SUBMITTAL


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PALM BEACH GARDENS, FLORIDA

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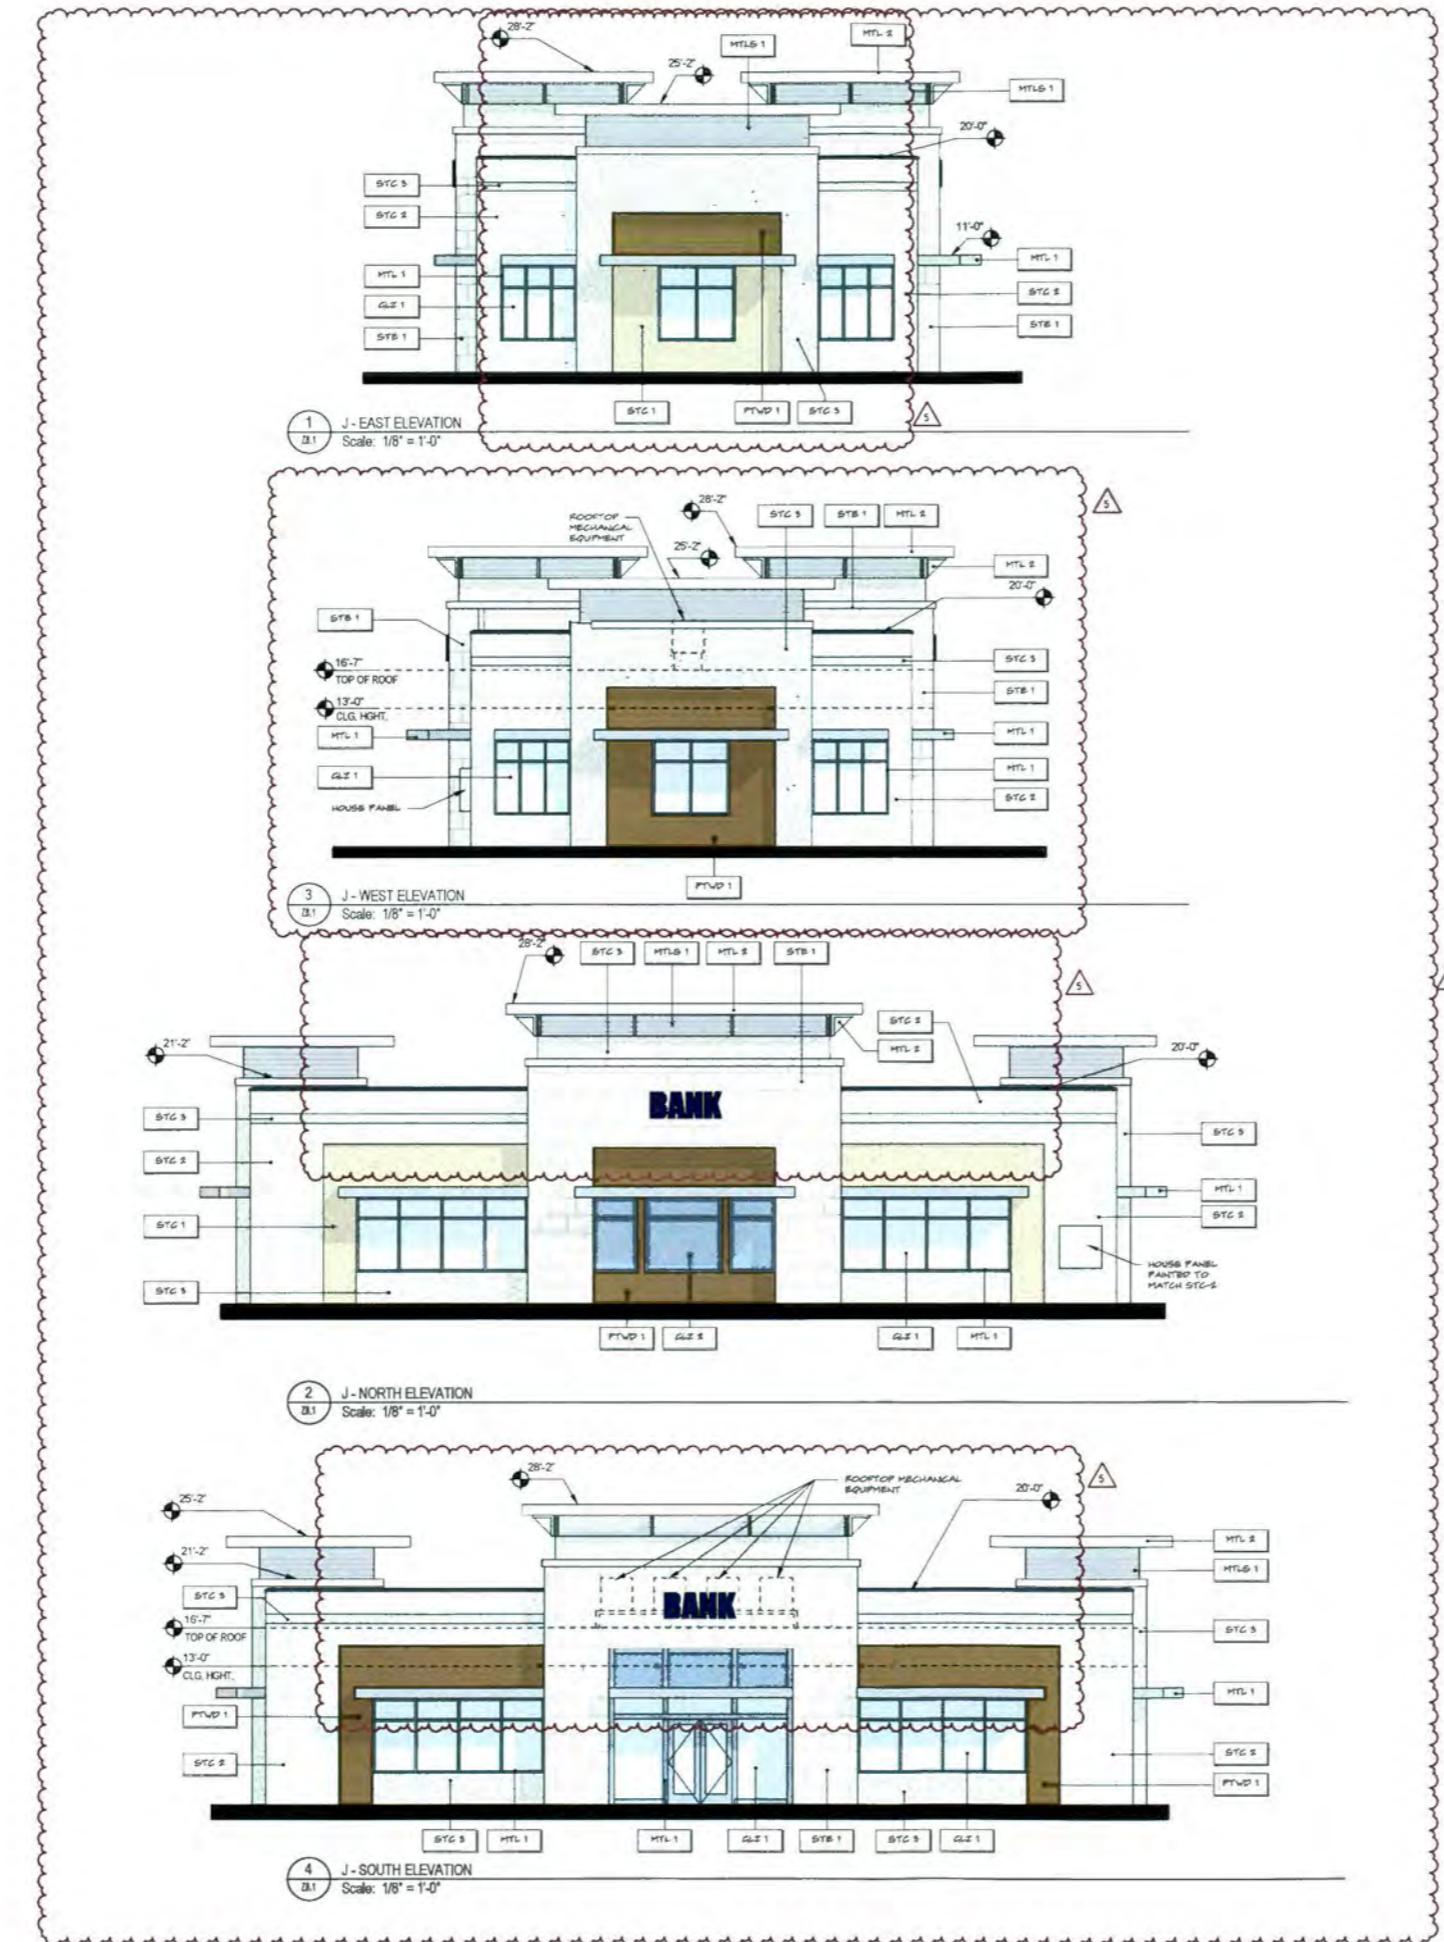
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4	REVISION TO	07.20.16
5	REVISION TO	09.06.16
	SUBMITTAL	

Project no. 13273
Date: 07/10/2015
Drawn by: JU
Project Architect: KM
Partner: KS



Z8.0

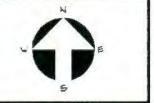ZONING SUBMITTAL



FAÇADE MATERIAL & COLOR LEGEND	
STC 1	SMOOTH STUCCO FINISH (CLASS A) - OC-11 CLAY BEIGE
STC 2	SMOOTH STUCCO FINISH (CLASS A) - OC-06 SNOW WHITE
STC 3	SMOOTH STUCCO FINISH (CLASS A) - OC-05 SEA PEARL
STC 4	SMOOTH STUCCO FINISH (CLASS A) - OC-16 PALE CELERY
STB 1	30" X 30" STONE VENEER
PTW 1	WIDE FORMAT PORCELAIN TILE WITH WOOD GRAIN PATTERN (DARK BROWN TEAK)
MTL 1	ALUMINUM COLOR SATIN STEEL
MTL 2	ALUMINUM COLOR SILVER
MTL 3	EXTERIOR METAL PANEL SYSTEM - SATIN STEEL
MTL 4	ALUMINUM, CORTEEN STEEL FINISH
GLZ 1	CLEAR GLAZING
GLZ 2	OPAQUE SPANDREL GLAZING

NOTE: NOT ALL MATERIALS ARE USED ON ALL BUILDINGS.

NEW CONSTRUCTION FOR:
ALTON TOWN CENTER
BUILDING J
PALM BEACH GARDENS, FLORIDA



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Project no. 13273
Date: 07/10/2015
Drawn by: JU
Project Architect: KM
Partner: KS

BUILDING J - ELEVATIONS	Z8.1
ZONING SUBMITTAL	

Z8.1



BUILDING K - PLANS

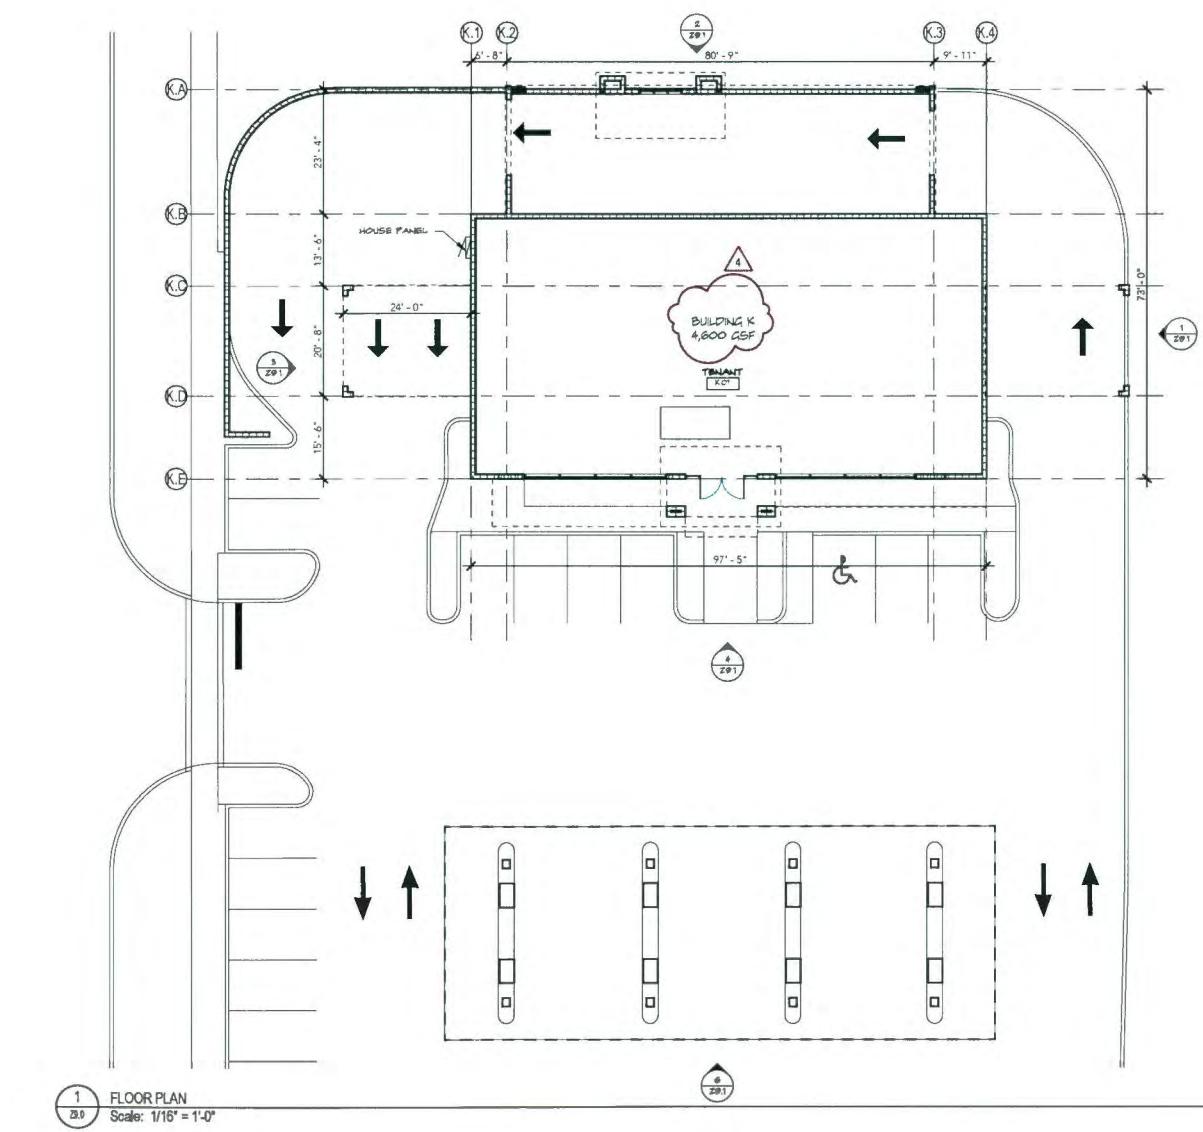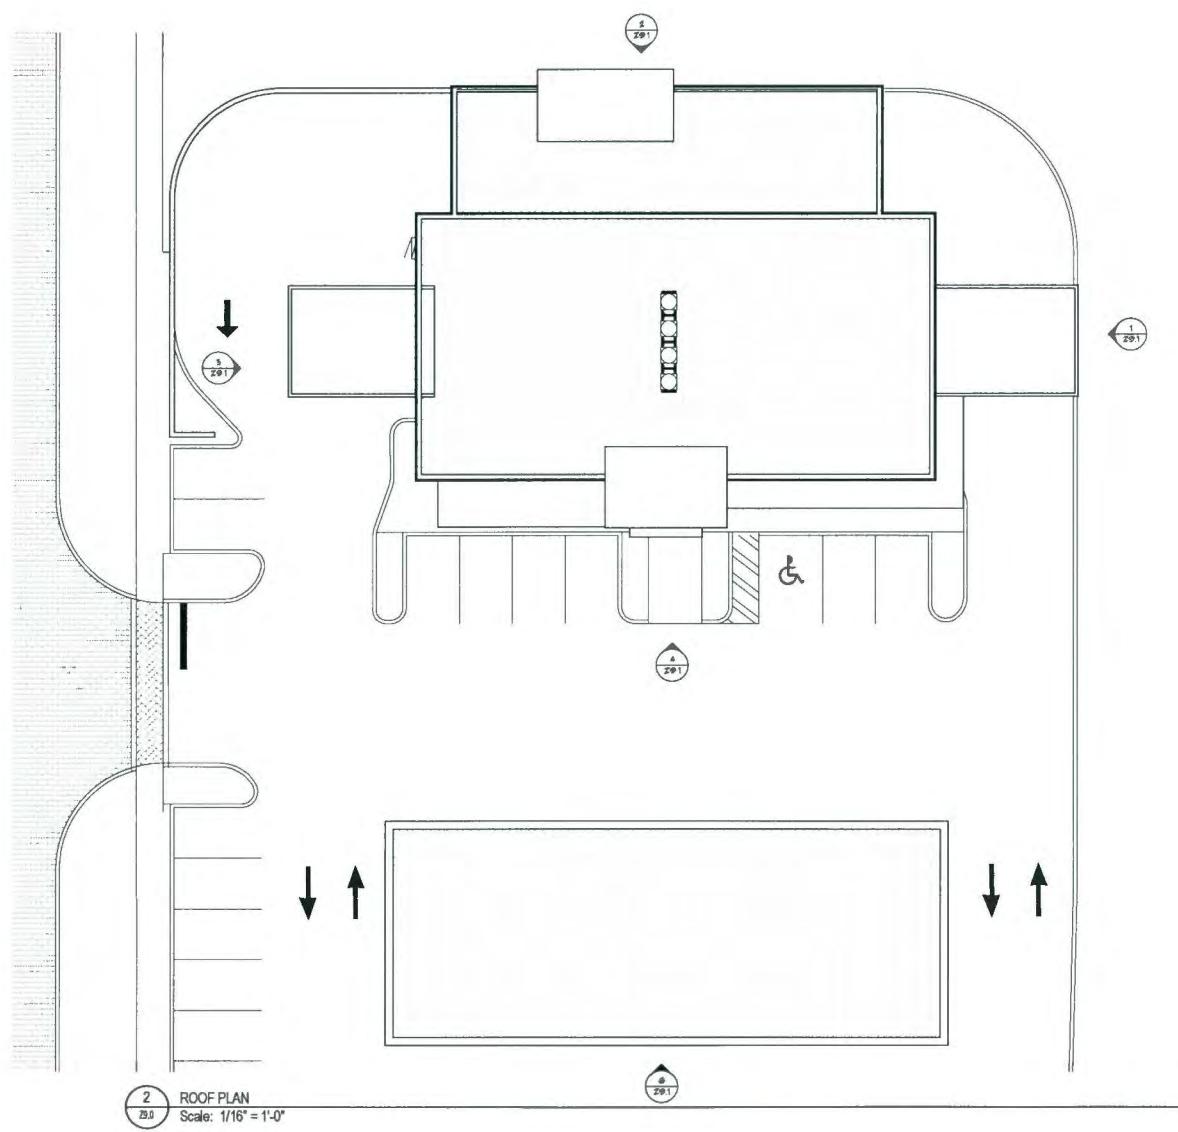Z9.0


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BUILDING K
PALM BEACH GARDENS, FLORIDA

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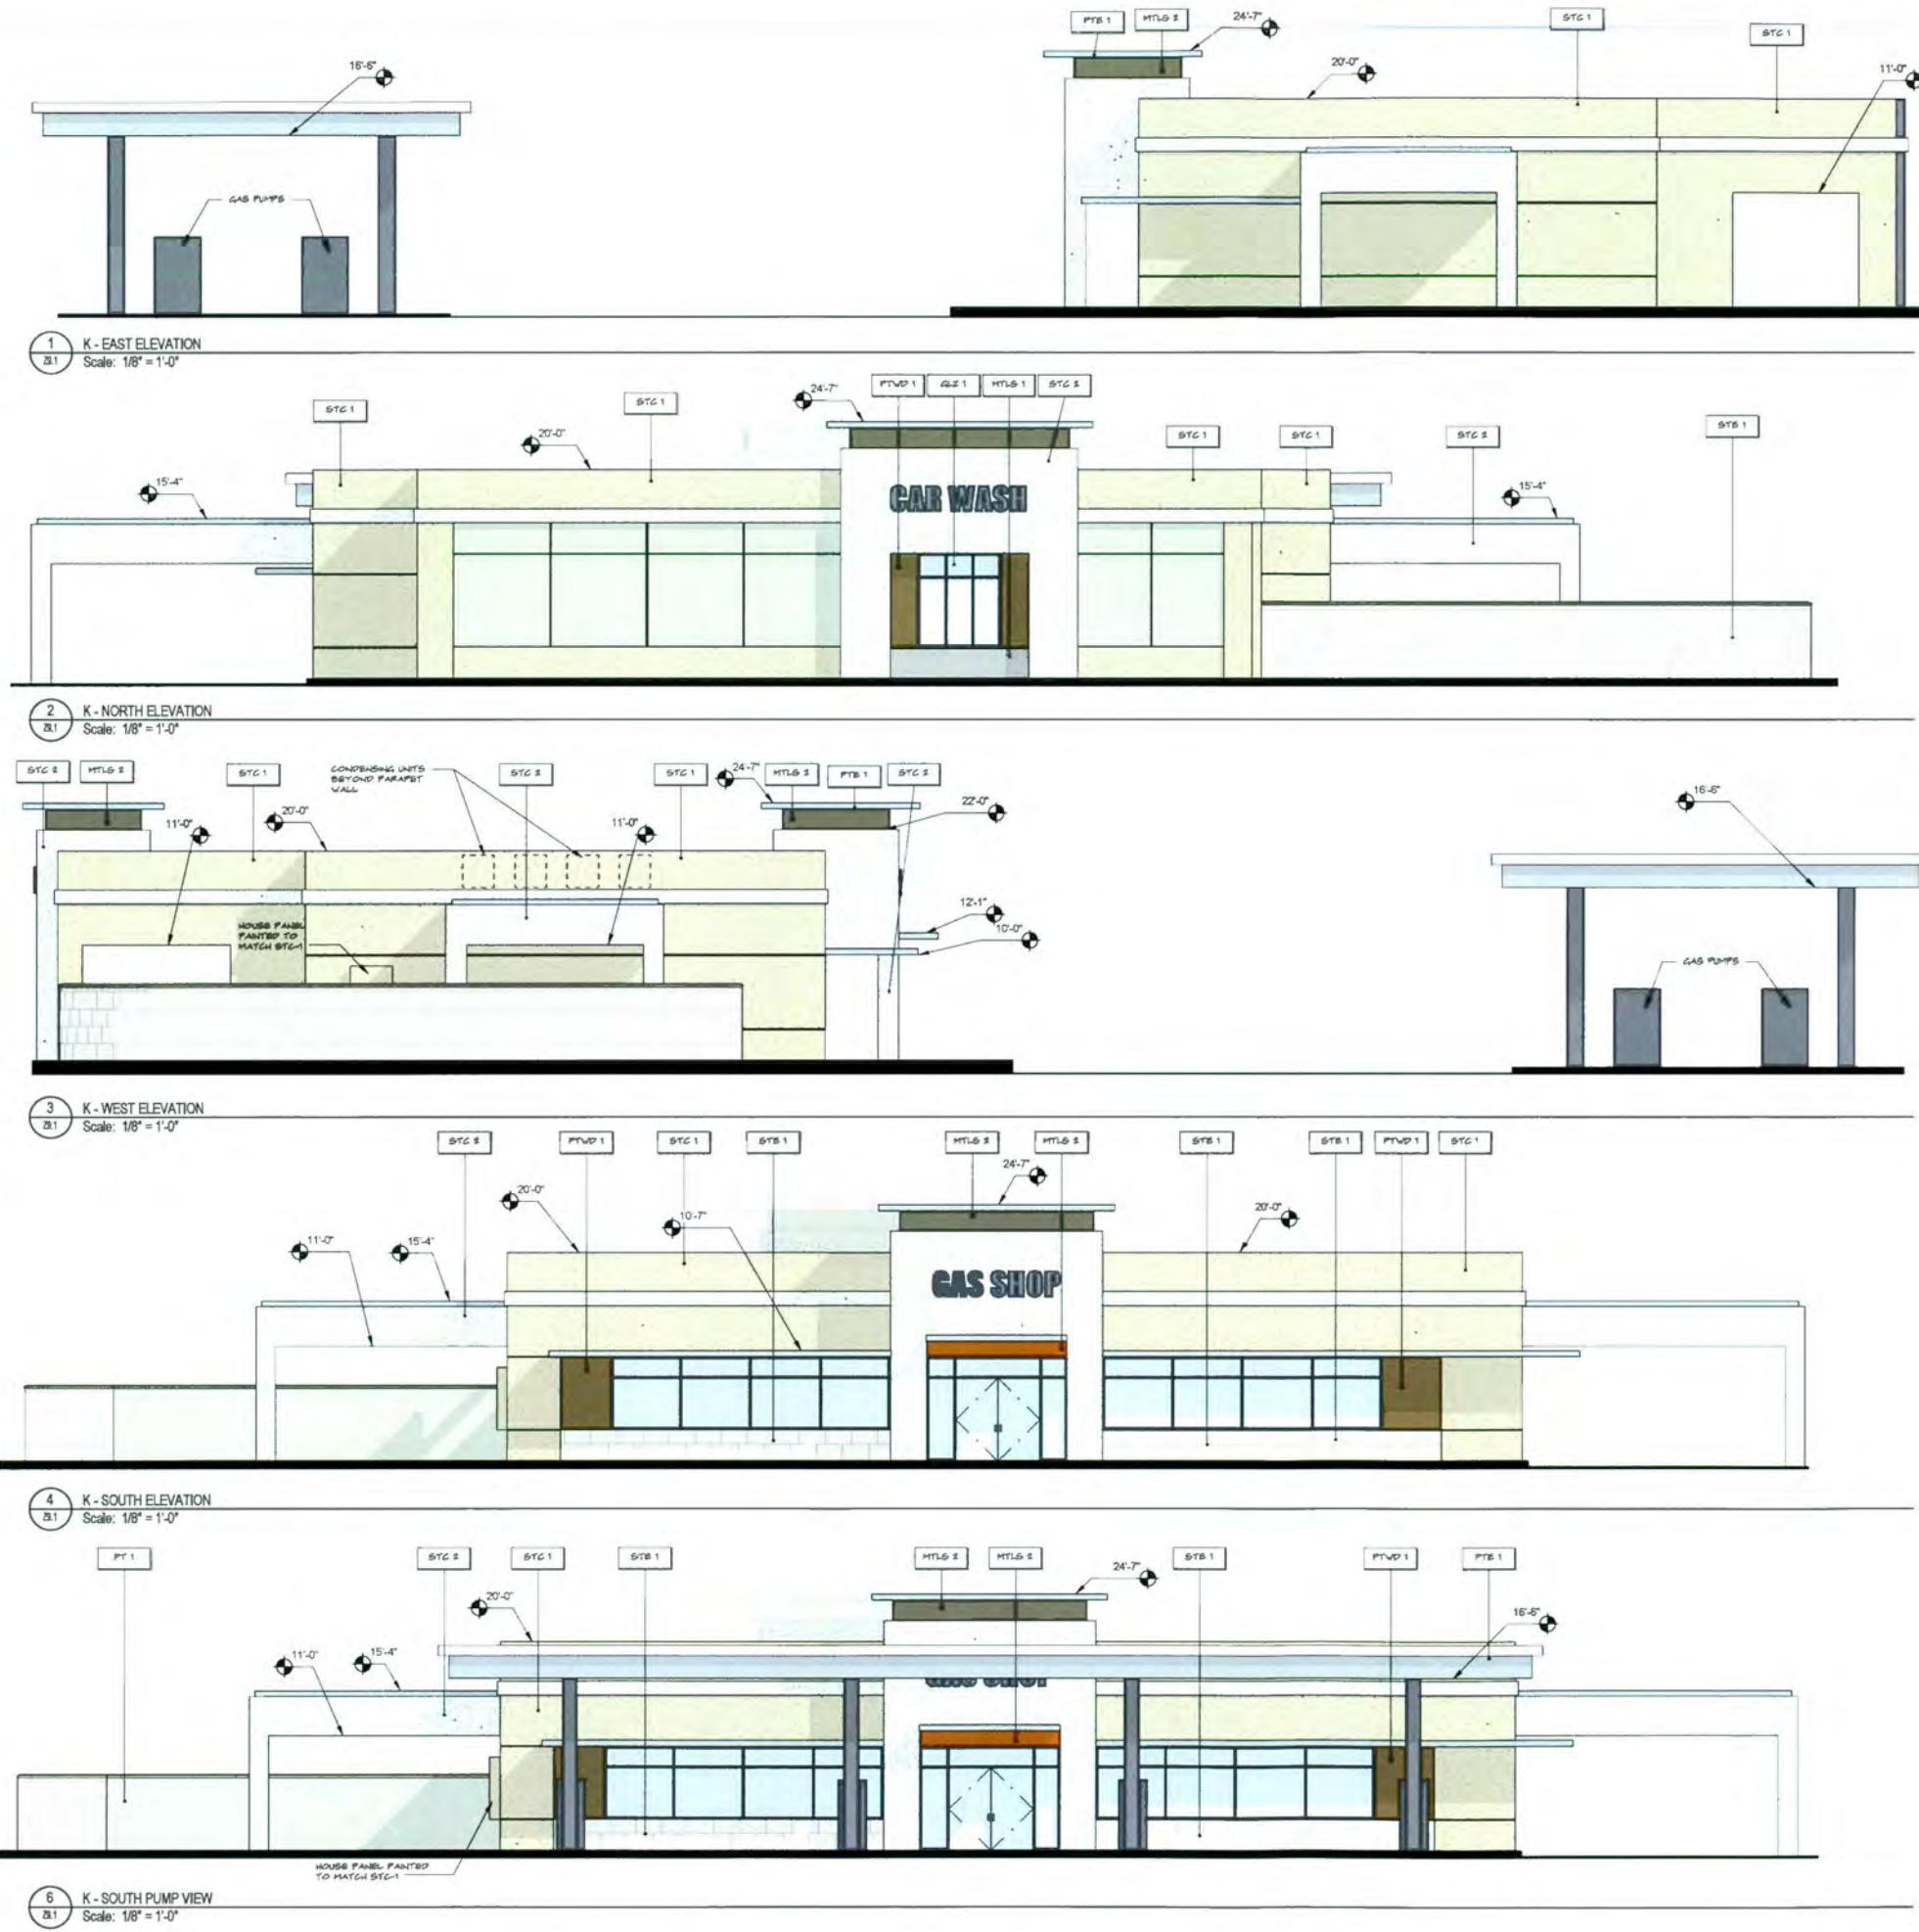
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Project no.: 13273
Date: 07/10/2015
Drawn by: JB
Project Architect: AC
Partner: KS



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FAÇADE MATERIAL & COLOR LEGEND	
STC 1	SMOOTH STUCCO FINISH (CLASS 4) - OC-11 CLAY BEIGE
STC 2	SMOOTH STUCCO FINISH (CLASS 4) - OC-08 SNOW WHITE
STC 3	SMOOTH STUCCO FINISH (CLASS 4) - OC-19 SEAPEARL
STC 4	SMOOTH STUCCO FINISH (CLASS 4) - OC-16 FAIR CELERY
STE 1	30" X 30" STONE VENEER
PTW 1	WIDE FORMAT PORCELAIN TILE WITH WOOD GRAN PATTERN (DARK BROWN TEAK)
MTL 1	ALUMINUM, COLOR SATIN STEEL
MTL 2	ALUMINUM, COLOR SILVER
MTL 1	EXTERIOR METAL PANEL SYSTEM - SATIN STEEL
MTL 2	ALUMINUM, CORTEEN STEEL FINISH
GLZ 1	CLEAR GLAZING
GLZ 2	OPAQUE SPANDREL GLAZING

NOTE: NOT ALL MATERIALS ARE USED ON ALL BUILDINGS
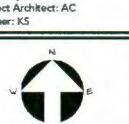
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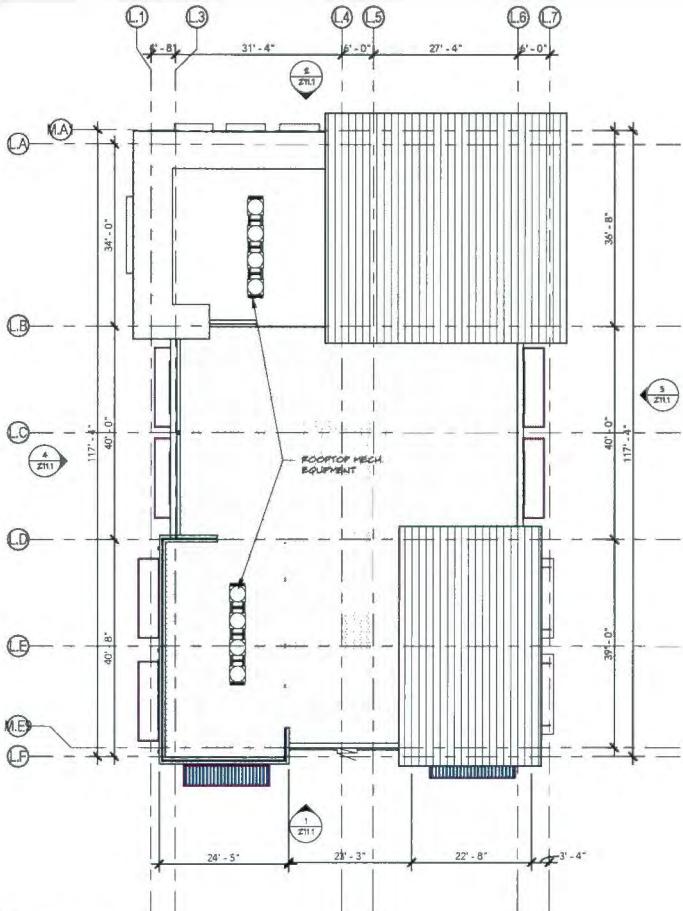
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BUILDING K
PALM BEACH GARDENS, FLORIDA

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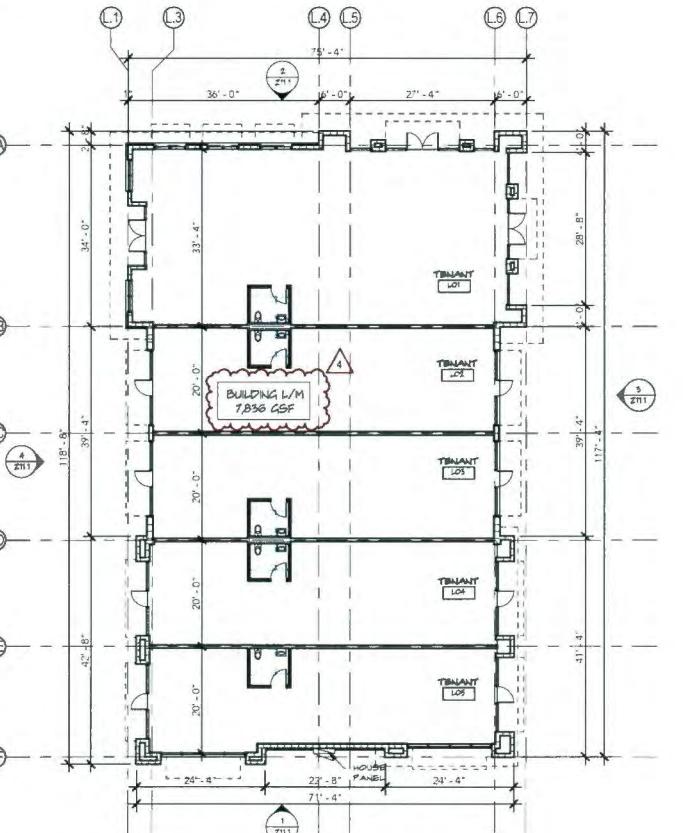
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Project No.: 13273
Date: 07/10/2015
Drawn by: ADC
Project Architect: AC
Partner: KS

BUILDING K - ELEVATIONS
Z9.1
ZONING SUBMITTAL



2 ROOF PLAN
Z11.0
Scale: 1/16" = 1'-0"



1 FLOOR PLAN
Z11.0
Scale: 1/16" = 1'-0"

BUILDING L/M - PLANS
Z11.0
ZONING SUBMITTAL

NEW CONSTRUCTION FOR:
ALTON TOWN CENTER
BUILDING L/M (ARCHITECTURAL MIRROR IMAGE)
PALM BEACH GARDENS, FLORIDA

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4 REVISION TO 07.20.16
SUBMITTAL

Project no. 13373
Date: 07/10/2015
Drawn by: ADC
Project Architect: ADC
Partner: KAS



Z11.0

ZONING SUBMITTAL

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**BUILDING L/M - ELEVATIONS**

Project no: 13273
Date: 07/10/2015
Drawn by: KM/FG
Project Architect: WC
Partner: KAS

Z11.1
ZONING SUBMITTAL

**NEW CONSTRUCTION FOR:
ALTON TOWN CENTER
BUILDING L/M (ARCHITECTURAL MIRROR IMAGE)
PALM BEACH GARDENS, FLORIDA**


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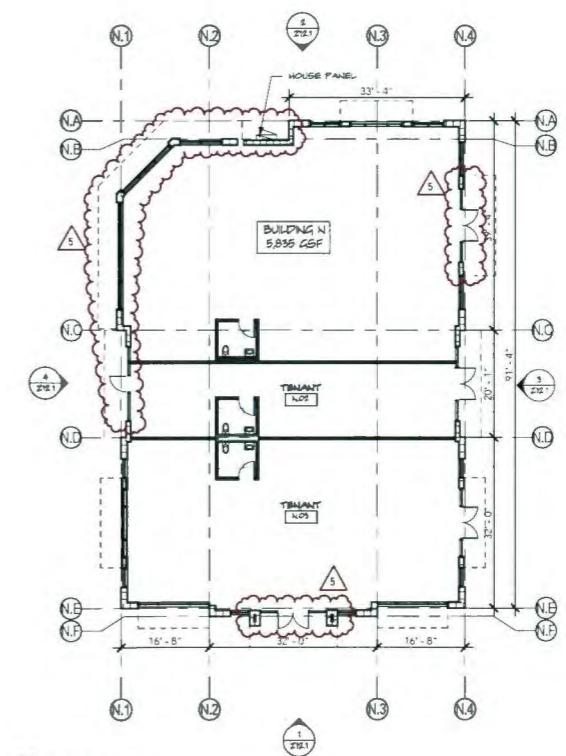
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File # A202019

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2
Z12.0 ROOF PLAN
Scale: 1/16" = 1'-0"



1
Z12.0 FLOOR PLAN
Scale: 1/16" = 1'-0"

BUILDING N - PLANS

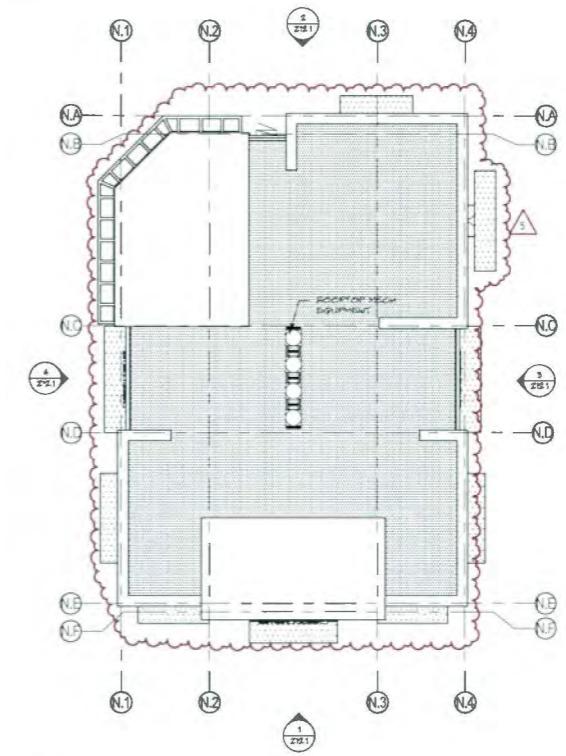Z12.0
ZONING SUBMITTAL

**NEW CONSTRUCTION FOR:
ALTON TOWN CENTER
BUILDING N
PALM BEACH GARDENS, FLORIDA**

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 5 REVISION TO 09.06.16
 SUBMITTAL

Project no. 13272
 Date: 07/10/2015
 Drawn by: KM
 Project Architect: WC
 Partner: KS



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 Architects + Interior Design
 John Glidden AIA #526 • Katie M. Spina AIA #349

FACADE MATERIAL & COLOR LEGEND

STC 1	SMOOTH STUCCO FINISH (CLASS A) - OC-11 CLAY BRICK
STC 2	SMOOTH STUCCO FINISH (CLASS A) - OC-00 SNOW WHITE
STC 3	SMOOTH STUCCO FINISH (CLASS A) - OC-19 SEAPEARL
STC 4	SMOOTH STUCCO FINISH (CLASS A) - OC-16 PALE CELERY
STB 1	30" X 30" STONE VENEER
PTWD 1	WIDE FORMAT PORCELAIN TILE WITH WOOD GRAIN PATTERN (DARK BROWN TEAK)
MTL 1	ALUMINUM, COLOR SILVER
MTL 2	ALUMINUM, COLOR SILVER
MTL 3	EXTERIOR METAL PANEL SYSTEM - SATIN STEEL
MTL 4	ALUMINUM, CORTEEN STEEL FINISH
GLZ 1	CLEAR GLAZING
GLZ 2	OPAQUE SPANDREL GLAZING

NOTE:
NOT ALL MATERIALS ARE USED ON ALL BUILDINGS


NEW CONSTRUCTION FOR:
ALTON TOWN CENTER
BUILDING N
PALM BEACH GARDENS, FLORIDA

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2	REVISION TO 04.15.16 SUBMITTAL
3	REVISION TO 06.29.16 SUBMITTAL
4	REVISION TO 07.20.16 SUBMITTAL
5	REVISION TO 09.06.16 SUBMITTAL

Project no.: 13273
Date: 07/10/2015
Drawn by: KM
Project Architect: WC
Partner: KS

Z12.1
ZONING SUBMITTAL

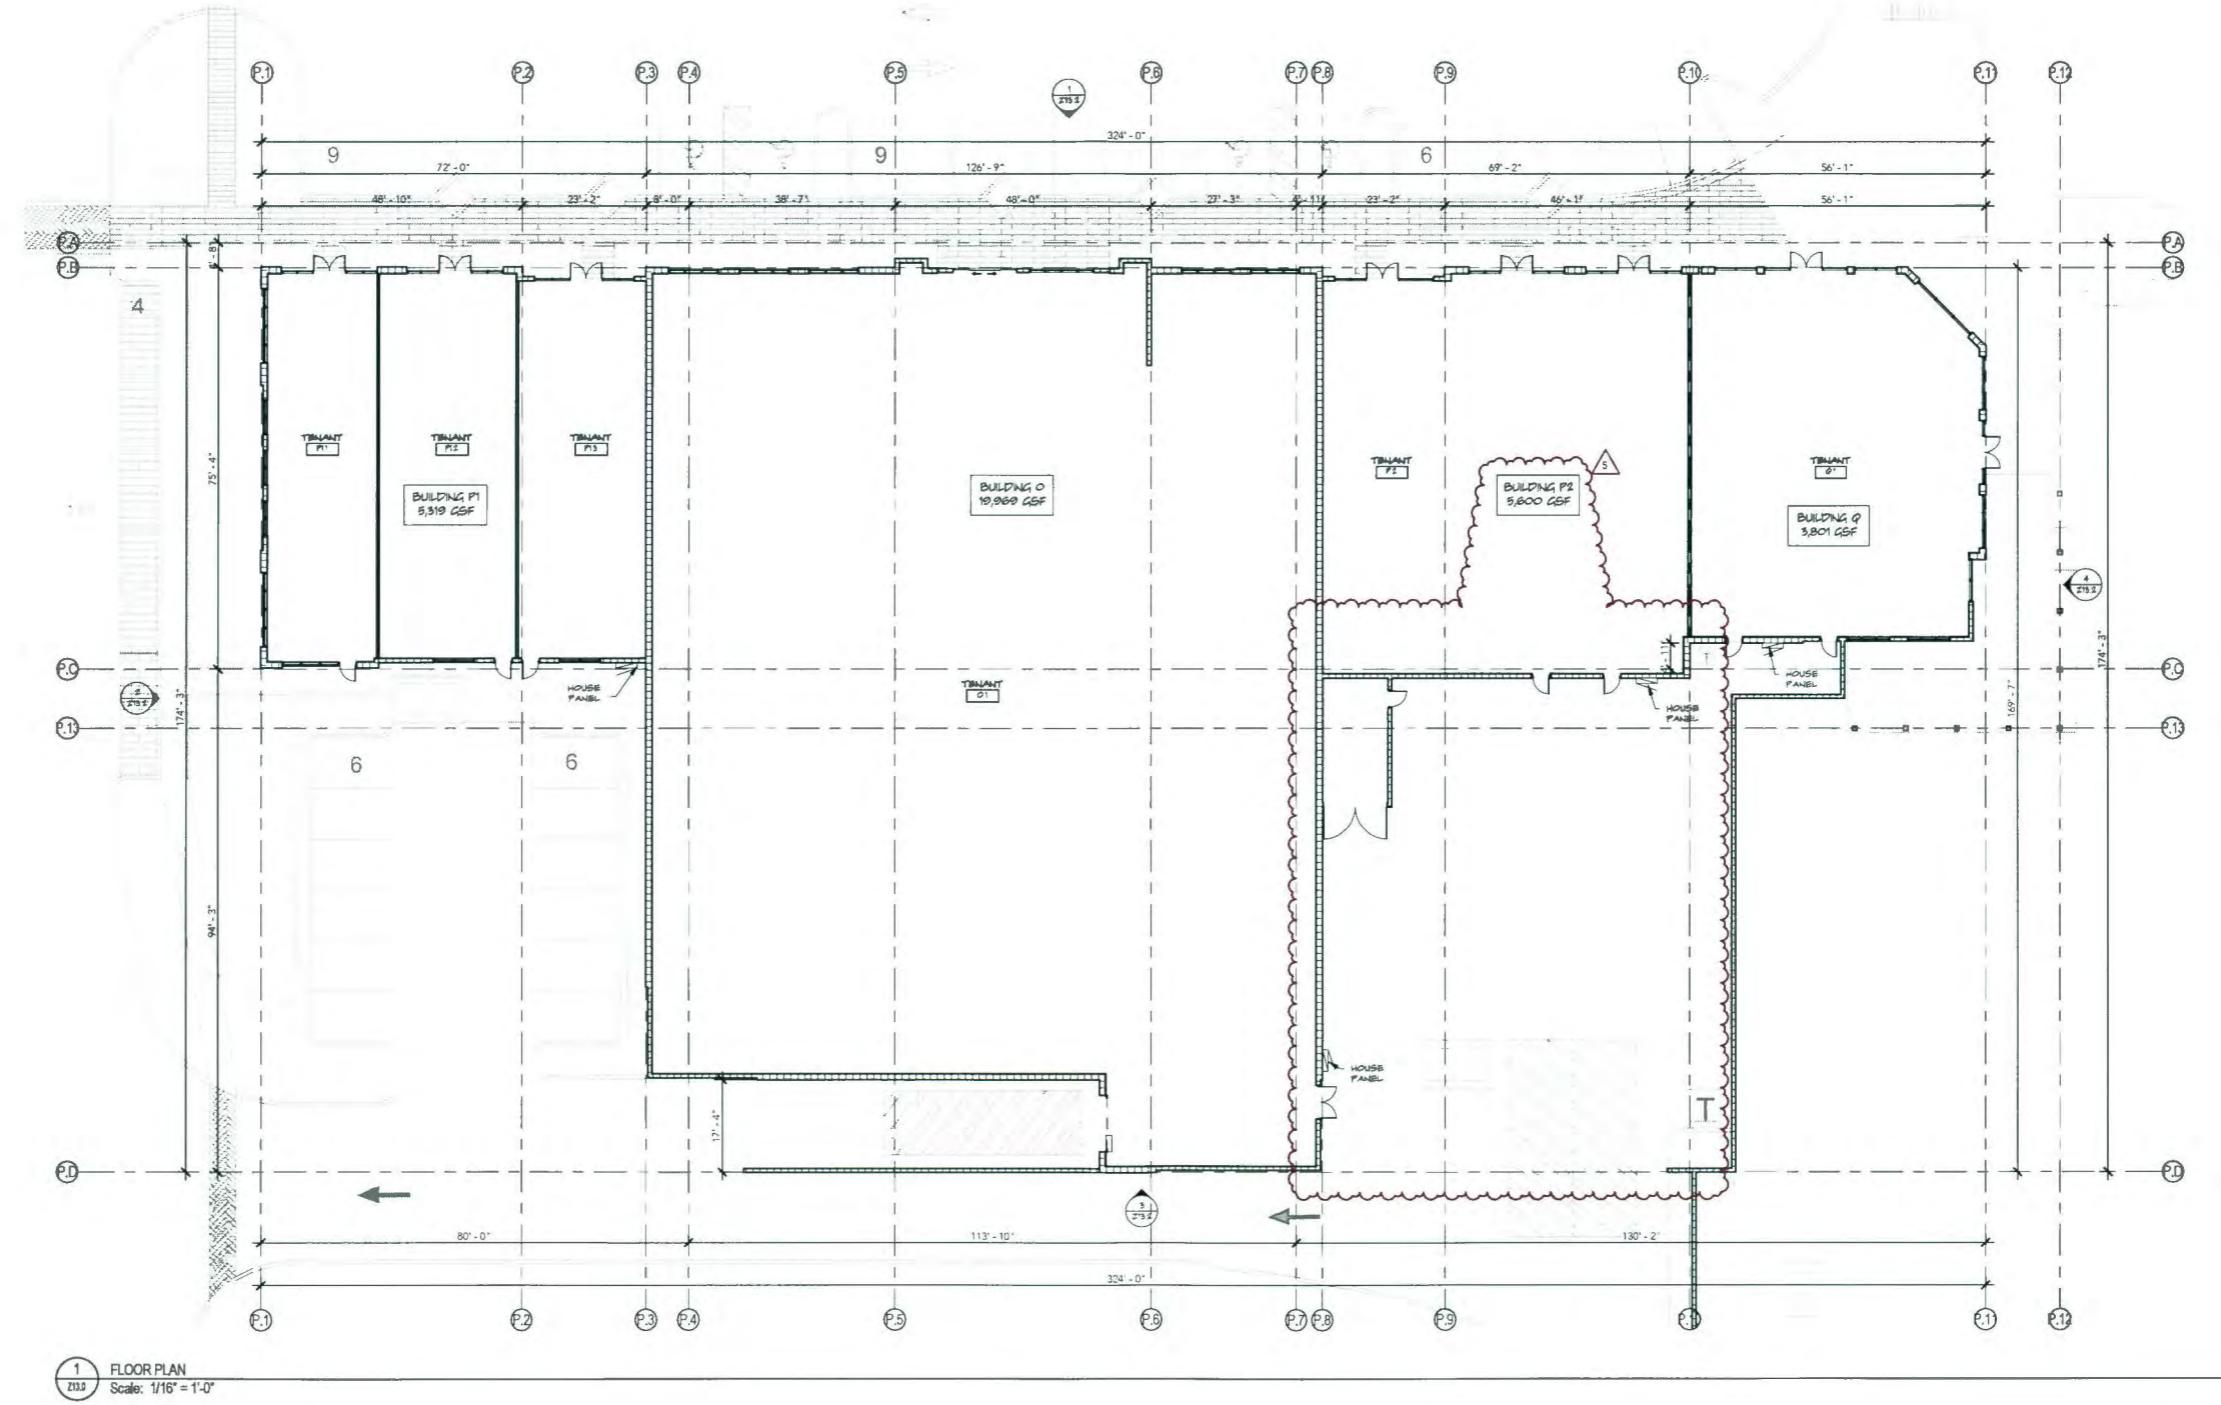


BUILDING O/P/Q - FLOOR PLAN

NEW CONSTRUCTION FOR:
ALTON TOWN CENTER
BUILDING O/P/Q
PALM BEACH GARDENS, FLORIDA


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SION TO	01.06.16
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SION TO	04.15.16
MITTAL	
SION TO	06.29.16
MITTAL	
SION TO	07.20.16
MITTAL	
SION TO	09.06.16

no: 13273
2/22/2015
by: AC
Architect: AC

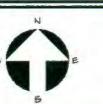

213.0

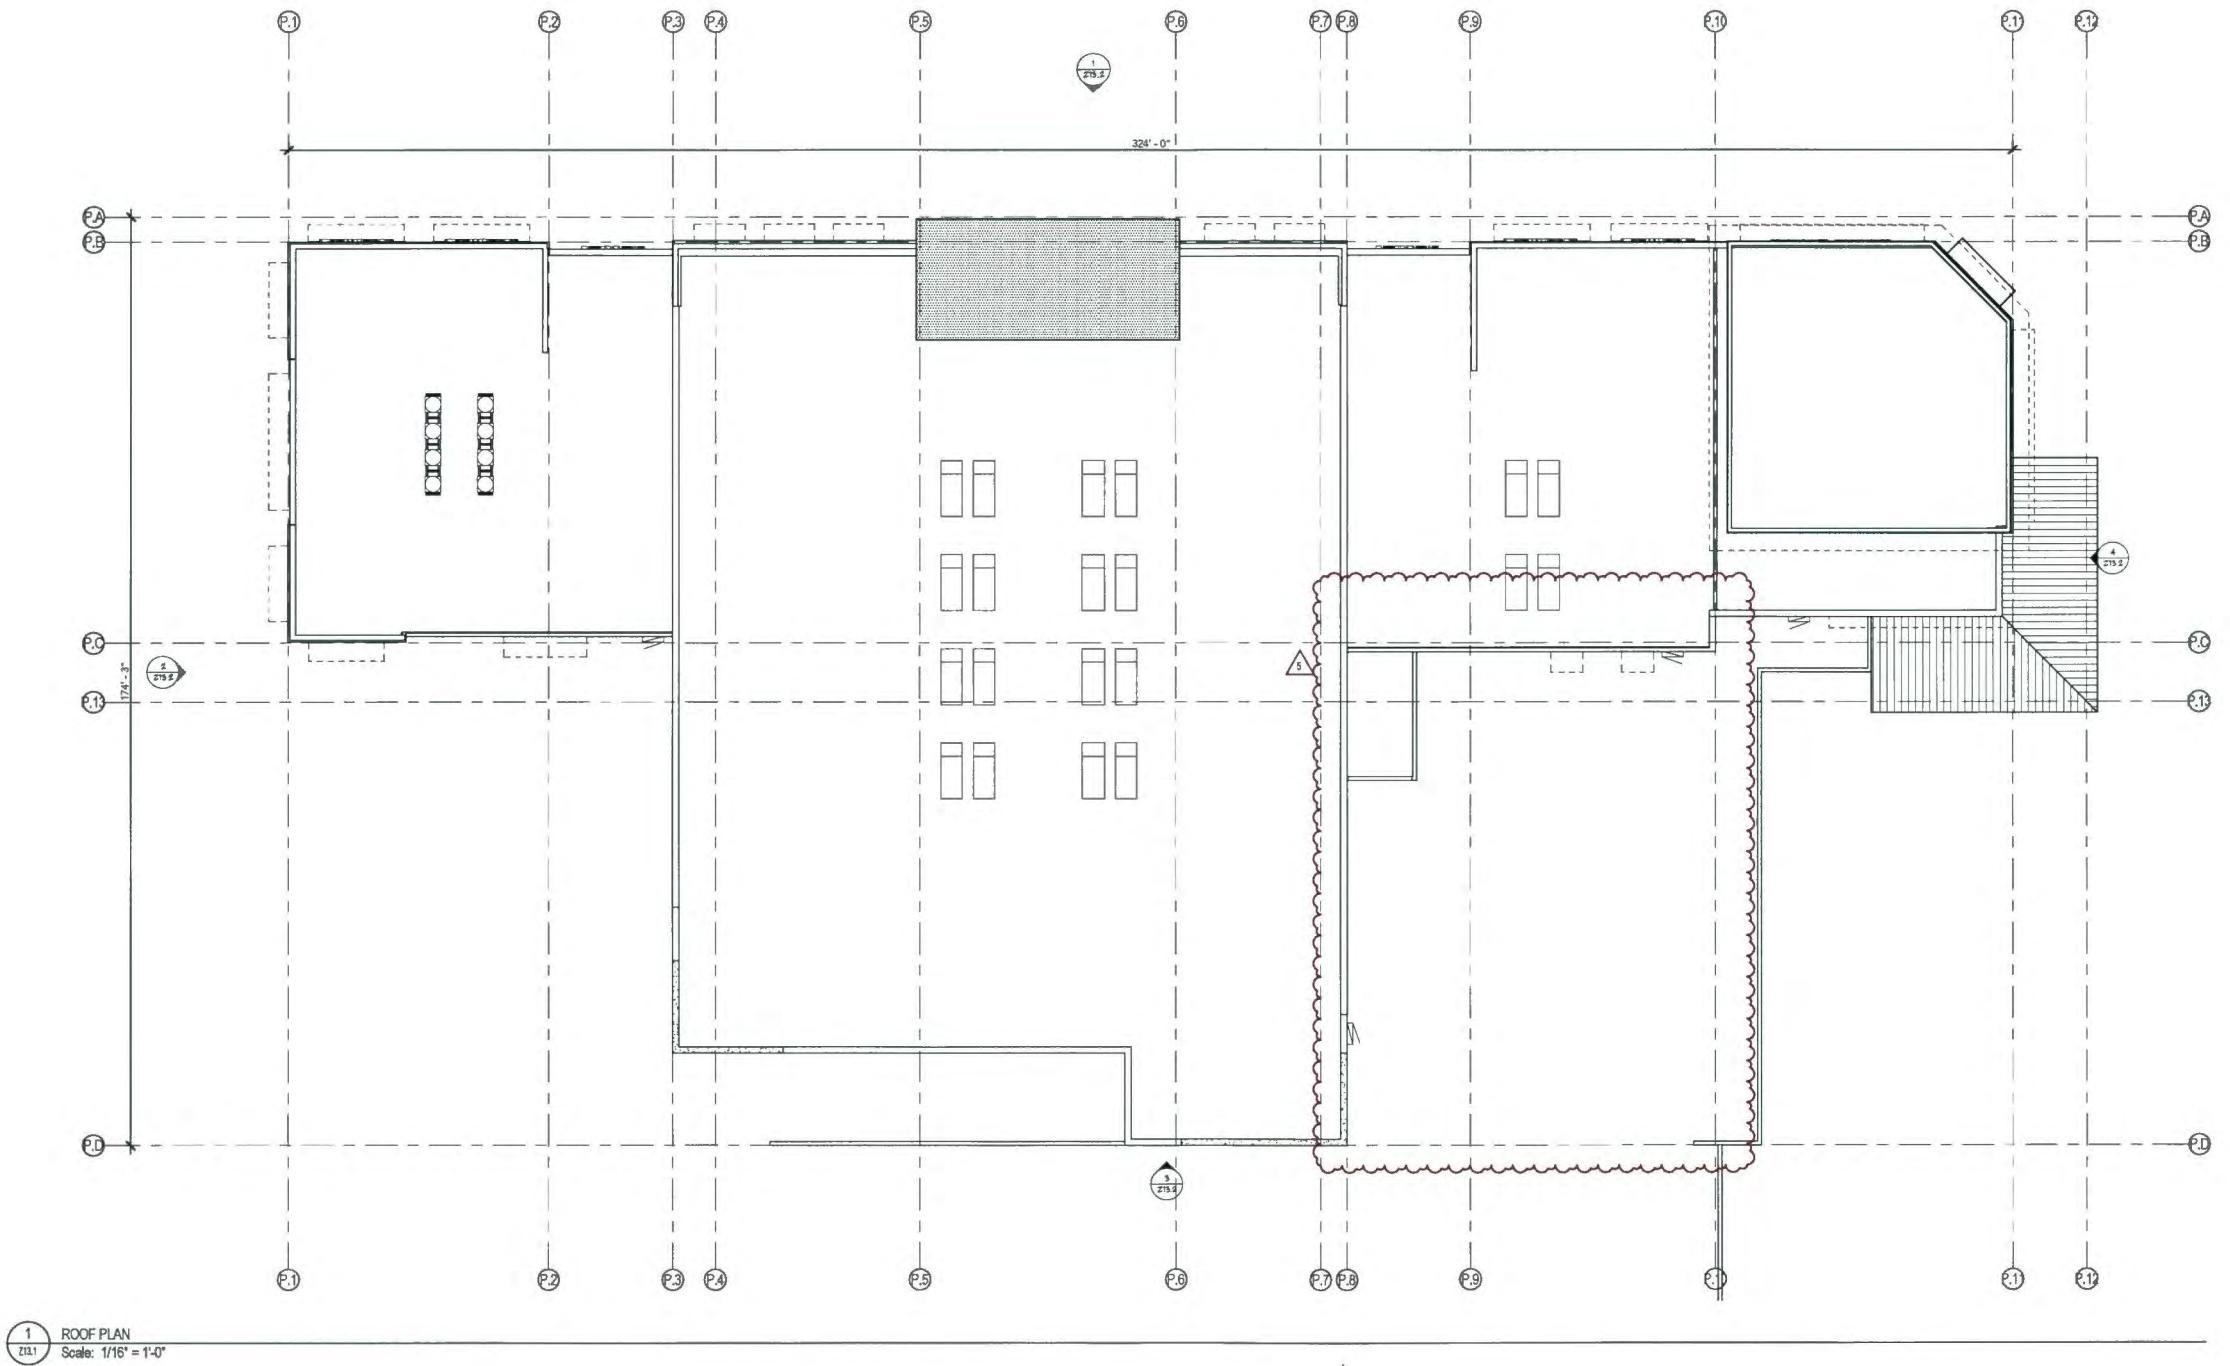

BUILDING O/P/Q - ROOF PLAN

Z13.1

ZONING SUBMITTAL


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BUILDING O/P/Q
PALM BEACH GARDENS, FLORIDA

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- 3 REVISION TO 06.29.16
- 4 REVISION TO 07.20.16
- 5 REVISION TO 09.06.16

Project no. 13273
Date: 12/22/2015
Drawn by: AC
Project Architect: AC
Partner: KAS



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John Glidden AIA/SA + Keith M. Spina AIA/SA
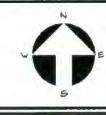
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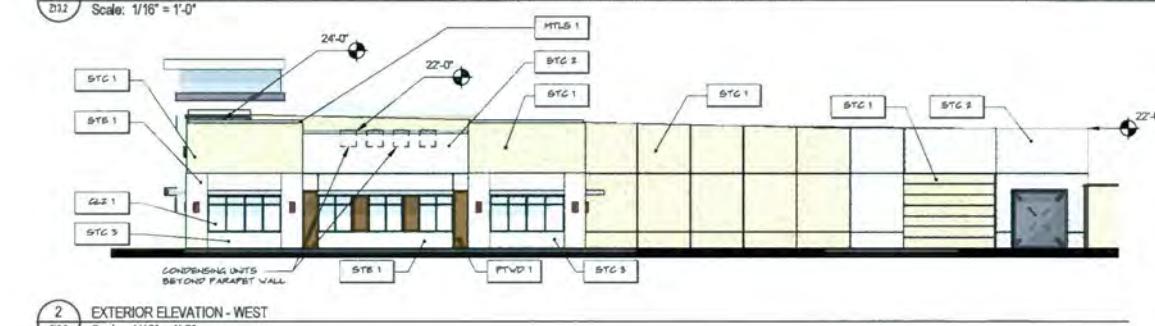
FAÇADE MATERIAL & COLOR LEGEND

BTG 1	SMOOTH STUCCO FINISH (CLASS A) - OG-11 CLAY BEIGE
BTG 2	SMOOTH STUCCO FINISH (CLASS A) - OG-03 SNOW WHITE
BTG 3	SMOOTH STUCCO FINISH (CLASS A) - OG-19 SEAPEARL
BTG 4	SMOOTH STUCCO FINISH (CLASS A) - OG-16 PALE CELERY
STB 1	30" X 30" STONE VENEER
PTWD 1	WIDE FORMAT PORCELAIN TILE WITH WOOD GRAIN PATTERN
MTL 1	ALUMINUM, COLOR SATIN STEEL
MTL 2	ALUMINUM, COLOR SILVER
MTL 3	EXTERIOR METAL PANEL SYSTEM
MT-S 2	ALUMINUM, CORTEEN STEEL FINISH
GLZ 1	CLEAR GLAZING
GLZ 2	OPAQUE SPANDREL GLAZING

NOTE: NOT ALL MATERIALS ARE USED ON ALL BUILDINGS




1 EXTERIOR ELEVATION - NORTH
D12 Scale: 1/16" = 1'-0"



2 EXTERIOR ELEVATION - WEST
D12 Scale: 1/16" = 1'-0"



3 EXTERIOR ELEVATION - SOUTH
D12 Scale: 1/16" = 1'-0"

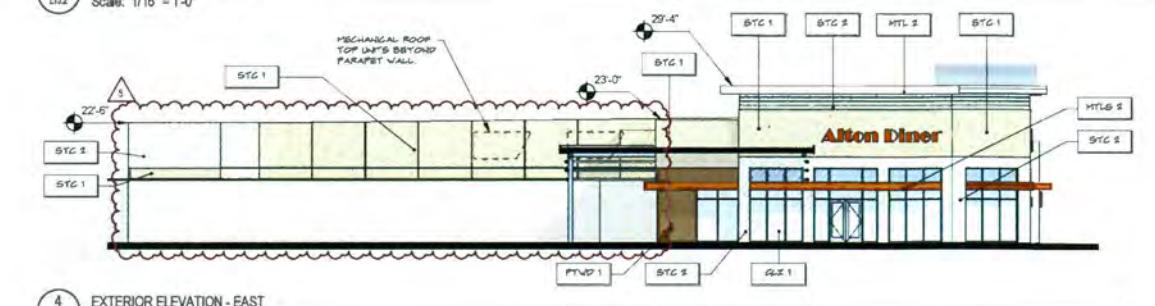

4 EXTERIOR ELEVATION - EAST
D12 Scale: 1/16" = 1'-0"

NEW CONSTRUCTION FOR:
ALTON TOWN CENTER
BUILDING O/P/Q
PALM BEACH GARDENS, FLORIDA



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 - 4 REVISION TO 07.20.16 SUBMITTAL
 - 5 REVISION TO 09.06.16 SUBMITTAL

Project no: 13273
Date: 12/22/2015
Drawn by: AC
Project Architect: AC
Partner: KAS

Z13.2
ZONING SUBMITTAL

Z13.2
ZONING SUBMITTAL

**BUILDING R - PLANS****Z14.0**

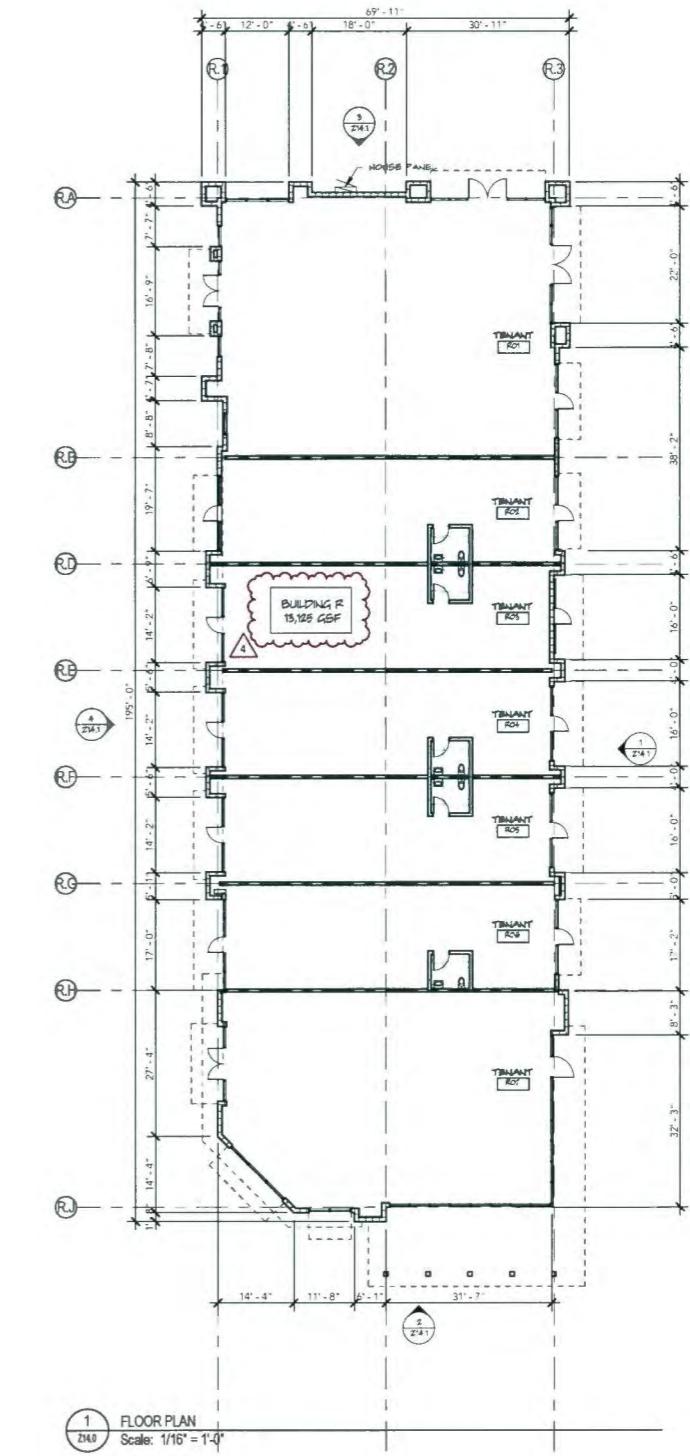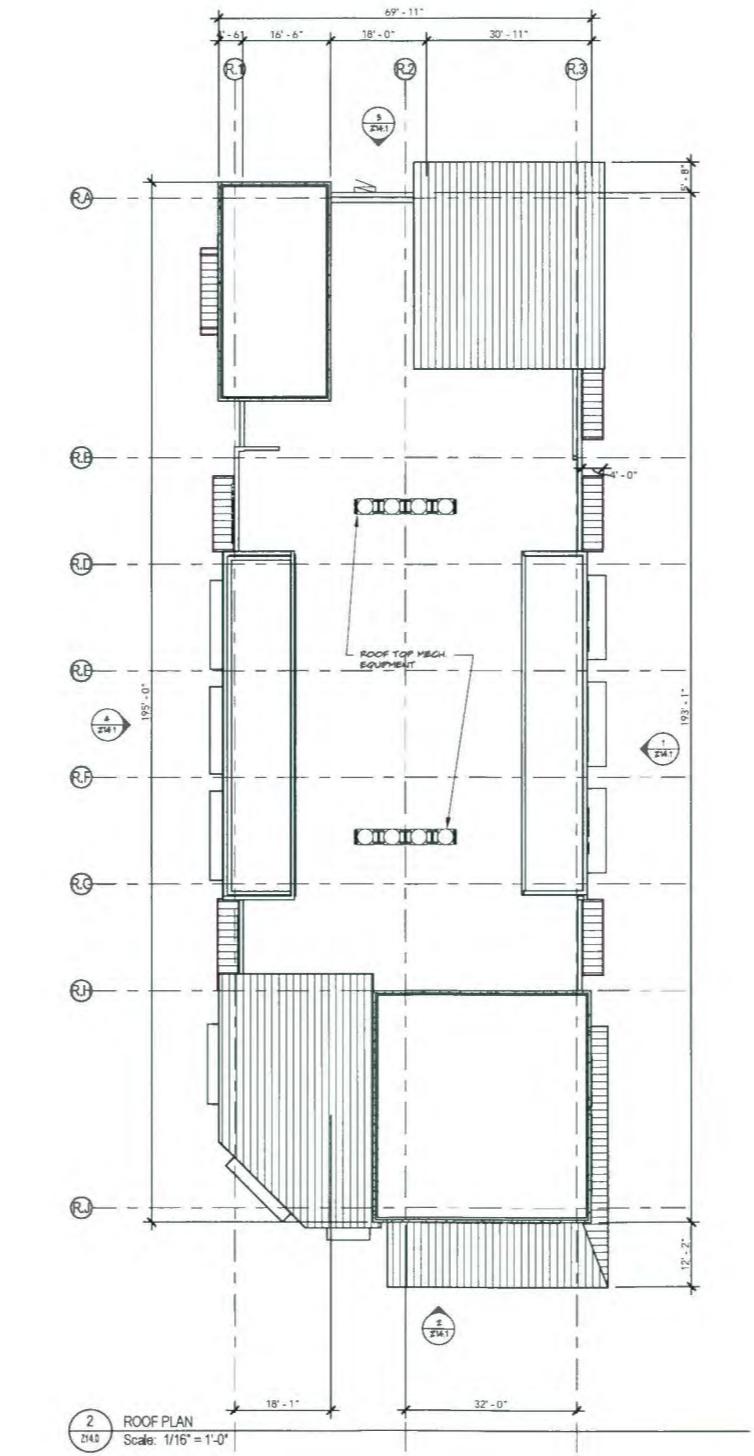ZONING SUBMITTAL



Project no: 13273
Date: 07/10/2015
Drawn by: AC
Project Architect: MA
Partner: KAS

Revisions:	
1	REVISION TO 01.06.16 SUBMITTAL
2	REVISION TO 04.15.16 SUBMITTAL
3	REVISION TO 06.29.16 SUBMITTAL
4	REVISION TO 07.20.16 SUBMITTAL

NEW CONSTRUCTION FOR:
ALTON TOWN CENTER
BUILDING R
PALM BEACH GARDENS, FLORIDA




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File No. A2020299

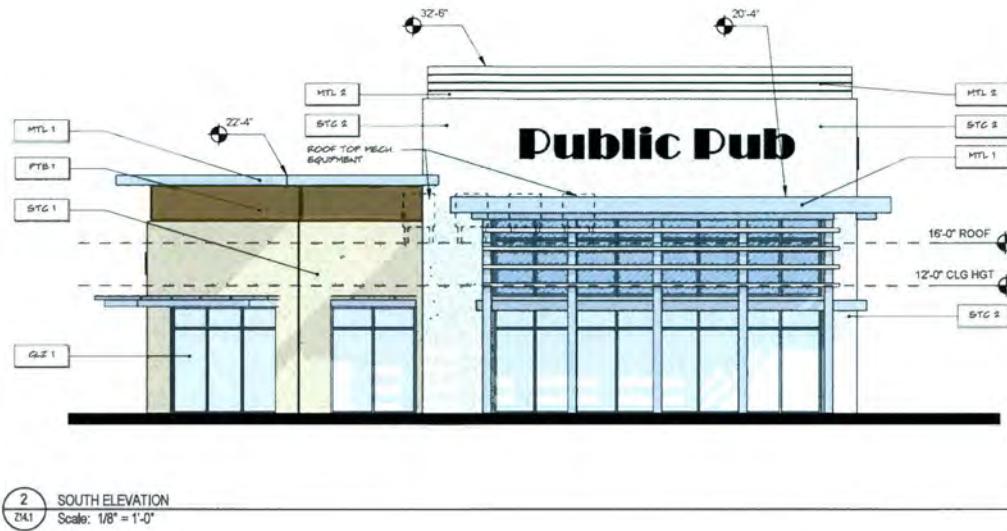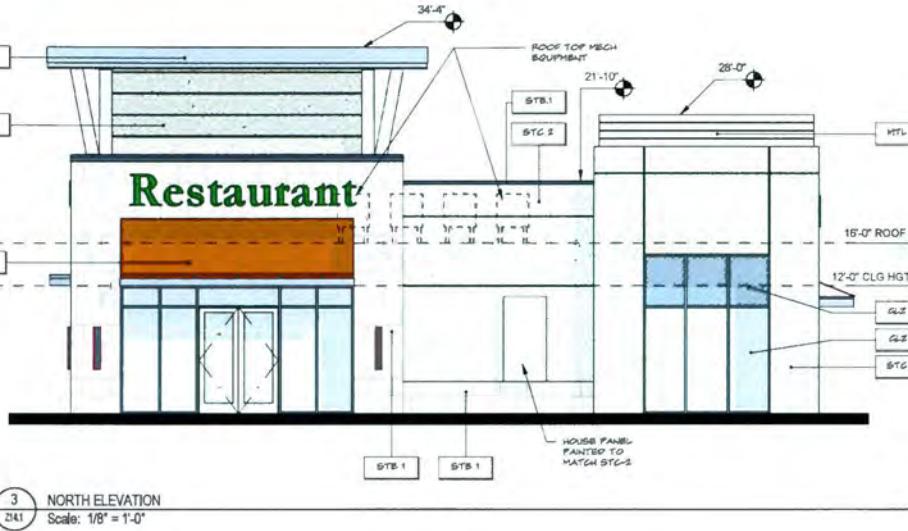

FAÇADE MATERIAL & COLOR LEGEND	
STG 1	SMOOTH STUCCO FINISH (CLASS 4) - OC-11 CLAY BEIGE
STG 2	SMOOTH STUCCO FINISH (CLASS 4) - OC-03 SNOW WHITE
STG 3	SMOOTH STUCCO FINISH (CLASS 4) - OC-19 SEAFARER
STG 4	SMOOTH STUCCO FINISH (CLASS 4) - OC-16 PALM CELERY
STB 1	50" X 20" STONE VENEER
PTB 1	WIDE FORMAT PORCELAIN TILE WITH WOOD GRAN PATTERN (DARK BROWN TEAK)
MTL 1	ALUMINUM COLOR SATIN STEEL
MTL 2	ALUMINUM COLOR SILVER
HTL 1	EXTERIOR METAL PANEL SYSTEM - SATIN STEEL
HTL 2	ALUMINUM CORTEEN STEEL FINISH
GLZ 1	CLEAR GLAZING
GLZ 2	OPAQUE SPANDREL GLAZING

NOTE:
NOT ALL MATERIALS ARE USED ON ALL BUILDINGS

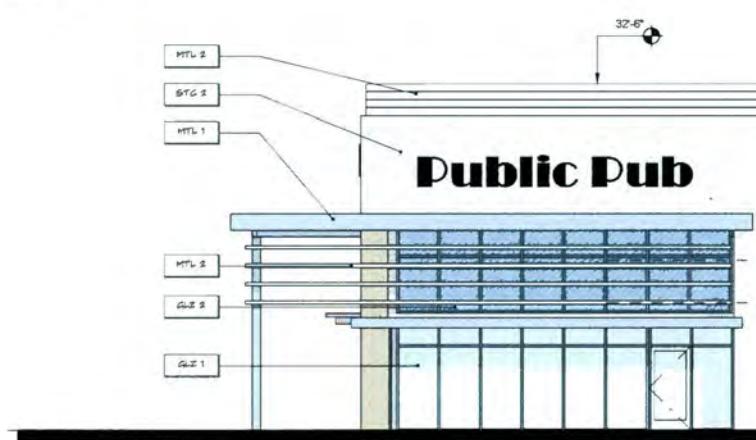

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3. REVISION TO 06.29.16 SUBMITTAL
4. REVISION TO 07.20.16 SUBMITTAL

Project no.: 13273
Date: 07/10/2015
Drawn by: AC
Project Architect: AC
Partner: KAS

Building R - ELEVATIONS

Z14.1

ZONING SUBMITTAL

Architecture + Interior Design


John Glidden • ASID • Palm Beach Gardens, FL

NEW CONSTRUCTION FOR:
ALTON TOWN CENTER
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BUILDING S - FLOOR PLAN


Z15.0
ZONING SUBMITTAL

NEW CONSTRUCTION FOR:
ALTON TOWN CENTER
BUILDING S
PALM BEACH GARDENS, FLORIDA

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4	REVISION TO 07.20.16 SUBMITTAL

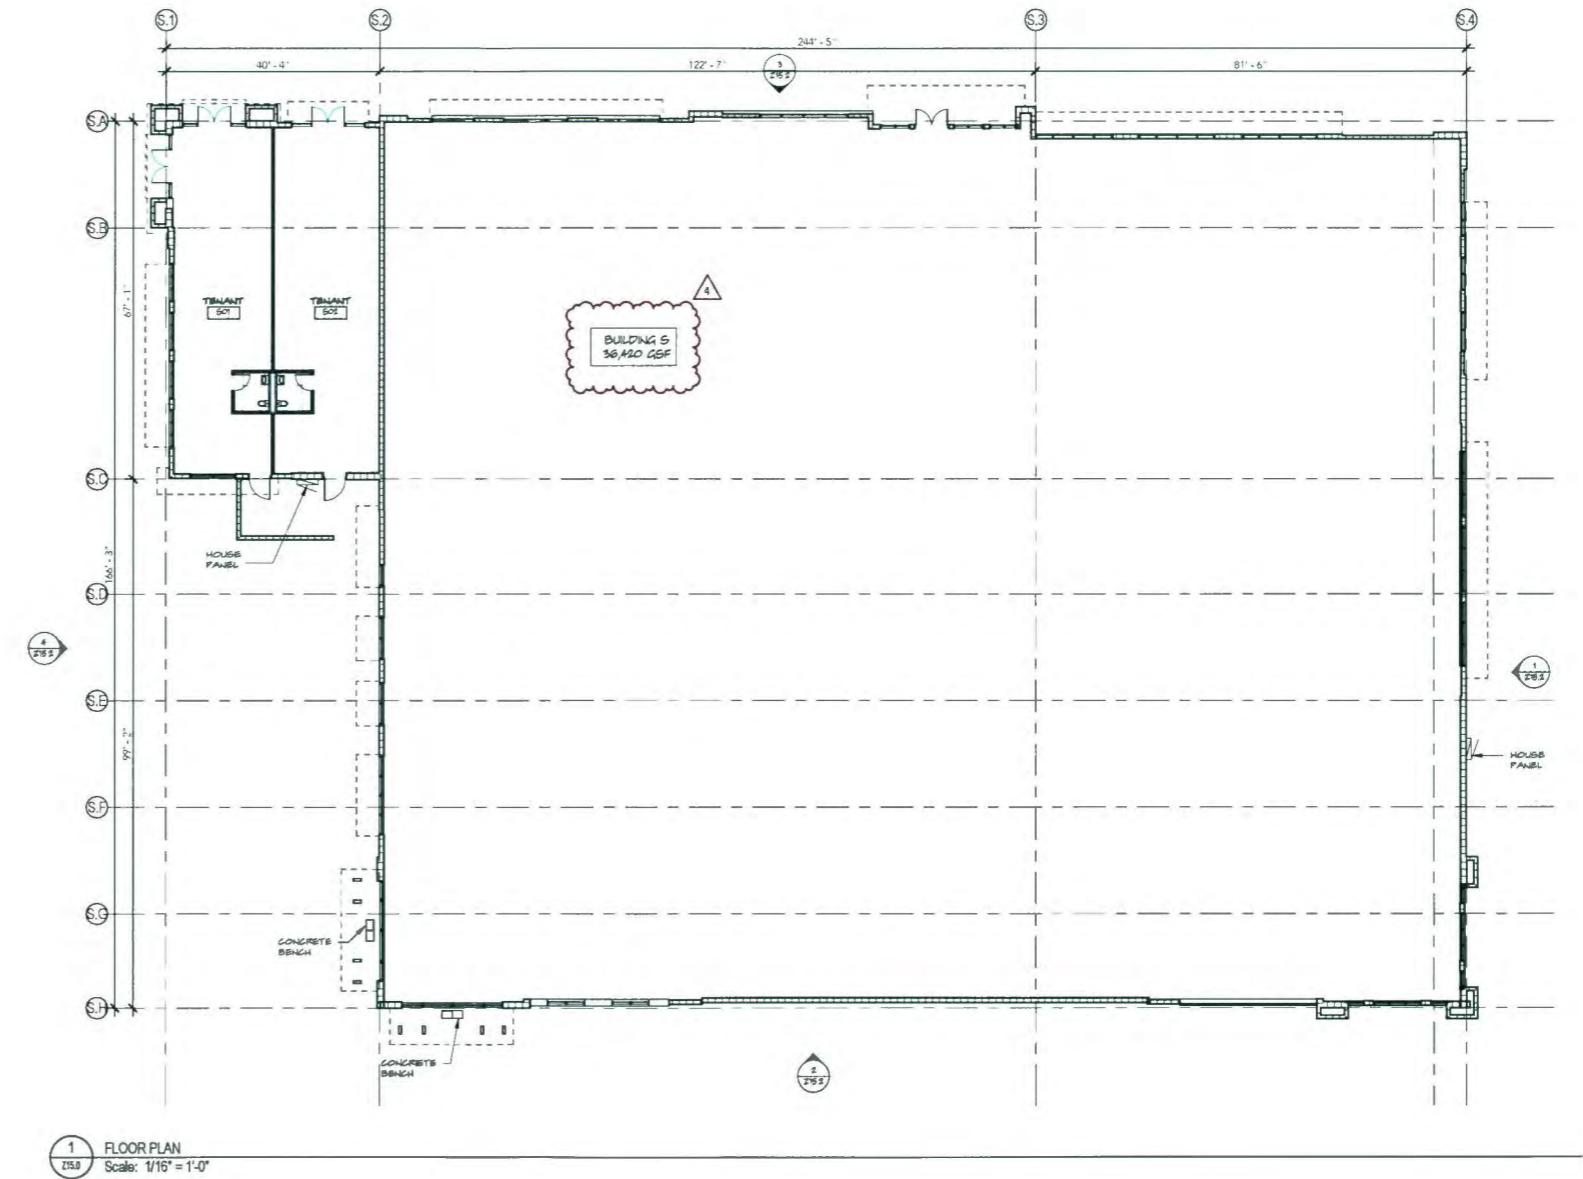Project no. 13273
Date: 07/10/2015
Drawn by: AC
Project Architect: MA
Partner: KS

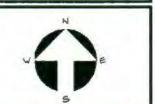


Z15.0

ZONING SUBMITTAL

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+ PARTNERS
Architects + Interior Design
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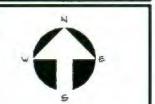
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gliddenplus.com
PLC #A2602399

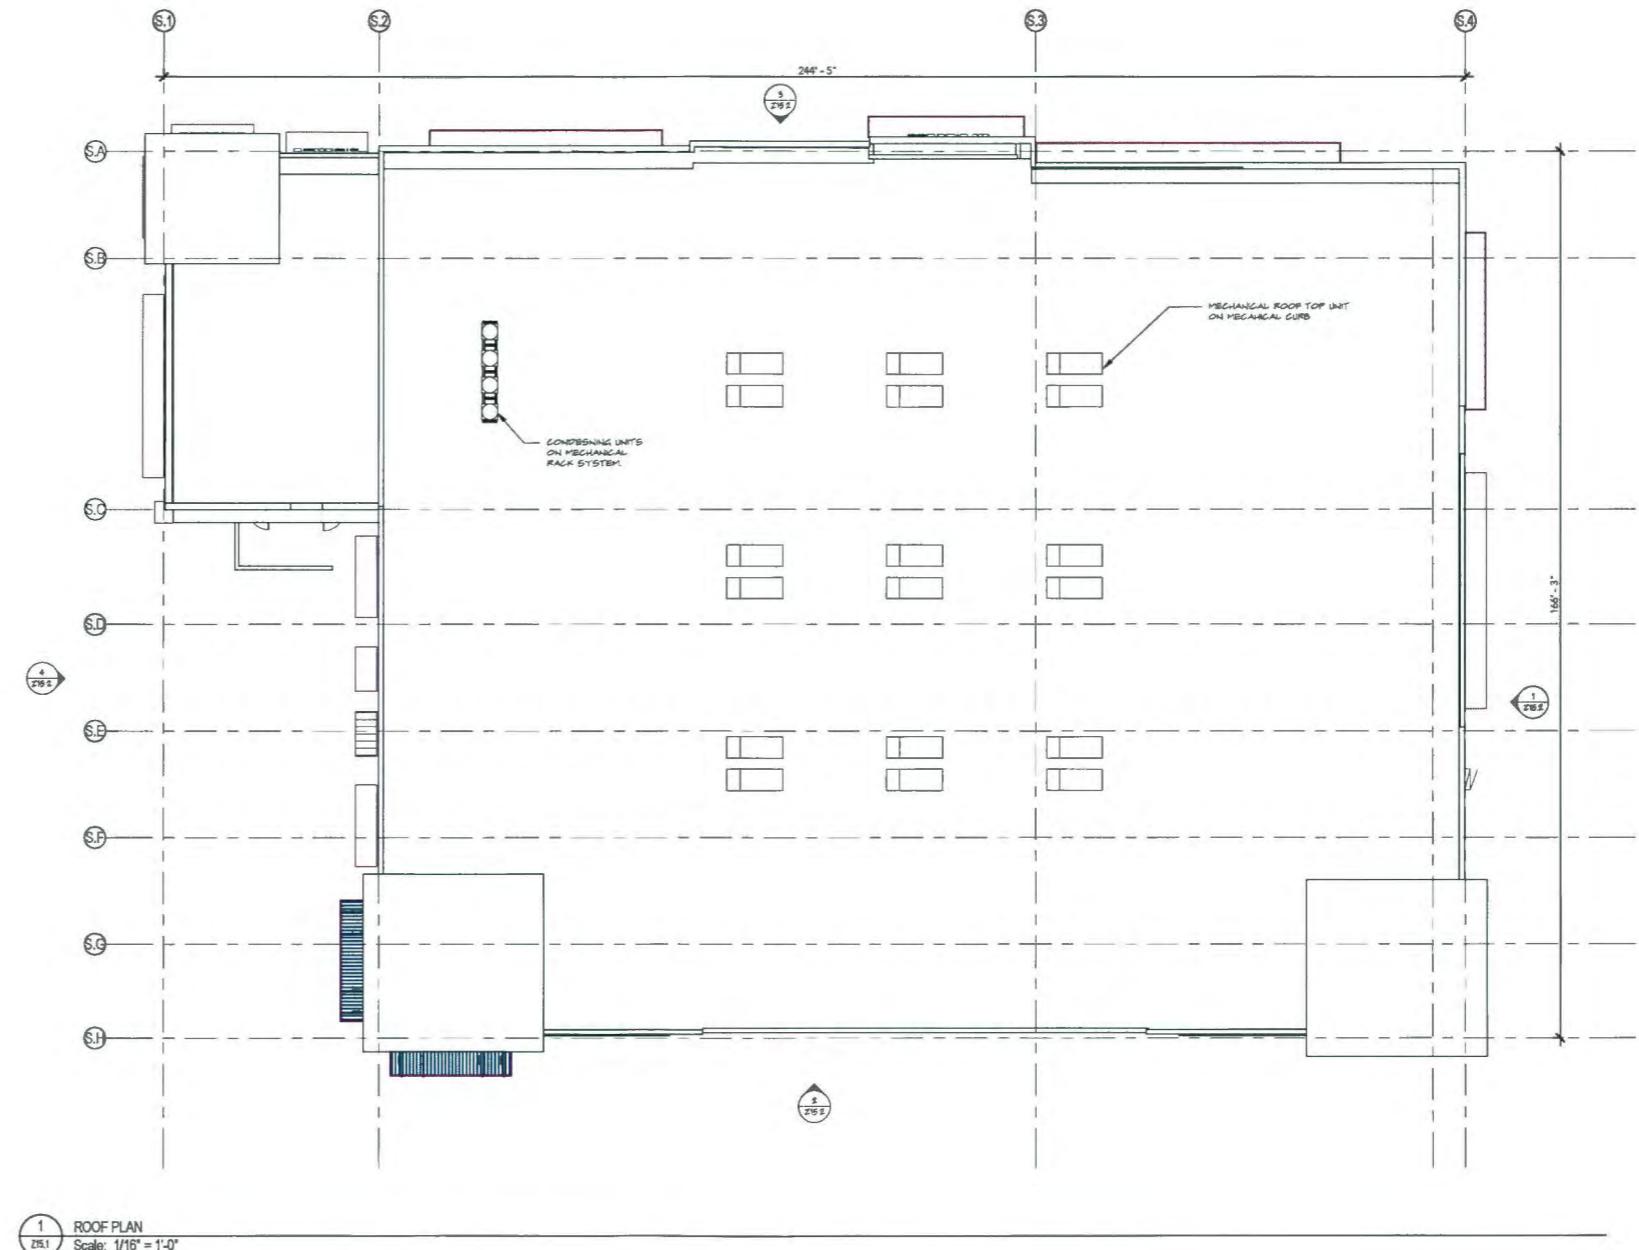

1 ROOF PLAN
Z15.1 Scale: 1/16" = 1'-0"

BUILDING S - ROOF PLAN

Project no. 13273
Date: 07/10/2015
Drawn by: KM
Project Architect: WC
Partner: KS



Z15.1

ZONING SUBMITTAL

NEW CONSTRUCTION FOR:
ALTON TOWN CENTER
PALM BEACH GARDENS, FLORIDA


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- 2 REVISION TO 04/15/16
SUBMITTAL
- 3 REVISION TO 06/29/16
SUBMITTAL
- 4 REVISION TO 07/20/16
SUBMITTAL


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T. Lee • AIA#202399

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John Glidden • AIA#35 • Keith M. Spina • AIA#19



FAÇADE MATERIAL & COLOR LEGEND	
STC 1	SMOOTH STUCCO FINISH (CLASS A) - OC-11 CLAY BEIGE
STC 2	SMOOTH STUCCO FINISH (CLASS A) - OC-66 SNOW WHITE
STC 3	SMOOTH STUCCO FINISH (CLASS A) - OC-19 SEASCAPE
STC 4	SMOOTH STUCCO FINISH (CLASS A) - OC-16 FADE CELERY
STB 1	10' X 20' STONE VENEER
PTB 1	WIDE FORMAT PORCELAIN TILE WITH WOOD GRAIN PATTERN (DARK BROWN TEAK)
MTL 1	ALUMINUM, COLOR BATH STEEL
MTL 2	ALUMINUM, COLOR SILVER
MTL 3	EXTERIOR METAL PANEL SYSTEM - BATH STEEL
MTL 4	ALUMINUM, CORTEEN STEEL FINISH
GLZ 1	CLEAR GLAZING
GLZ 2	OPAQUE SPANDREL GLAZING

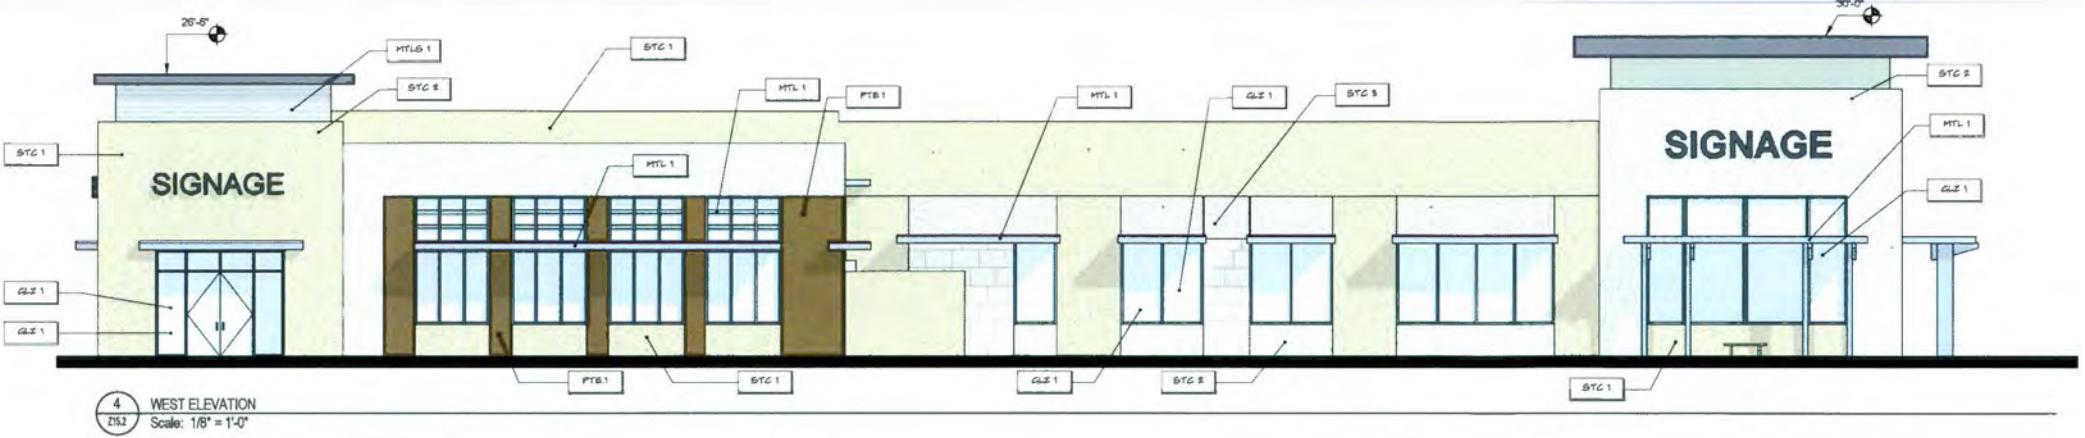NOTE: NOT ALL MATERIALS ARE USED ON ALL BUILDINGS

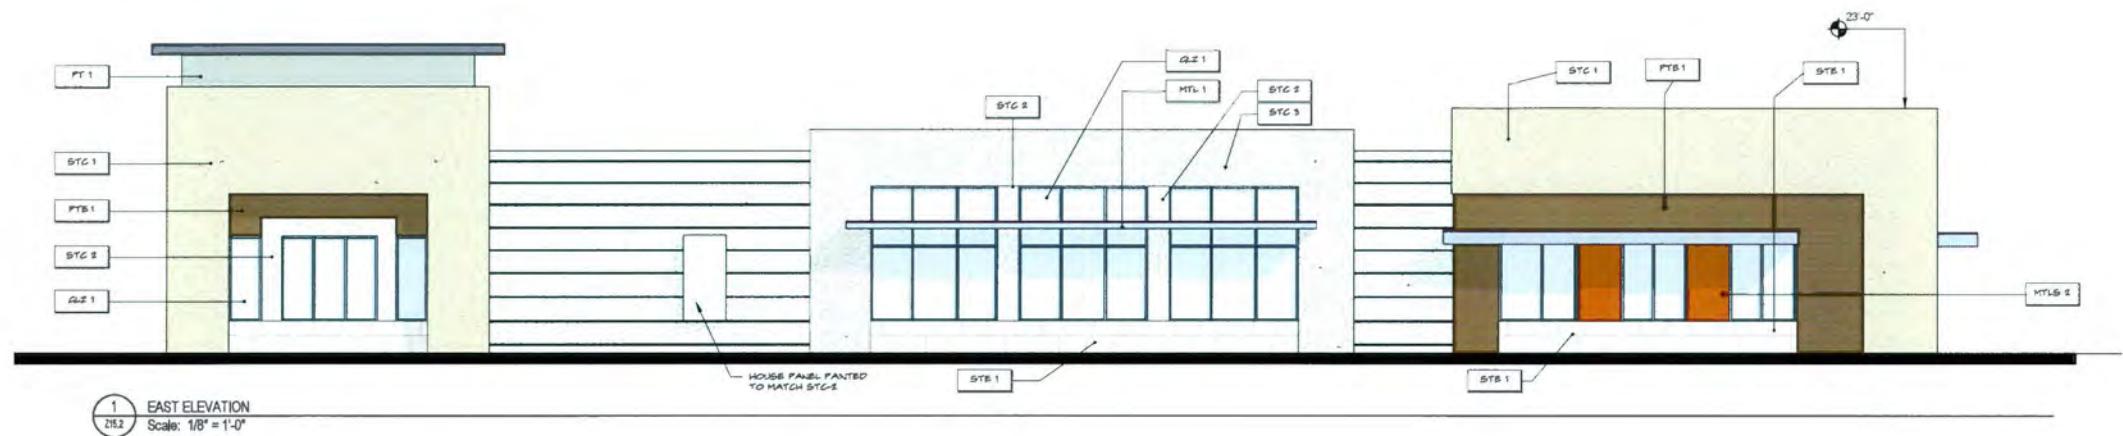



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BUILDINGS S
PALM BEACH GARDENS, FLORIDA**

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3 REVISION TO 06.29.16 SUBMITTAL
4 REVISION TO 07.20.16 SUBMITTAL

Project no. 13373
Date: 07/10/2015
Drawn by: AC
Project Architect: AC
Partner: KS

BUILDING S - ELEVATIONS
Z15.2
ZONING SUBMITTAL

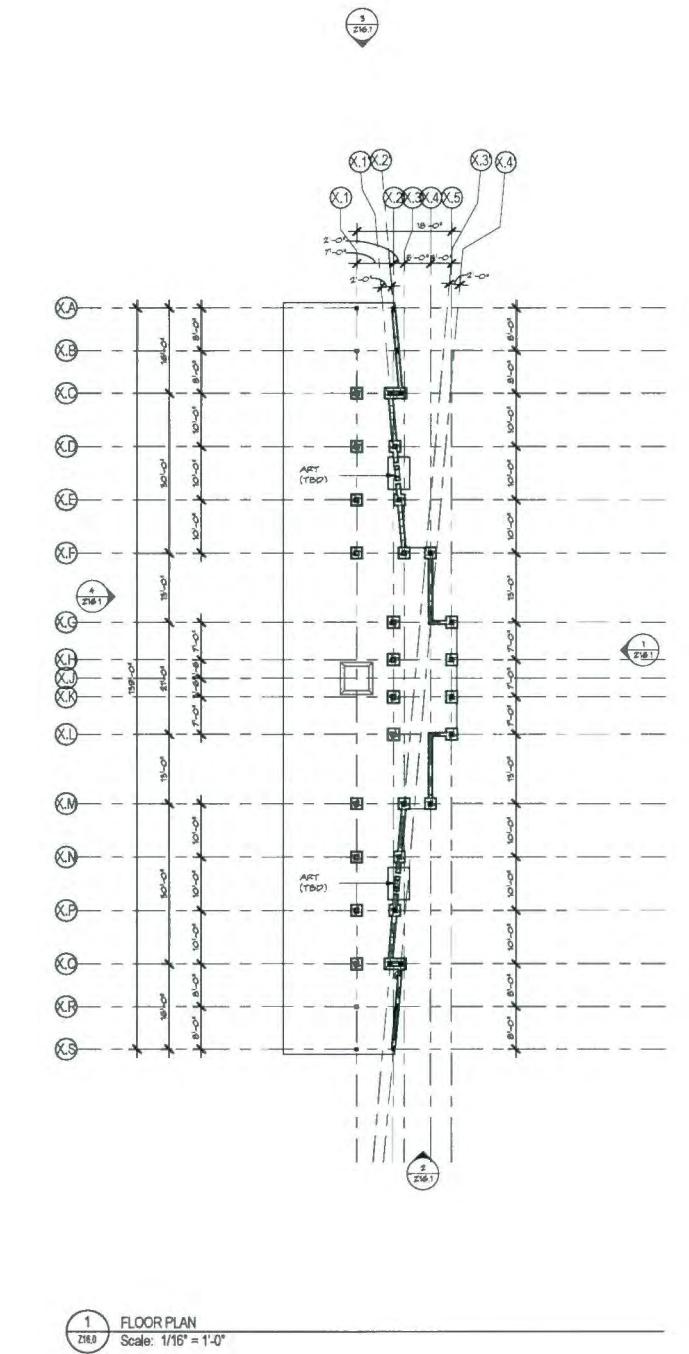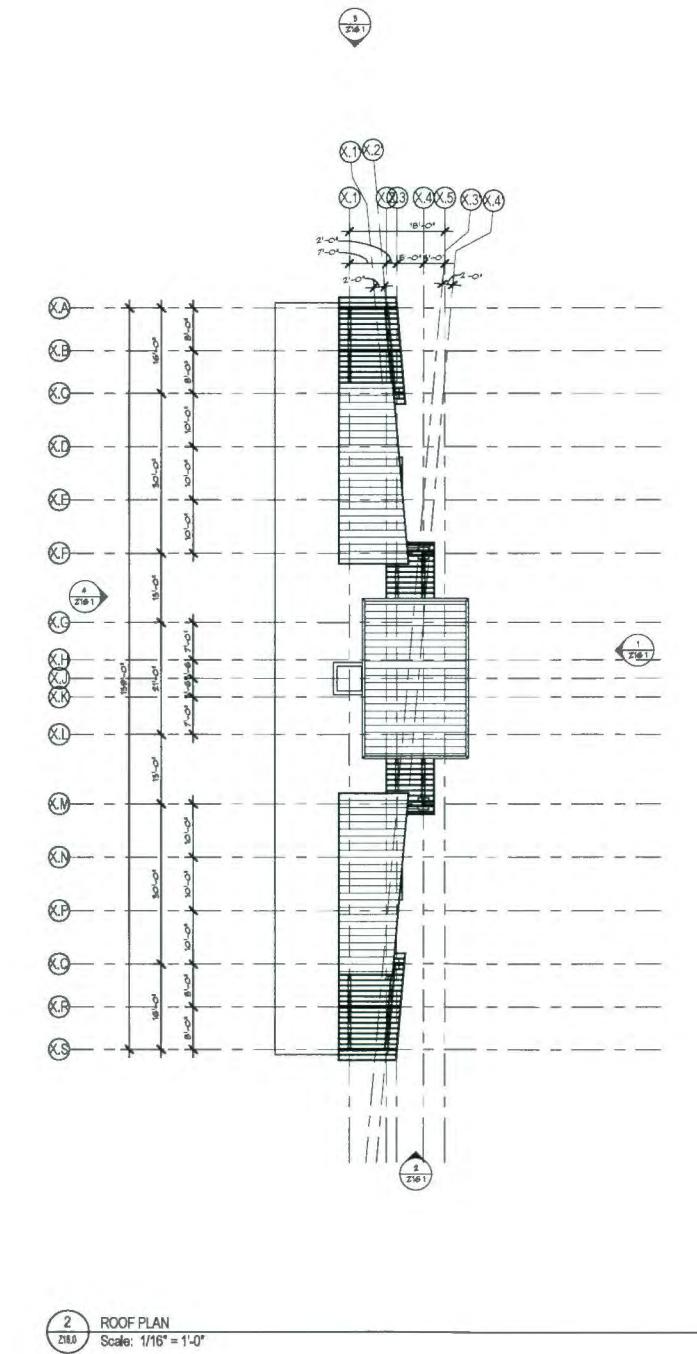

TRELLIS - PLANS

Z16.0

ZONING SUBMITTAL

PALM BEACH GARDENS, FLORIDA
NEW CONSTRUCTION FOR:
ALTON TOWN CENTER
BUILDING R

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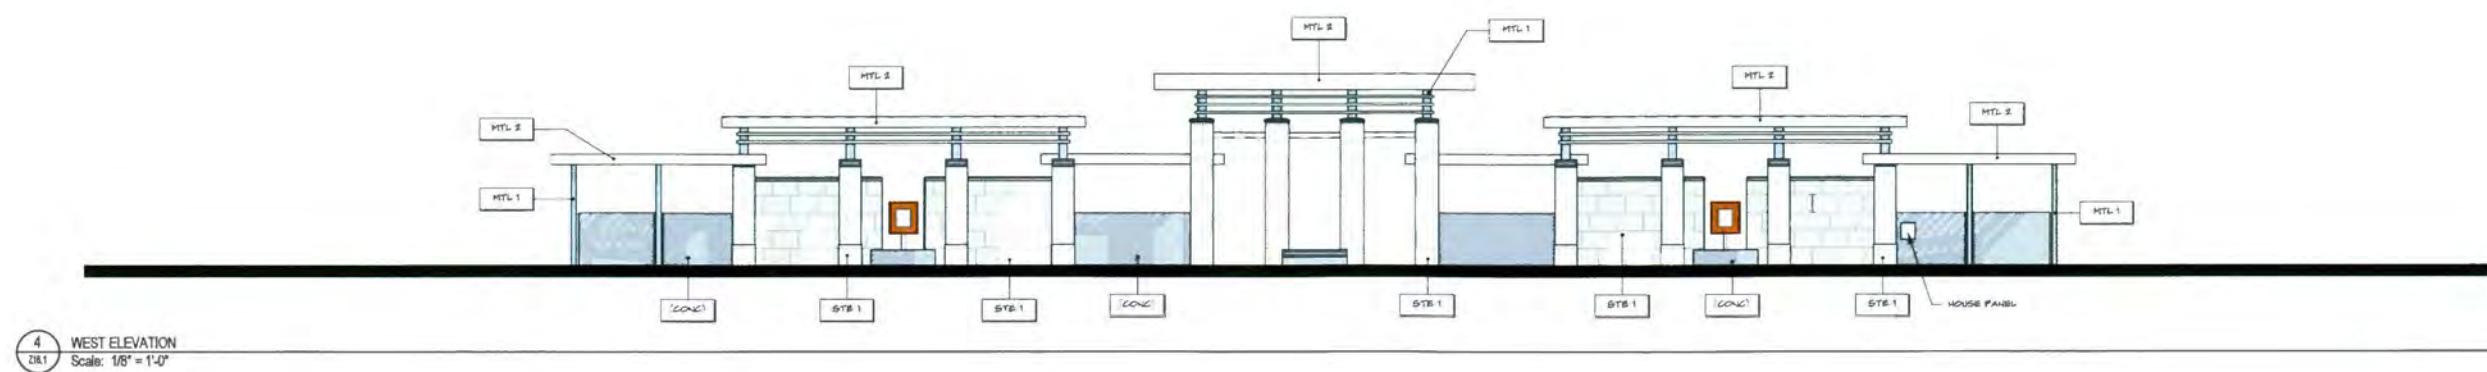
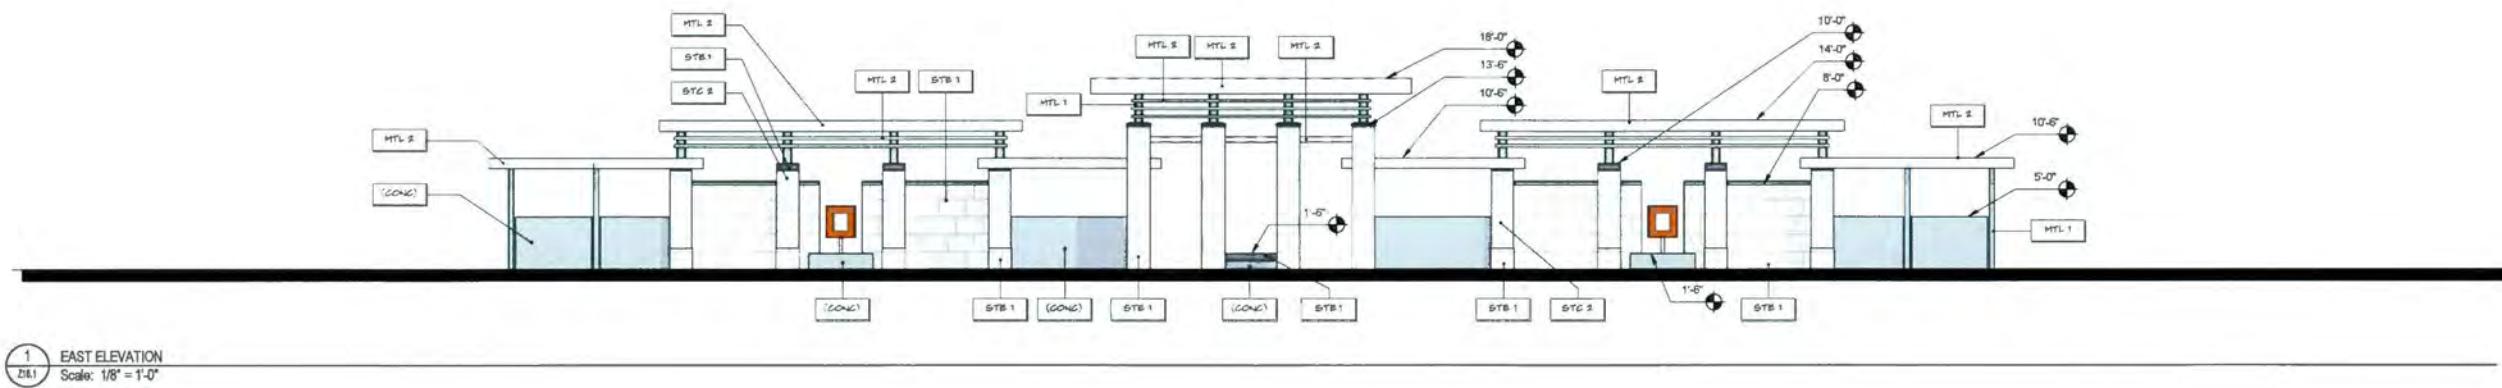
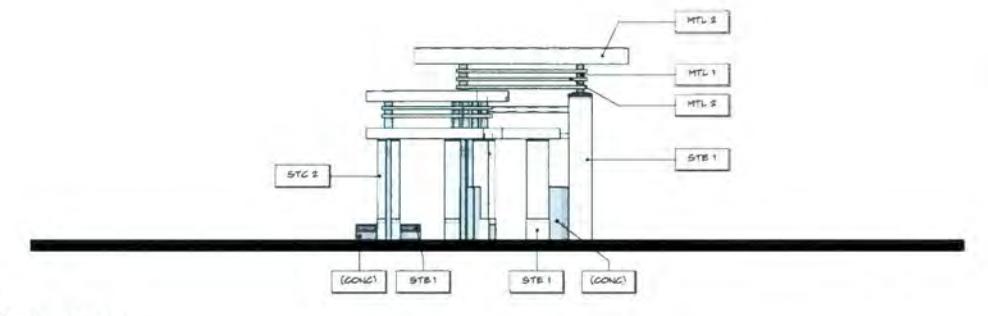
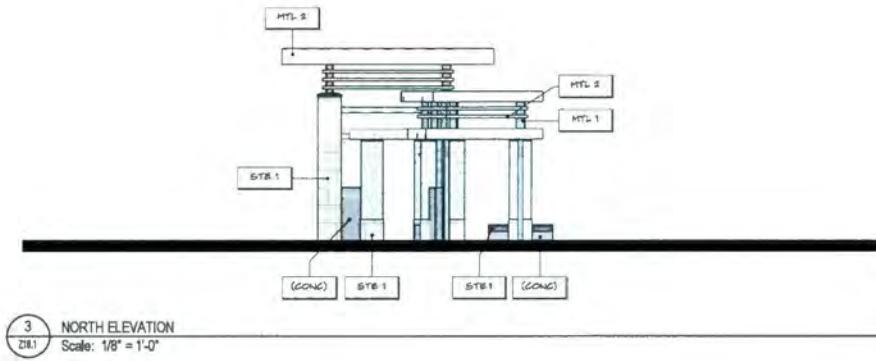
REVISION TO SUBMITTAL	0106
REVISION TO SUBMITTAL	0629
REVISION TO SUBMITTAL	0720

ect no: 13273
e: 07/10/2015
wn by: AC
ct Architect: MA
per: KAS



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ArchitectureInterior Design
DENSPIINA + PARTNERS
West Palm Beach Florida 33455
561.684.6844 Fax 561.684.5520
gldenring@juno.com
P.Lic # AA2002



FAÇADE MATERIAL & COLOR LEGEND	
STG 1	SMOOTH STUCCO FINISH (CLASS A) - OC-11 CLAY BEIGE
STG 2	SMOOTH STUCCO FINISH (CLASS A) - OC-08 SNOW WHITE
STG 3	SMOOTH STUCCO FINISH (CLASS A) - OC-19 SEAPEARL
STG 4	SMOOTH STUCCO FINISH (CLASS A) - OC-10 PALE CELERY
STB 1	30" X 30" STONE VENEER
PTB 1	WIDE FORMAT PORCELAIN TILE WITH WOOD GRAN PATTERN (DARK BROWN TEAK)
MTL 1	ALUMINUM COLOR SATIN STEEL
MTL 2	ALUMINUM COLOR SILVER
MTL 3	EXTERIOR METAL PANEL SYSTEM - SATIN STEEL
MTL 4	ALUMINUM, CORTEEN STEEL FINISH
GLZ 1	CLEAR GLAZING
GLZ 2	OPAQUE SPANDREL GLAZING
(CONC)	CAST IN PLACE CONCRETE

NOTE: NOT ALL MATERIALS ARE USED ON ALL BUILDINGS

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NEW CONSTRUCTION FOR:
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BUILDING R
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2	REVISION TO SUBMITTAL
3	REVISION TO SUBMITTAL
4	REVISION TO SUBMITTAL


Project no: 13273
Date: 07/10/2015
Drawn by: AC
Project Architect: AC
Partner: KAS

TRELLIS X - ELEVATIONS

Z16.1

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1

Z17.0

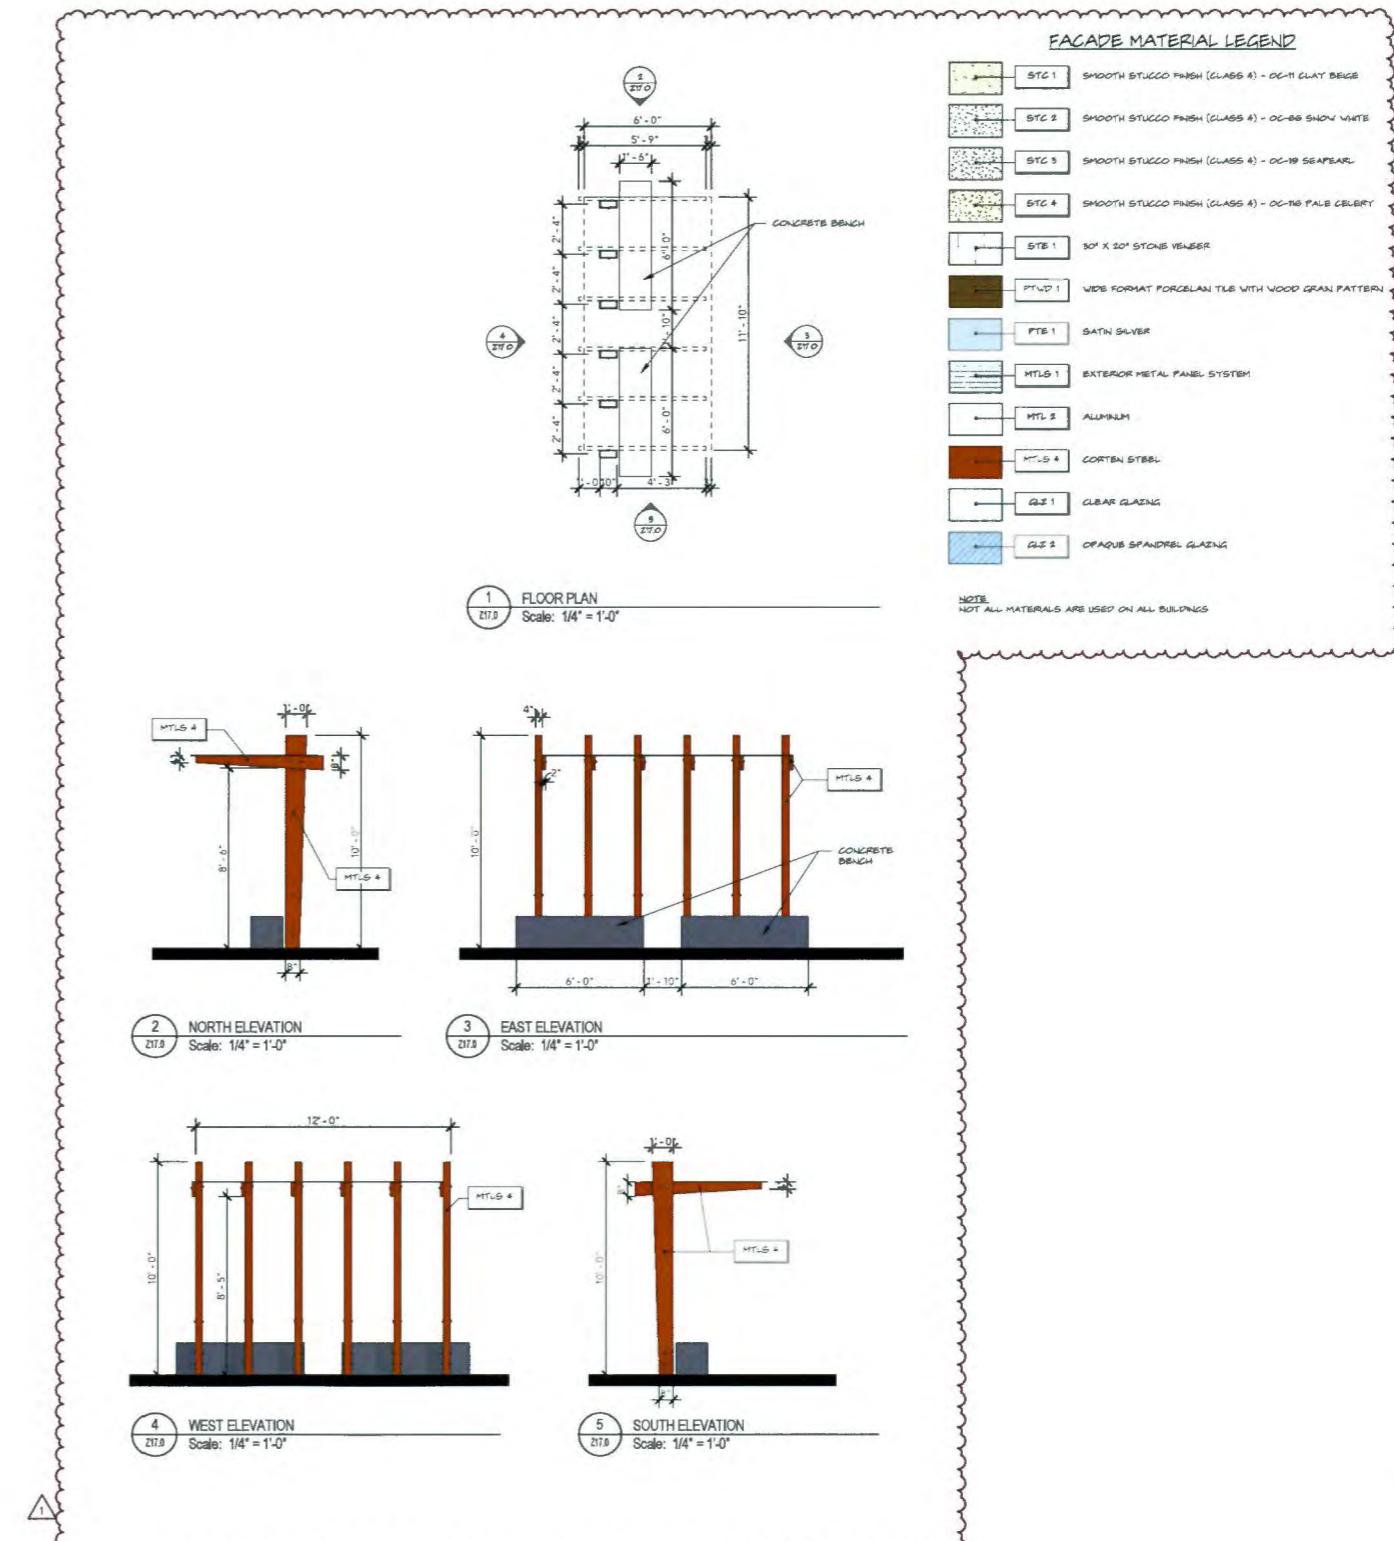SMALL TRELLIS - PLANS AND ELEVATIONS

Project no. 13273
Date: 07/10/2015
Drawn by: KM
Project Architect: KM
Partner: KS



Z17.0

ZONING SUBMITTAL

NEW CONSTRUCTION FOR:
ALTON TOWN CENTER
BUILDING N
PALM BEACH GARDENS, FLORIDA

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Revisions:
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FL Lic # A820299

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John Glidden + Associates • Keith M. Spina + Associates







FRONT - NORTH ELEVATION



REAR - SOUTH ELEVATION

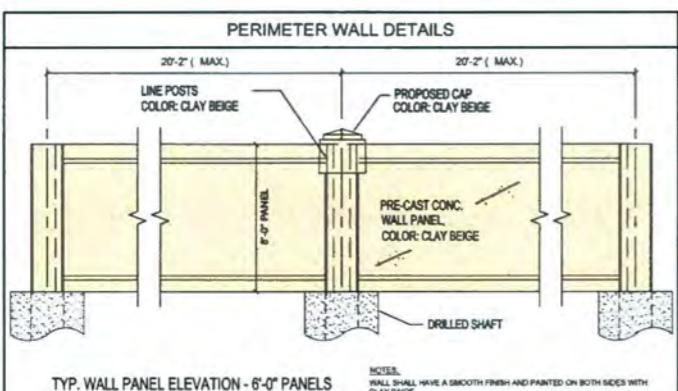

TYP. WALL PANEL ELEVATION - 6'-0" PANELS

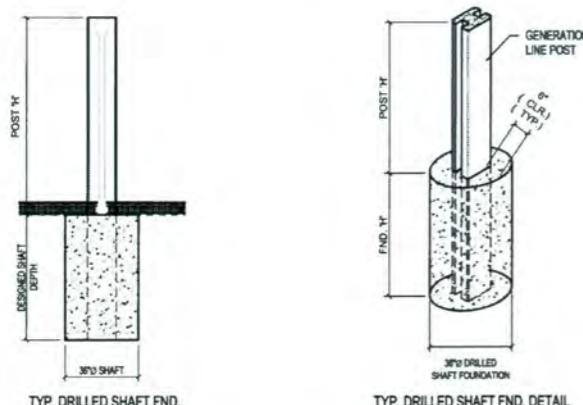


TYP. DRILLED SHAFT FND.


FAÇADE MATERIAL & COLOR LEGEND	
STC 1	SMOOTH STUCCO FINISH (CLASB A) - OC-11 CLAY BEIGE
STC 2	SMOOTH STUCCO FINISH (CLASB A) - OC-68 SNOW WHITE
STC 3	SMOOTH STUCCO FINISH (CLASB A) - OC-18 SEAPEARL
STC 4	SMOOTH STUCCO FINISH (CLASB A) - OC-16 PALE CEDAR
STC 5	SMOOTH STUCCO FINISH (CLASB A) - DARK BROWN TEAK
STB 1	30P X 20" STONE VENEER
MTL 1	ALUMINUM COLOR BATH STEEL
MTL 2	ALUMINUM COLOR SILVER
MTL 3	EXTERIOR METAL PANEL SYSTEM
MTL 4	ALUMINUM, CORTEN STEEL FINISH
GZ 1	CLEAR GLAZING
GZ 2	OPAQUE SPANDREL GLAZING
PTG 1	CUSTOM BLUE COLOR, PROVIDED BY LOWE'S

NOTES:
WALL SHALL HAVE A SMOOTH FINISH AND PAINTED ON BOTH SIDES WITH CLAY BASE
WALL AS MANUFACTURED BY OLD CASTLE PRECAST, INC. DURATEK

NOT ALL MATERIALS ARE USED ON ALL BUILDINGS

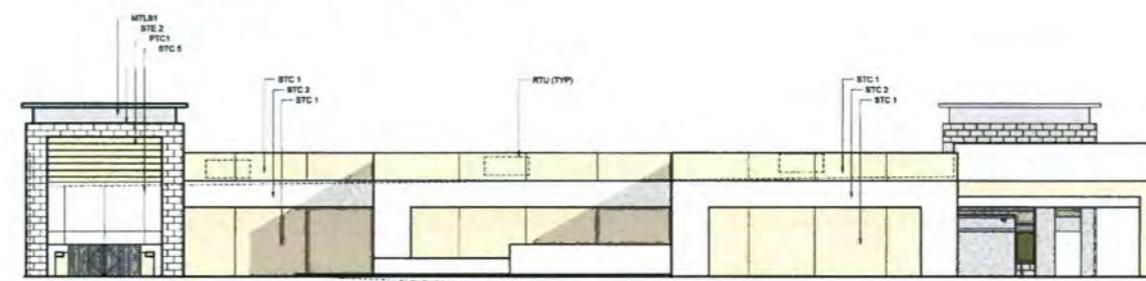

LEFT - EAST ELEVATION

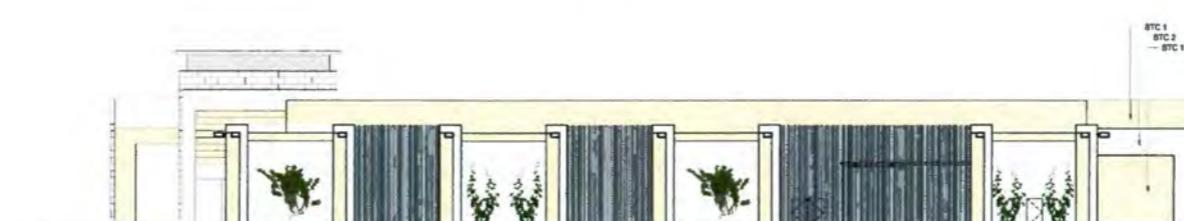

RIGHT - WEST ELEVATION

COLORED ELEVATIONS

LOWE'S OF
ALTOM TOWN CENTER: BUILDING T - PHASE 2
PALM BEACH GARDENS, FLORIDA
PROJECT No. 12251 | DRAWN BY: CHECKED BY:



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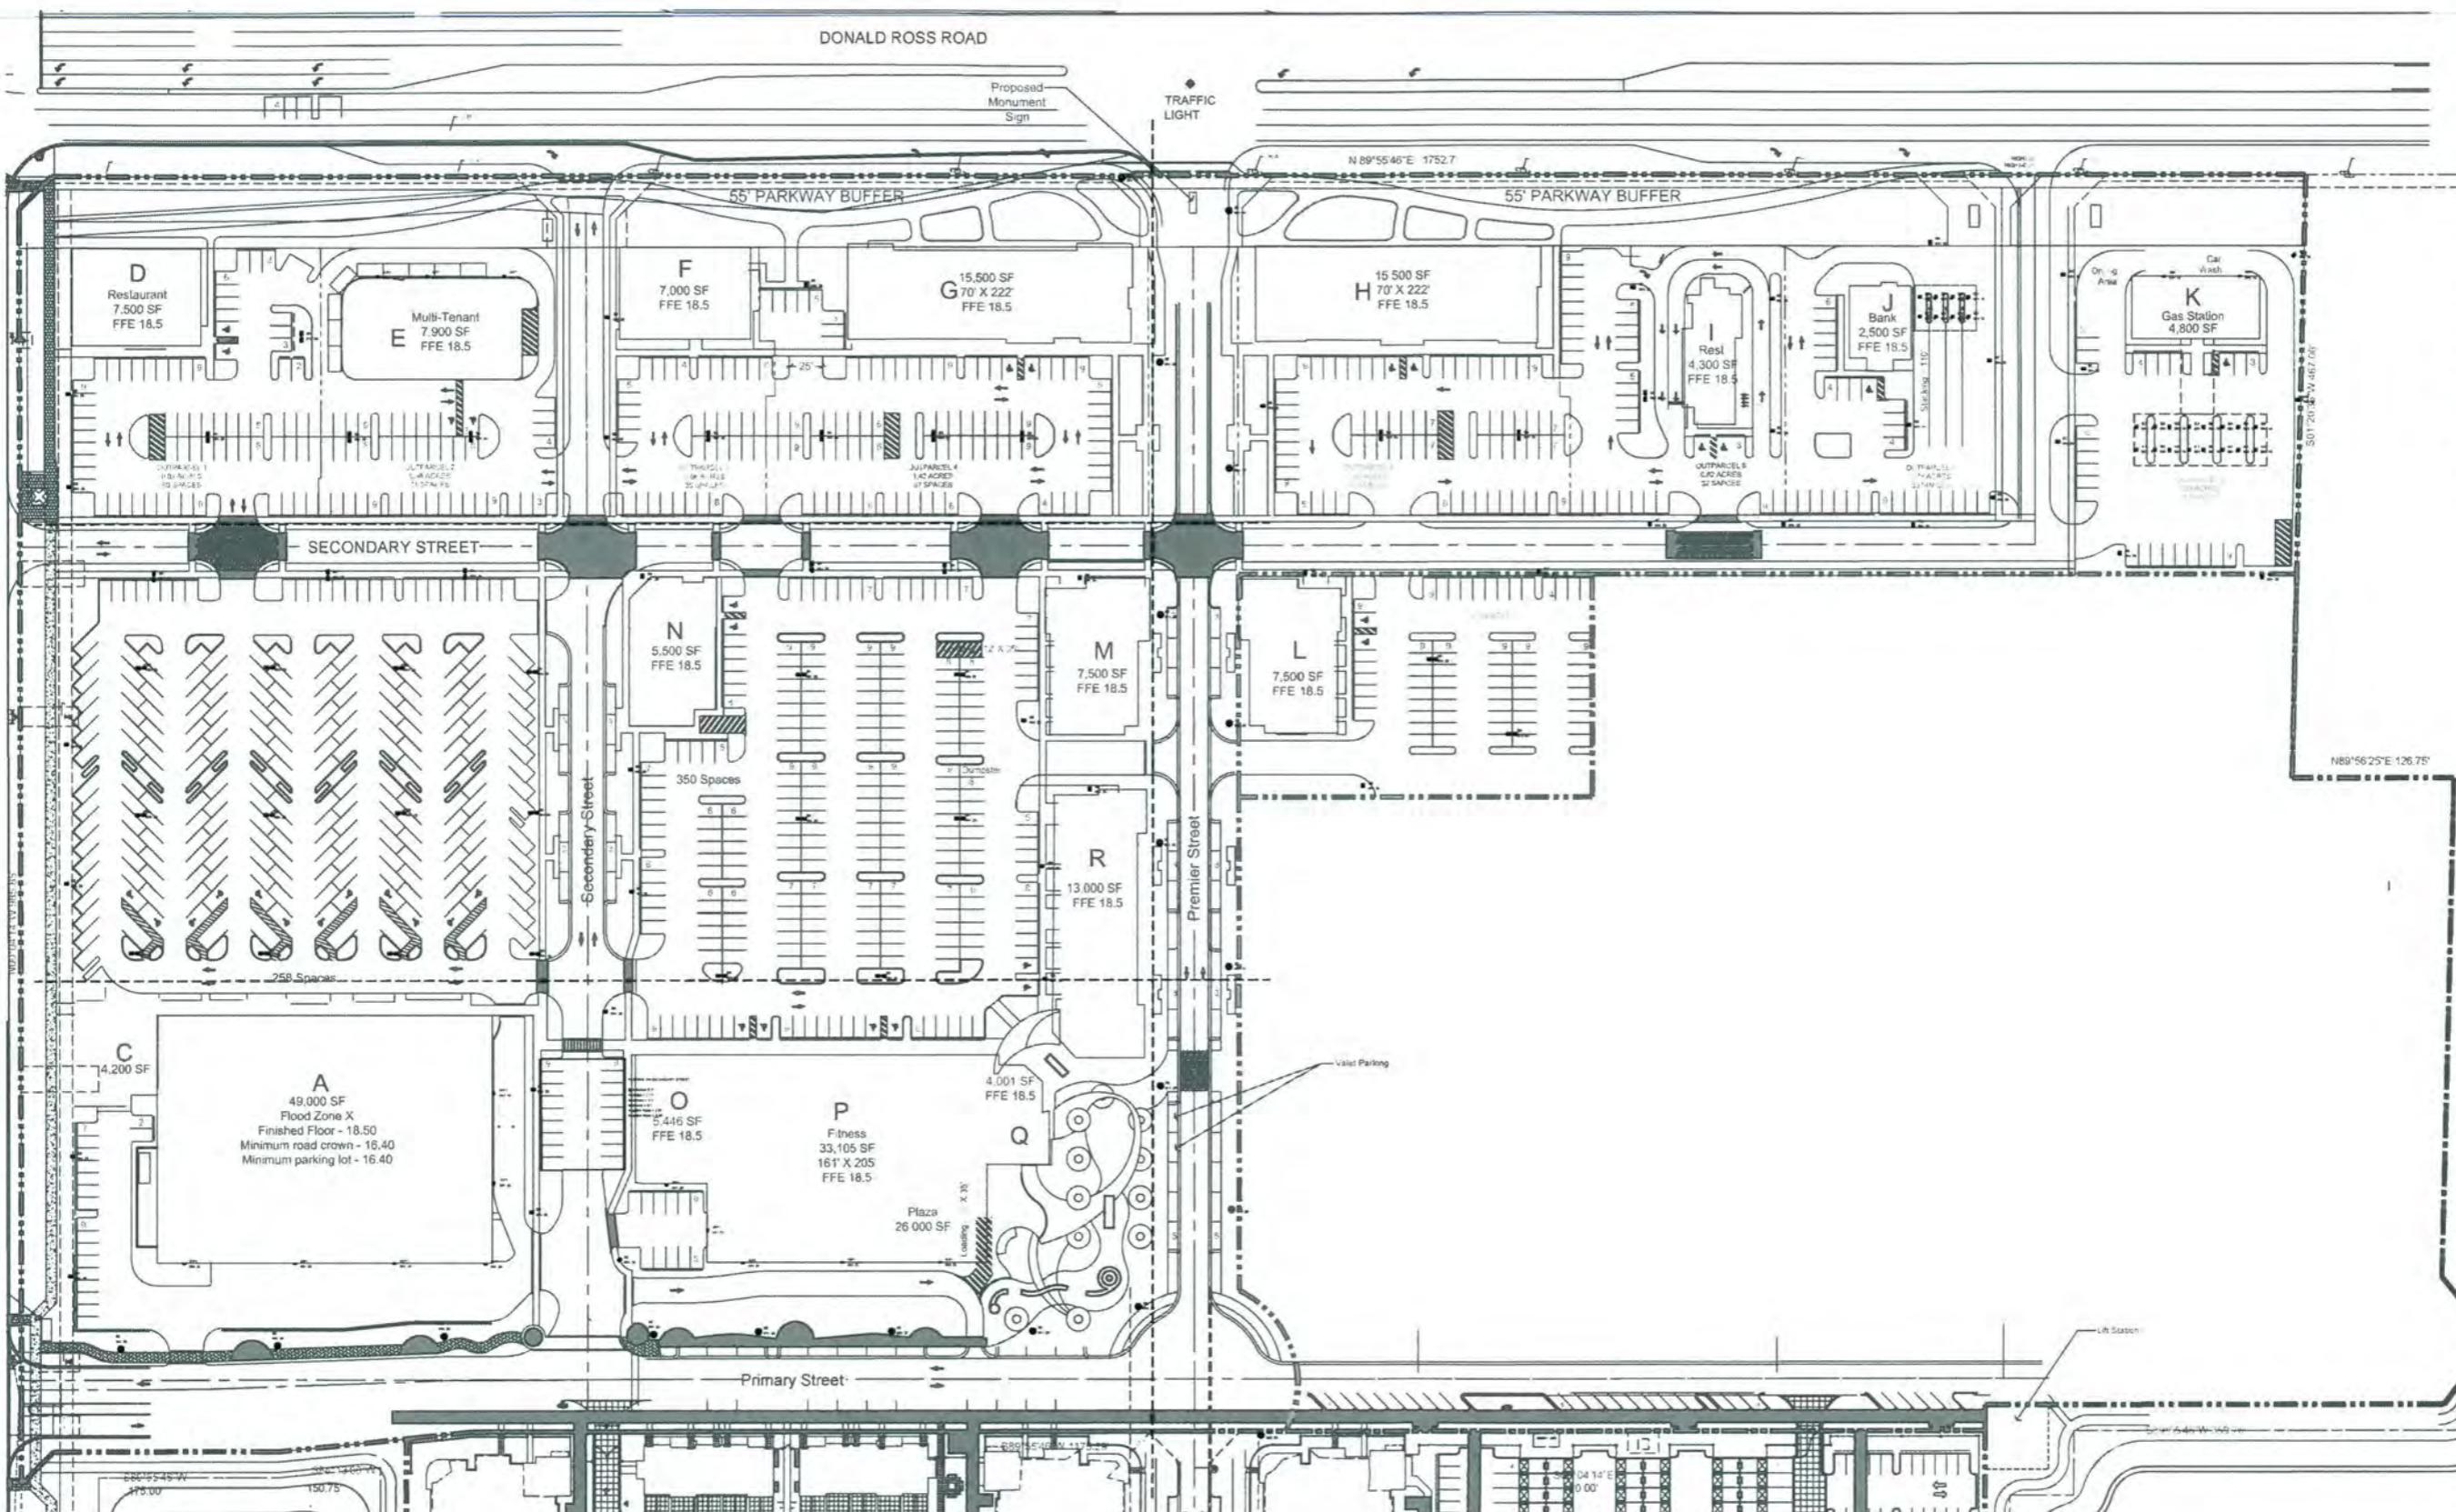
REVISIONS

PRE-BID SET	POST BID SET
DATE	ISSUE DATE

Alton Town Center
Prepared for North American Development Group
Palm Beach Gardens, FL
Phase 1 Site Plan



Date: 06-26-15
Project No.: 88-039-20
Designed By: SCM
Drawn By: SCM
Checked By: KT
Revision Dates:
06-03-15 SCM



N GENERAL VIEW

SCALE 1" = 60'-0"


E&C Job # 15-2569			
ISSUE & REVISIONS			
#	DATE	DESCRIPTION	INL APP
0	7.10.15	ORIGINAL RELEASE	ESH




Eduardo (Ed) Samour, P.E.
Registered Electrical Engineer
Cert. of Auth # 26558
2755 Vista Parkway, Suite I-3
West Palm Beach, FL 33411
Tel (561) 712-1149
email: ed@eengineers.com

Alton Town Center

Prepared for North American Development Group
Palm Beach Gardens, FL
Phase 1 Site Plan

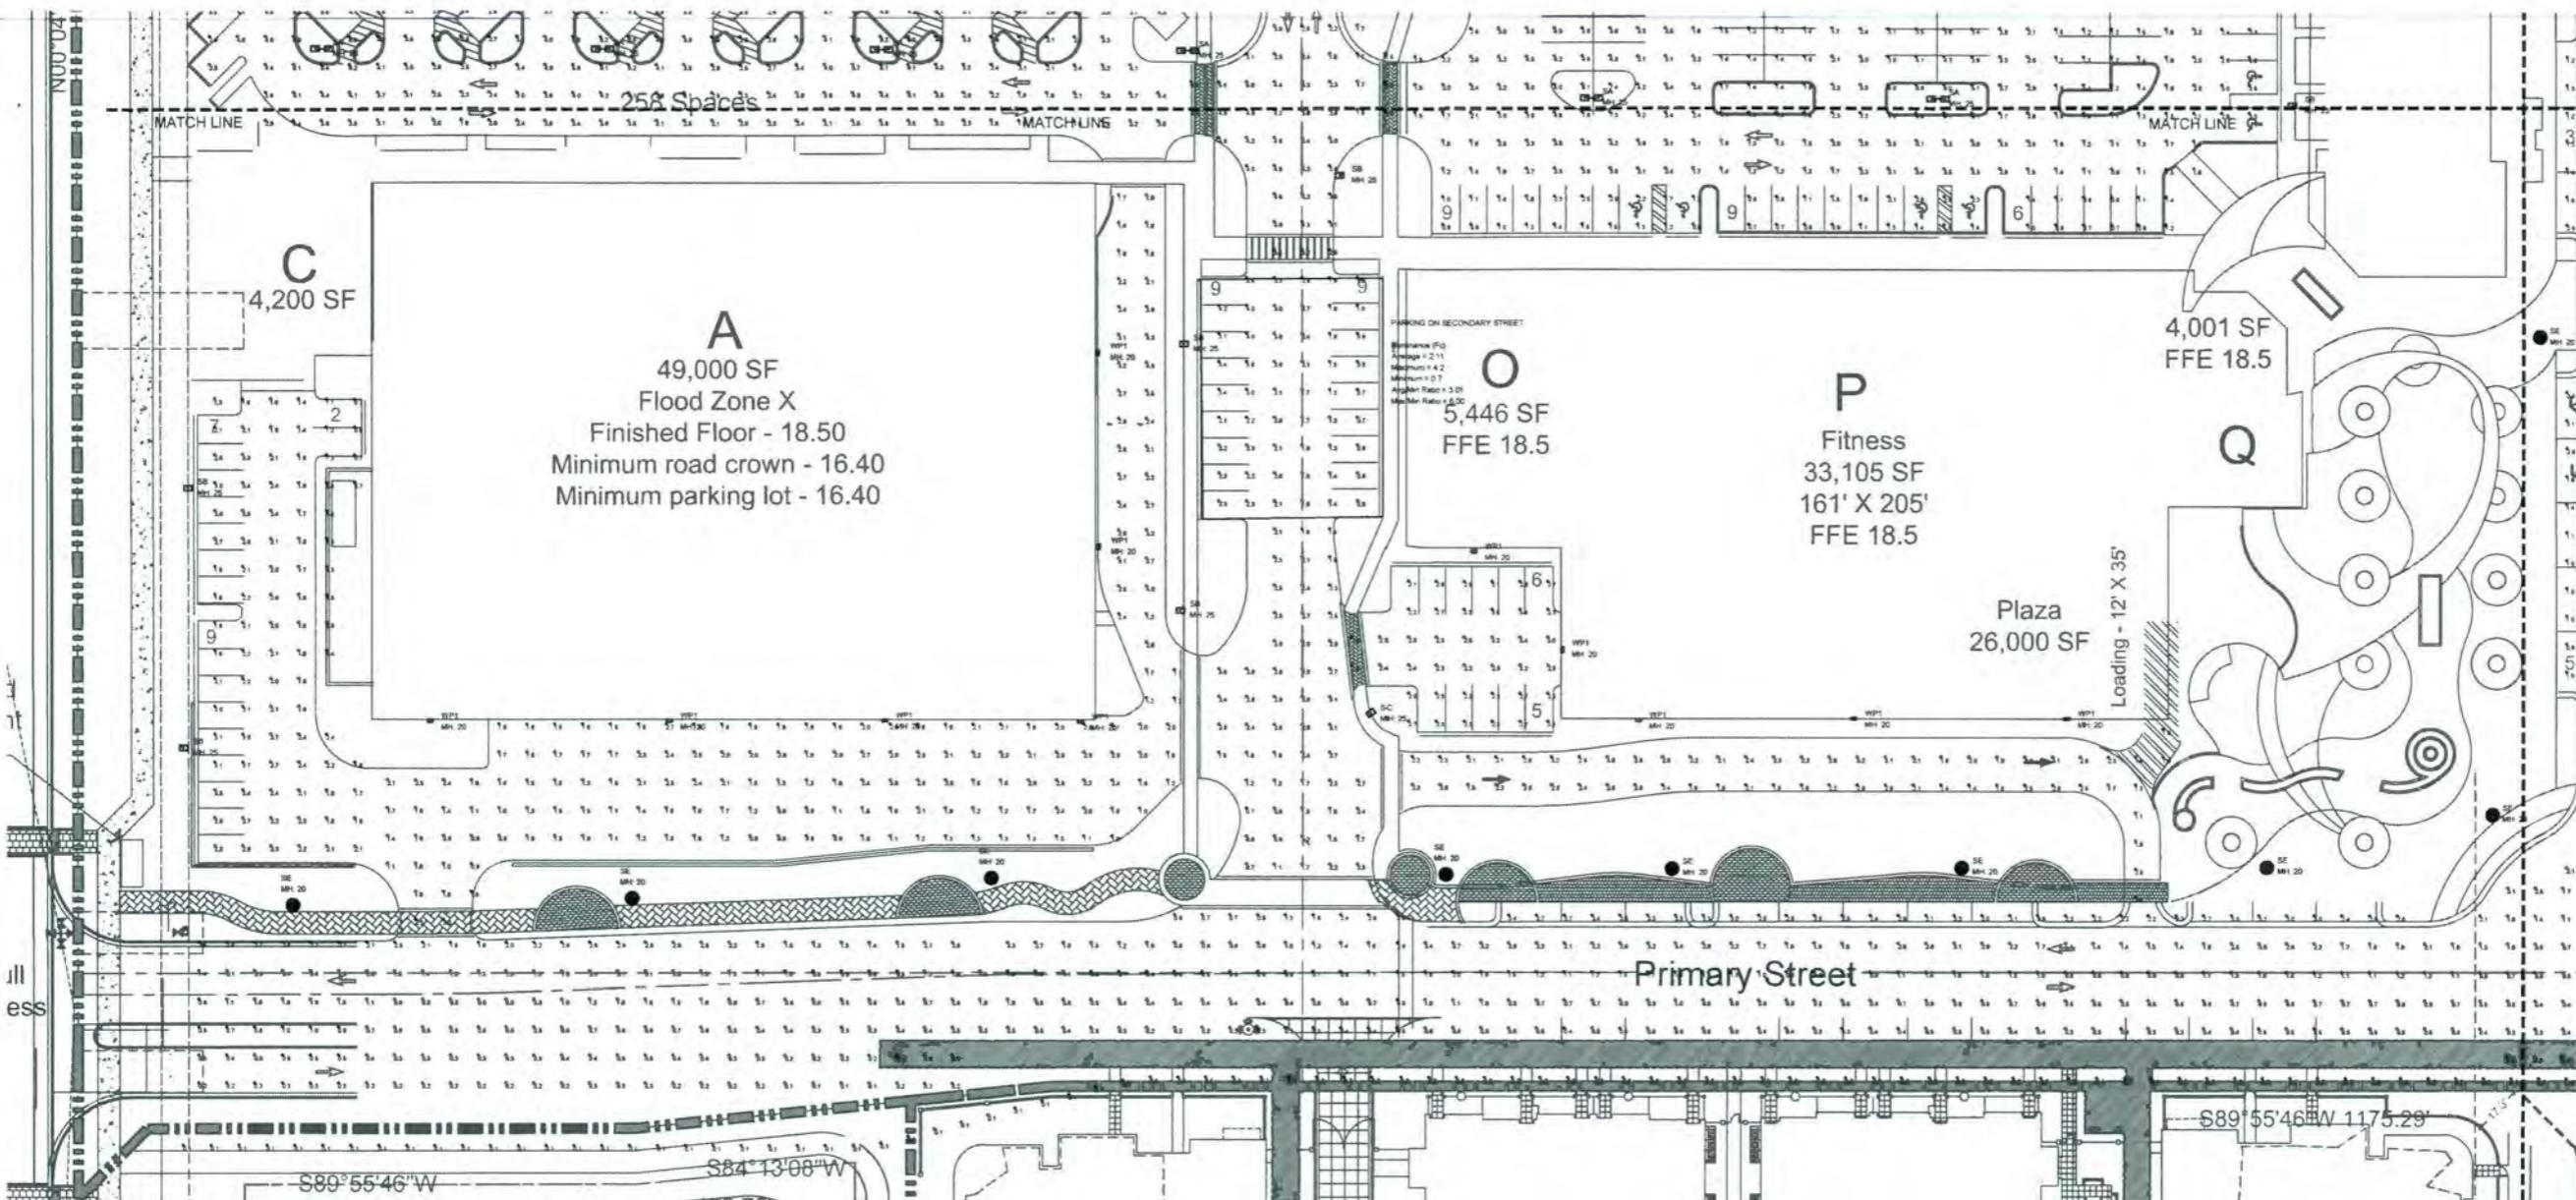

N PHOTOMETRIC PLAN (PARTIAL VIEW)
SCALE 1" = 30'-0"

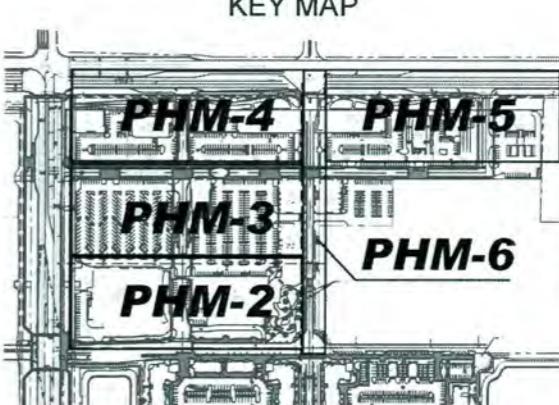


Date: 06-26-15
Project No.: 88-039-20
Designed By: SCM
Drawn By: SCM
Checked By: KT
Revision Dates:
06-03-15 SCM

E&C Job # 15-2569				
ISSUE & REVISIONS				
#	DATE	DESCRIPTION	INL	APP
D	7.10.15	ORIGINAL RELEASE	ESH	

**E&C
Engineers**
Cert. of Auth. # 26558
2751 Vista Parkway Suite I-3
West Palm Beach, FL 33441
Tel (561) 712-1149
email ed@econgineers.com

Eduardo (Ed) Samour, P.E.
Registered Electrical Engineer
P.E. # 41186


**PHM-2
of 7**

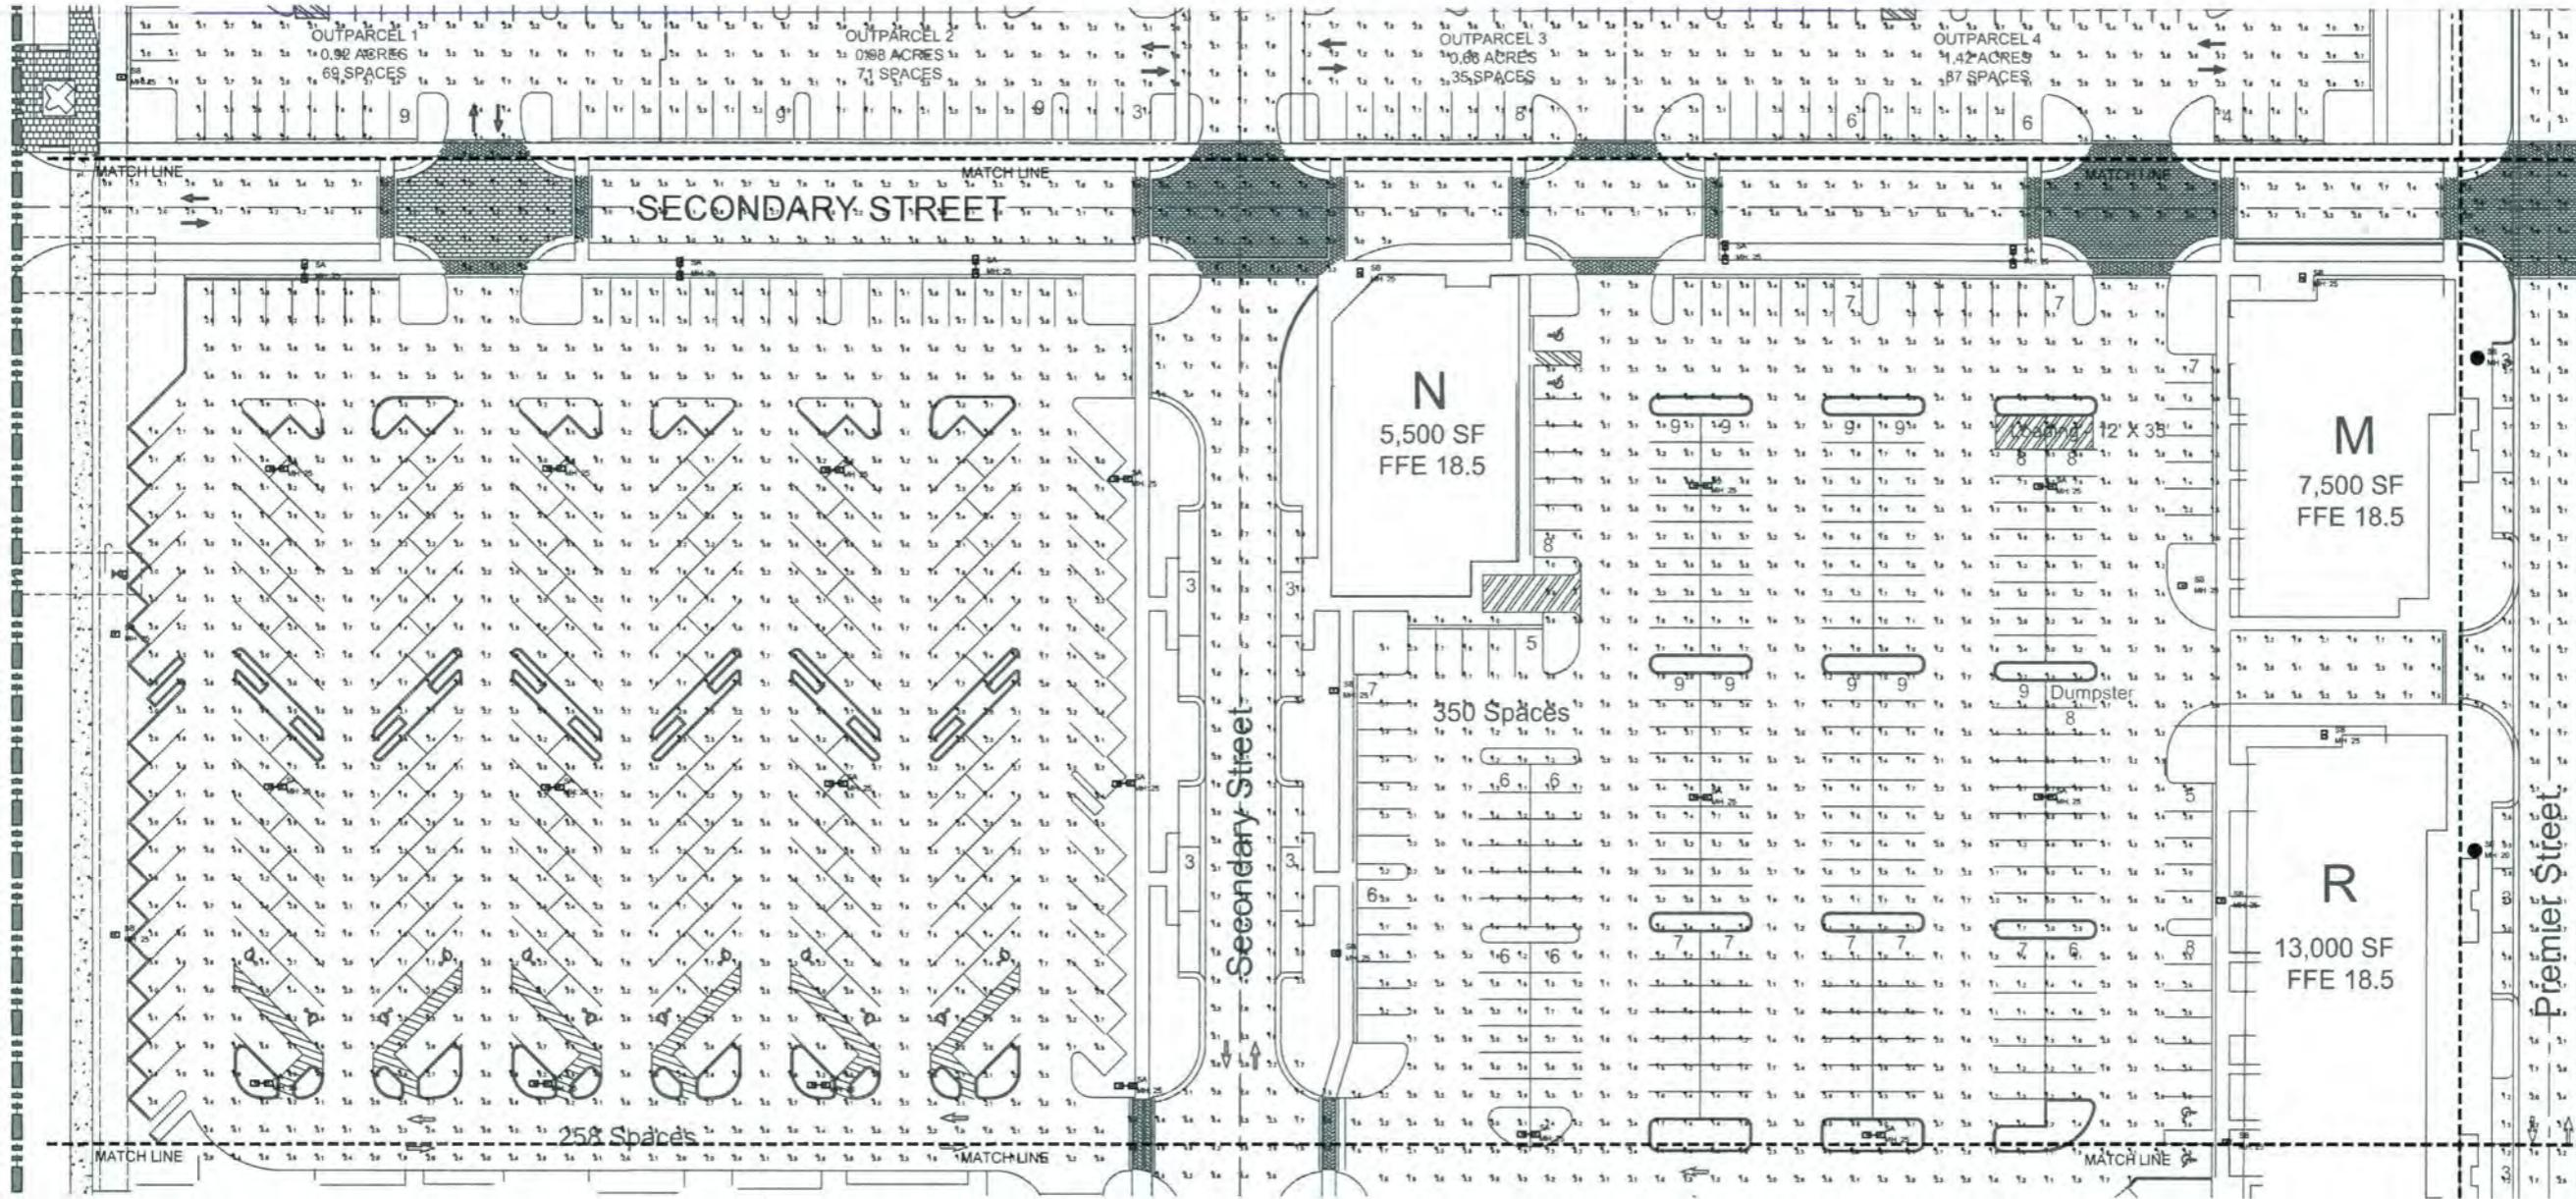

Alton Town Center
Prepared for North American Development Group

Prepared for North American Development Group

Palm Beach Gardens, FL
Phase 1 Site Plan

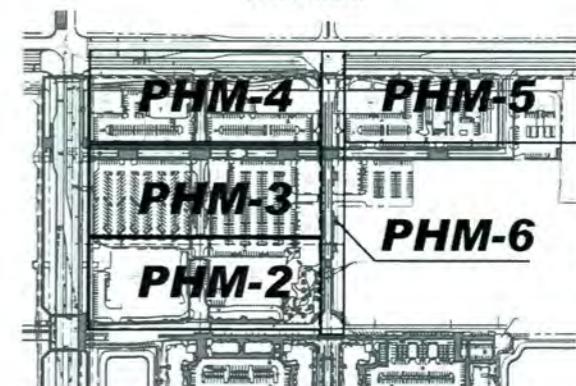

E&C Job # 15-2569				
ISSUE & REVISIONS				
#	DATE	DESCRIPTION	INL	APP
0	7.10.15	ORIGINAL RELEASE	---	ESH



Eduardo (Ed) Samour, P.E.
Registered Electrical Engineer
P.E. # 41156


PHM-3

ate: 06-26-15
roject No.: 88-039.20
esigned By: SCM
rawn By: SCM
checked By: KT

evision Dates:


Alton Town Center Prepared for North American Development Group

Palm Beach Gardens, FL
Phase 1 Site Plan

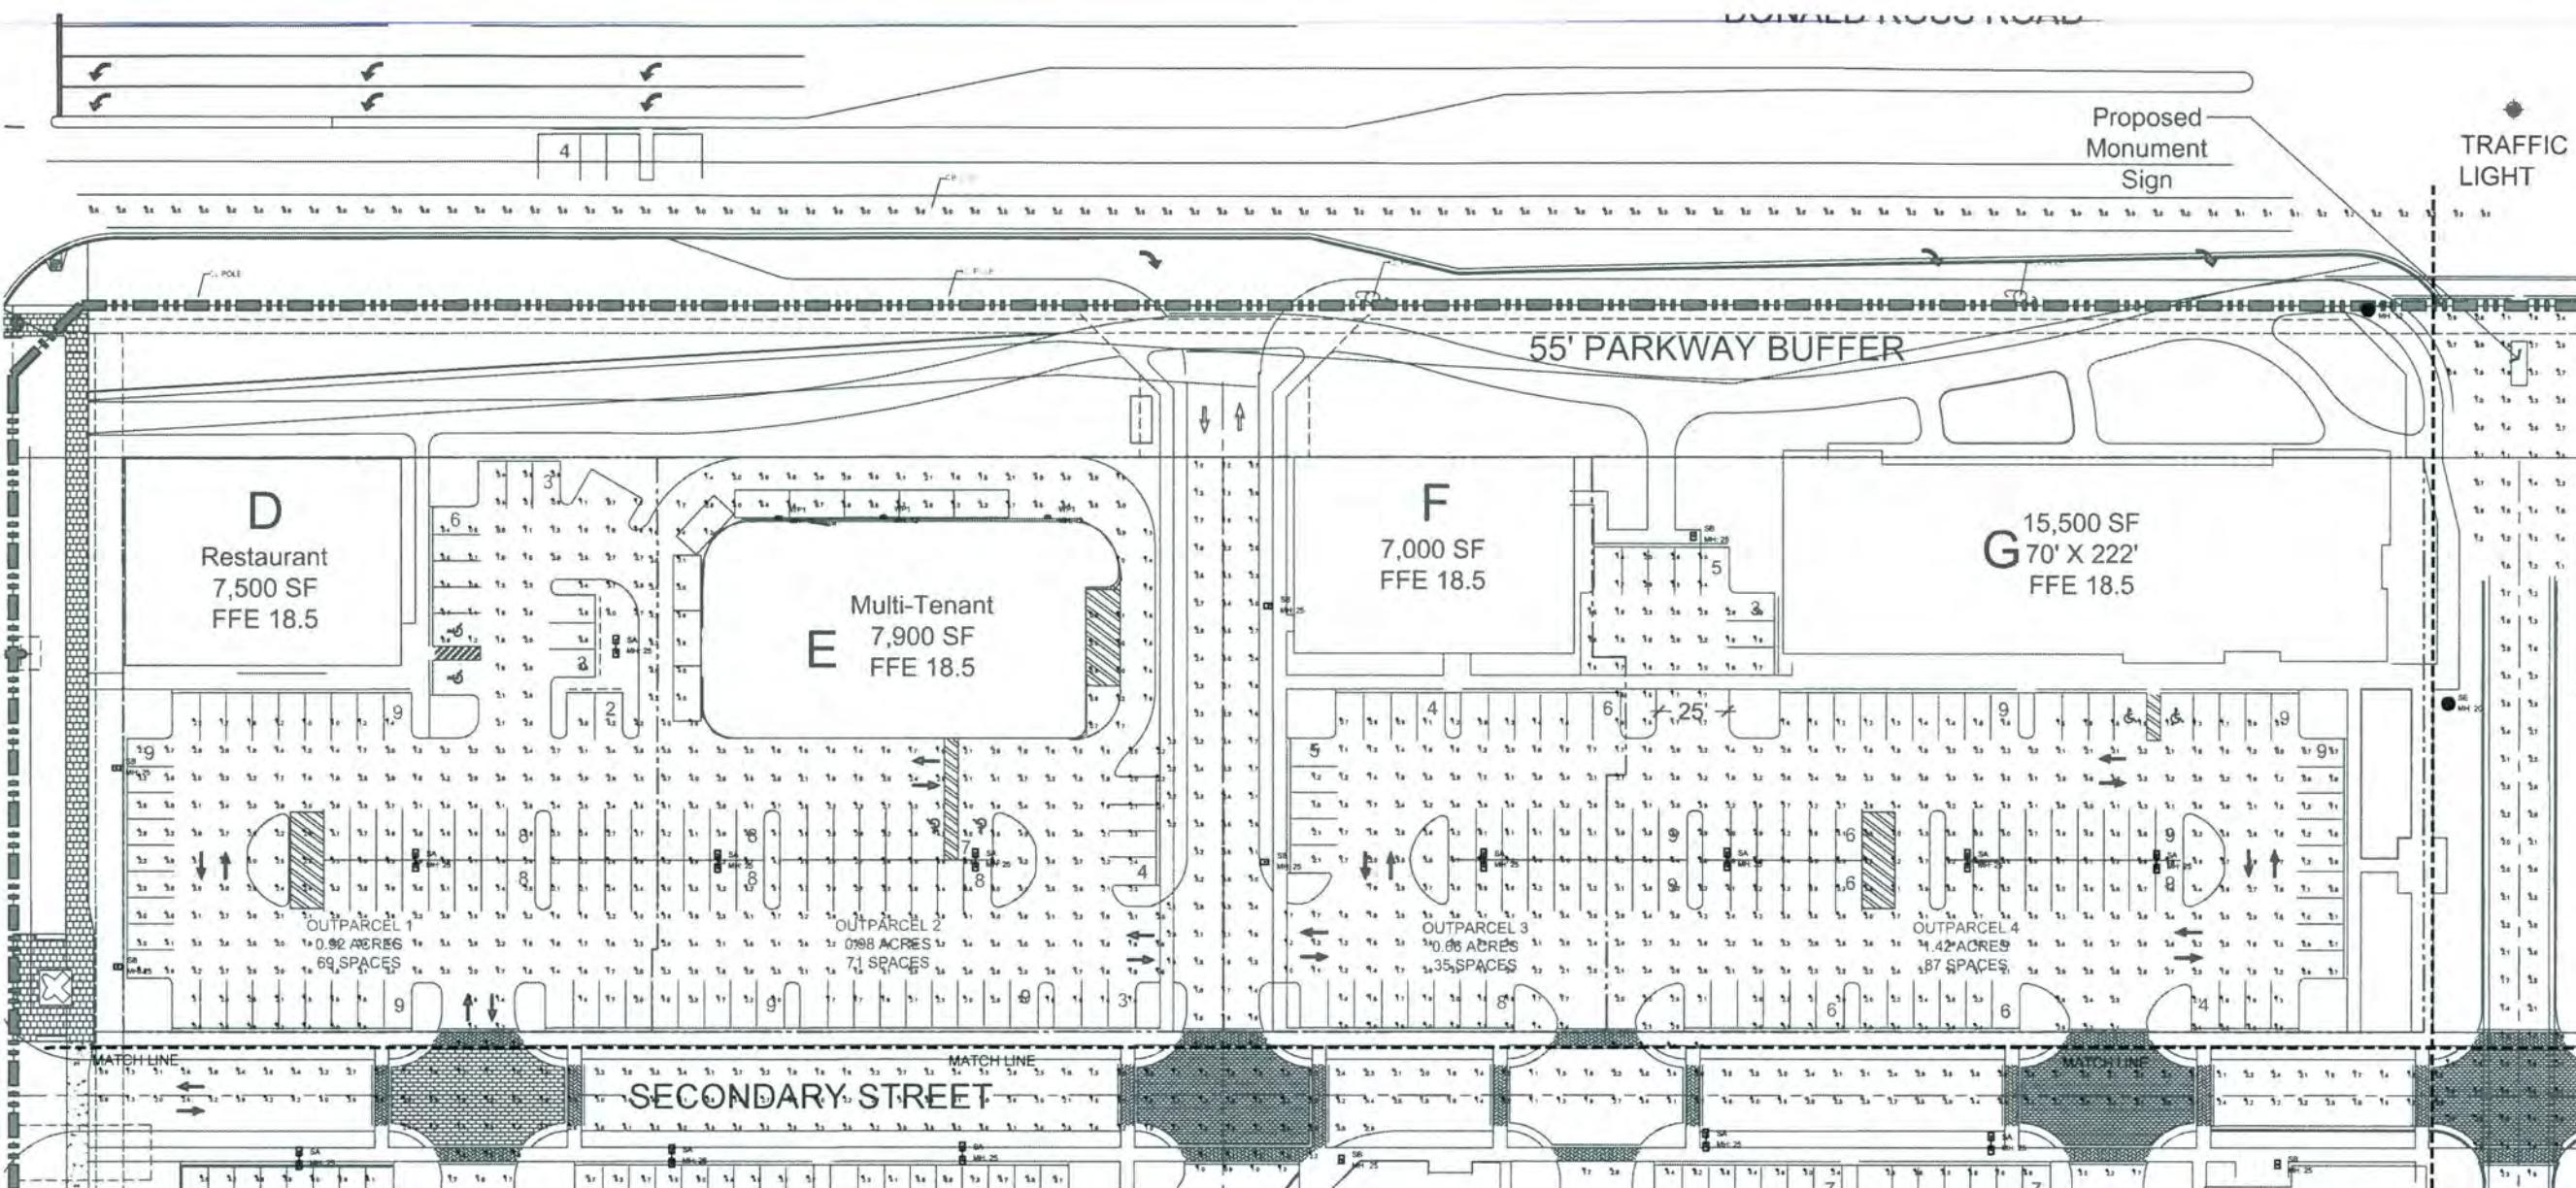

N PHOTOMETRIC PLAN (PARTIAL VIEW)
SCALE 1" = 30'-0"

KEY MAP

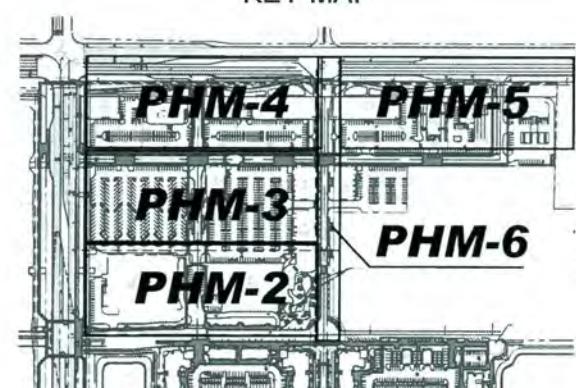

Date:	06-25-15
Project No.:	88-039.20
Designed By:	SCM
Drawn By:	SCM
Checked By:	KT
Revision Dates:	06-03-15 SCM

E&C Job # 15-2569				
ISSUE & REVISIONS				
#	DATE	DESCRIPTION	INL	APP
0	7.10.15	ORIGINAL RELEASE	----	ESH


**E&C
Engineers**
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2755 Vista Parkway, Suite I-3
West Palm Beach, FL 33411
Tel (561) 212.1149
email: ed@ecengineering.com

Eduardo (Ed) Samour, P.E.
Registered Electrical Engineer
P.E. # 41186
Date: _____

**PHM-4
of 7**


Alton Town Center
Prepared for North American Development Group

Palm Beach Gardens, FL
Phase 1 Site Plan

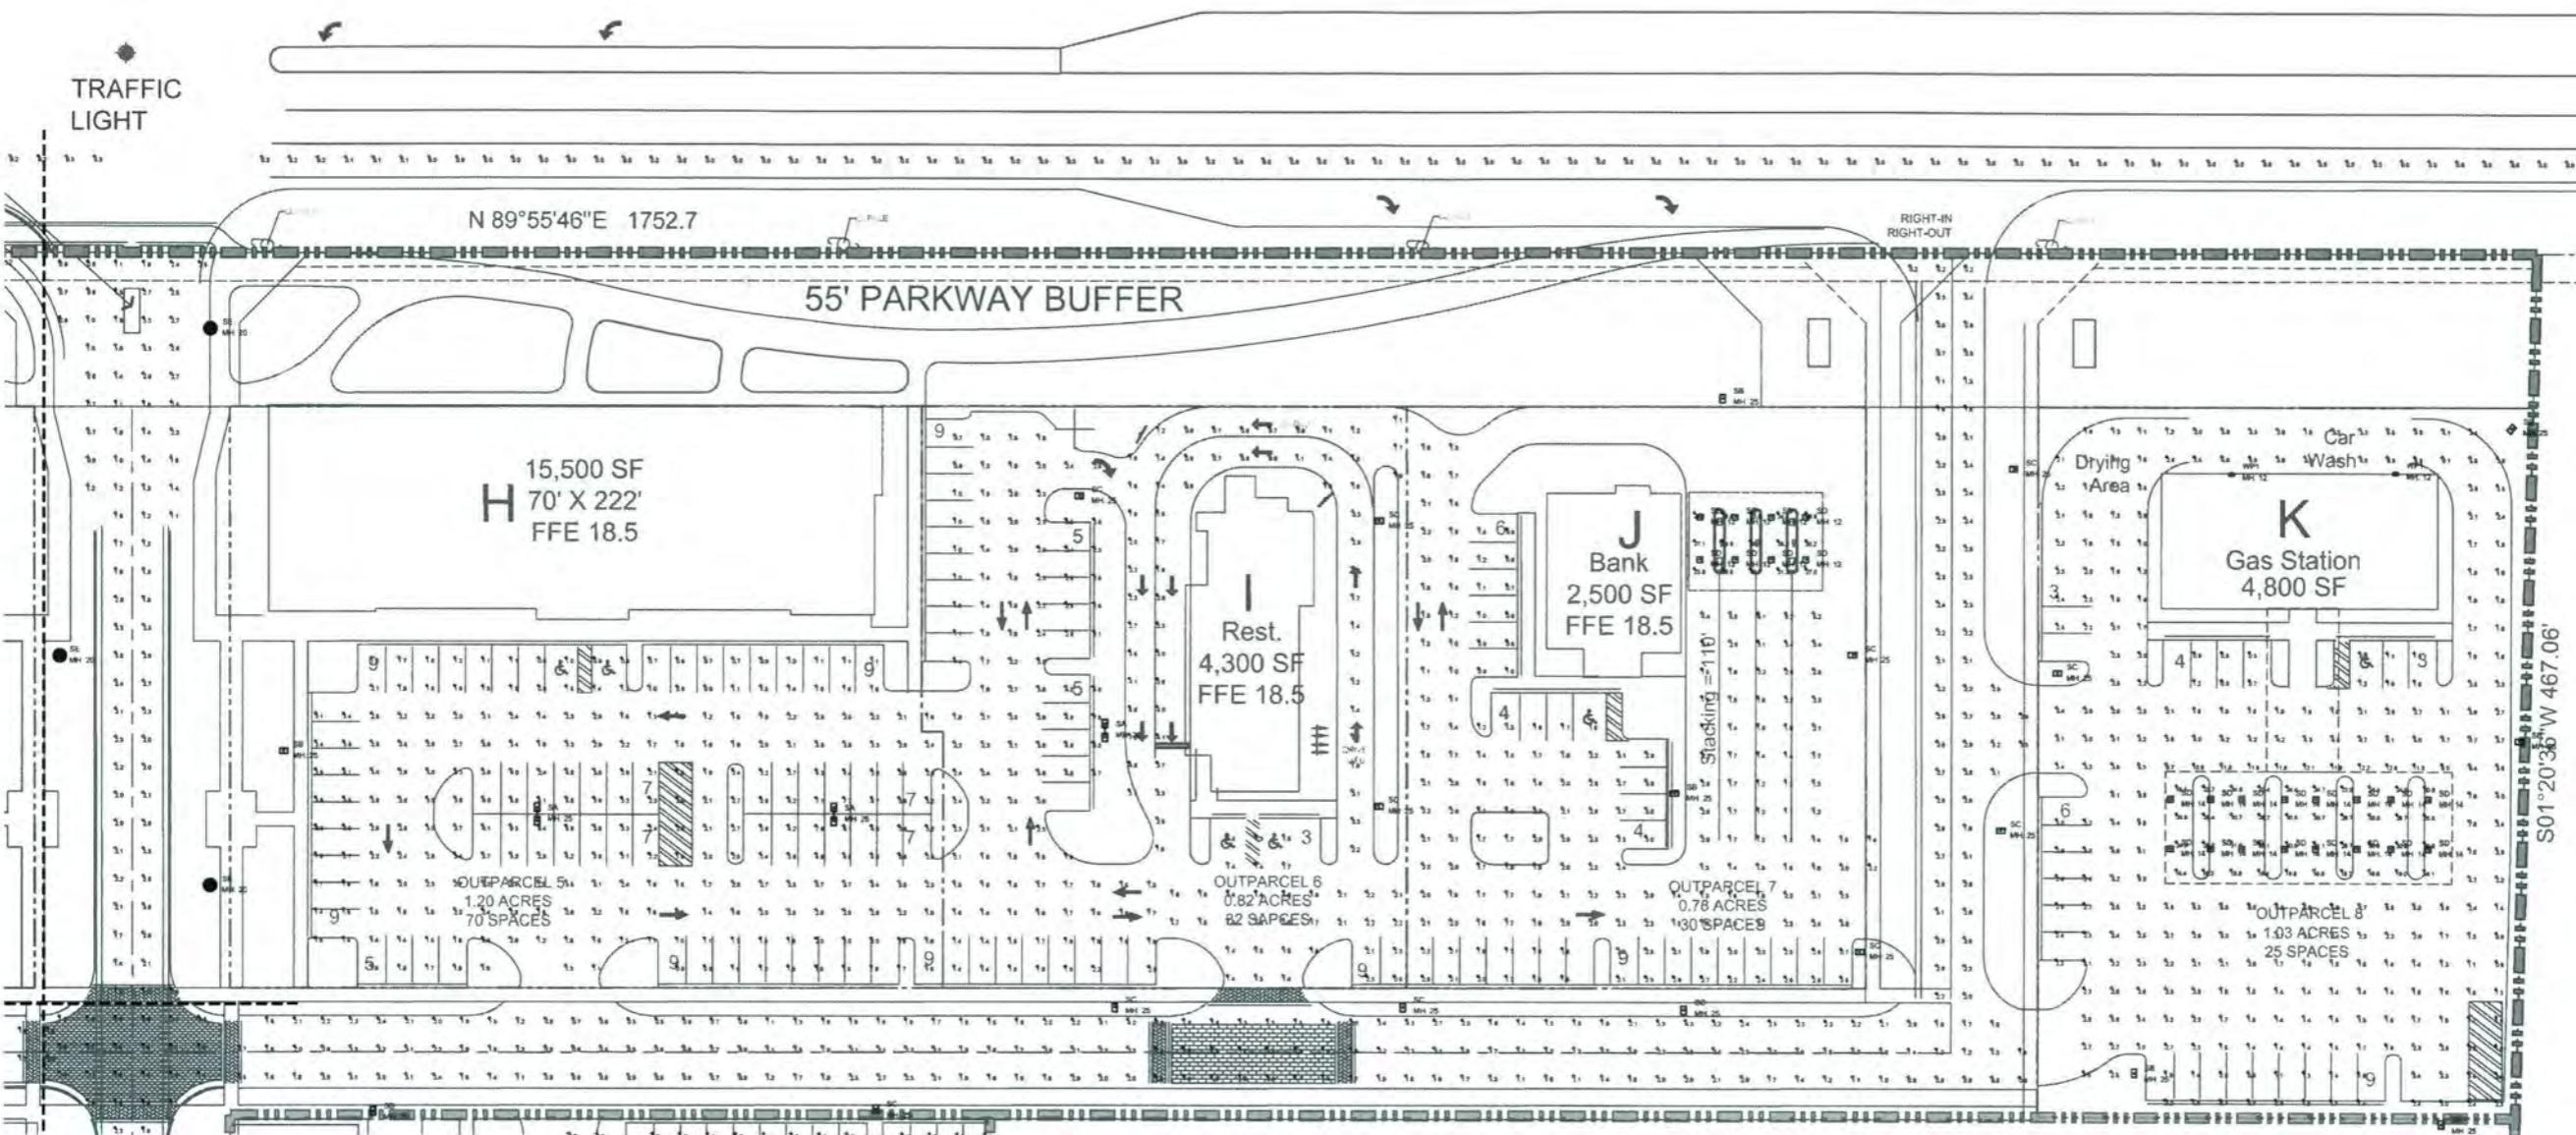

N PHOTOMETRIC PLAN (PARTIAL VIEW)
SCALE 1" = 30'-0"

KEY MAP

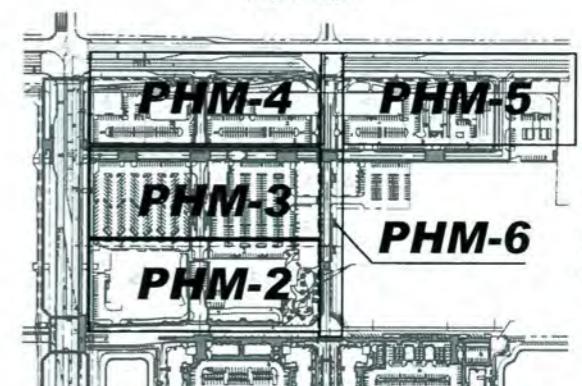

Date: 06-25-15
Project No.: 88-039-20
Designed By: SCM
Drawn By: SCM
Checked By: KT
Revision Dates:
06-03-15 SCM

E&C Job # 15-2569				
ISSUE & REVISIONS				
#	DATE	DESCRIPTION	INL	APP
0	7.10.15	ORIGINAL RELEASE	---	ESH

**E&C
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email: ed@eandcengineers.com

Eduardo (Ed) Samour, P.E.
Registered Electrical Engineer
P.E. # 41186
Date: _____

**PHM-5
of 7**



Alton Town Center Prepared for North American Development Group

Palm Beach Gardens, FL
Phase 1 Site Plan




Data: 06-26-15
Project No.: 88-039-20
Designed By: SCM
Drawn By: SCM
Checked By: KT
Revision Dates:
06-03-15 SCM

PHM-6
of 7

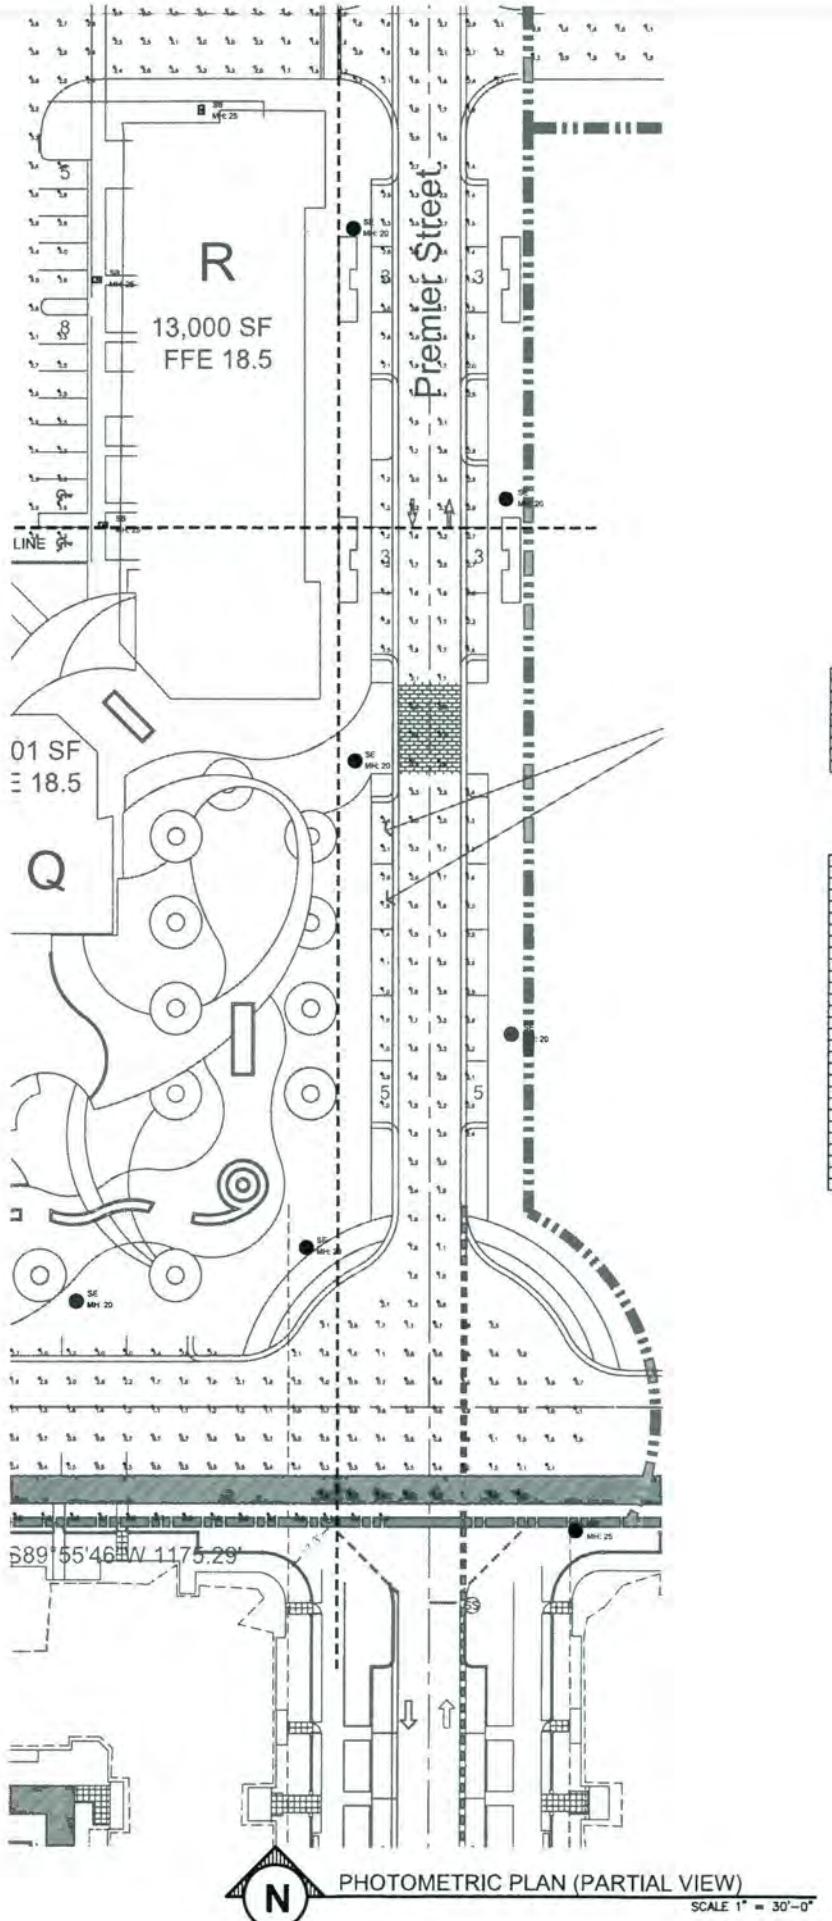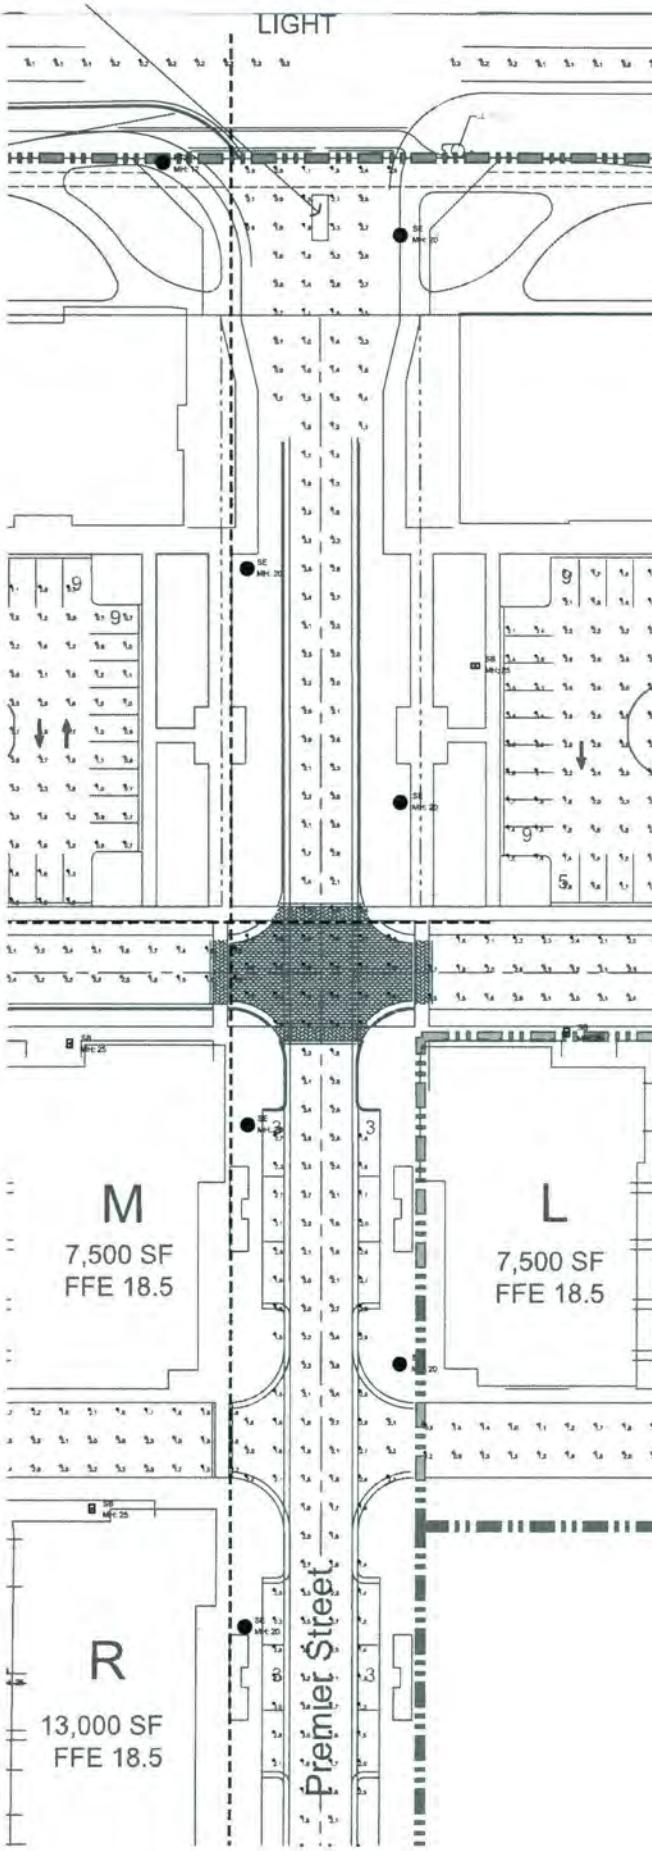

Luminaire Schedule						
Symbol	Qty	Label	Arrangement	Total Lamp Lumens	117	Description
■	1	PF	SINGLE	N.A.	1.00	ML750-CA-1364515-F-40L05 PART OF DRW PEDESTRIAN PATH
■	29	SB	SINGLE	N.A.	0.800	ML750-CA-1364515-F-40L05
■	13	SC	SINGLE	N.A.	0.900	ML750-CA-1364515-F-40L05
■	36	SA	BACK-BACK	N.A.	0.900	ML750-CA-1364515-F-40L05
■	16	WP	SINGLE	N.A.	0.900	SL750-CA-1364515-F-40L05
■	24	SD	SINGLE	N.A.	1.000	ABSD1057xxxxxx-12047TV
■	19	SE	TWIN	N.A.	1.000	CUTOFF FIXTURE TO BE SELECTED BY OWNER

Calculation Summary						
Label	CalcType	Unit	Avg	Max	Min	Avg/Win
ACCESES BETWEEN PARCEL M AND R	Brightness	FC	2.17	2.17	1.26	2.33
BANK DRIVE THROUGH	Brightness	FC	30.80	30.80	30.80	30.80
DONALD HOSS RD	Brightness	FC	0.02	0.3	0.0	N.A.
DRIVE THROUGH BLDG E	Brightness	FC	2.06	6.5	0.5	13.00
EAST SECONDARY ROAD	Brightness	FC	1.83	4.3	0.2	9.15
EXCERPT FROM SECONDARY STREET	Brightness	FC	2.06	6.3	0.1	9.15
FIRETRUCK PARKING	Brightness	FC	2.07	3.1	0.7	13.86
FITNESS REAR PARKING	Brightness	FC	2.83	3.5	2.0	1.75
FITNESS REAR PARKING_1	Brightness	FC	2.28	3.2	1.1	2.07
GAS STATION CANOPY	Brightness	FC	24.78	31.1	15.4	1.81
INDUSTRIAL PROPERTY	Brightness	FC	2.16	7.2	0.3	12.00
TRANSIT PARCEL E AND D	Brightness	FC	2.17	3.1	0.4	13.00
PARKING PARCEL 7 AND 5	Brightness	FC	2.80	8.1	0.7	13.00
PARKING PARCEL H	Brightness	FC	2.41	8.4	0.8	14.00
PARKING PARCEL J AND 2	Brightness	FC	1.93	6.2	0.5	3.86
PARKING PARCEL K	Brightness	FC	2.96	11.8	0.3	9.87
PARKING PARCEL L	Brightness	FC	2.22	3.2	0.3	12.00
PARKING PARCEL M	Brightness	FC	2.07	3.8	0.3	12.63
PARKING PARCEL N	Brightness	FC	1.77	3.7	0.1	11.75
PRIMARY STREET	Brightness	FC	2.53	4.5	1.2	2.11
PUBLIC EAST ALLEYWAY	Brightness	FC	3.22	8.5	1.4	2.30
PUBLIC PARKING	Brightness	FC	2.77	7.2	1.2	1.75
TRANSIT LOADING AREA	Brightness	FC	2.06	3.7	0.6	13.00
PUBLIC REAR PARKING	Brightness	FC	2.06	3.7	0.6	13.48
RECREATIONAL PROPERTY LINE	Brightness	FC	0.11	0.5	0.0	N.A.
SECONDARY STREET	Brightness	FC	2.16	8.8	0.8	11.33
SECONDARY STREET_1	Brightness	FC	2.19	3.5	0.7	3.13
PARKING ON SECONDARY STREET	Brightness	FC	2.11	4.2	0.7	8.80






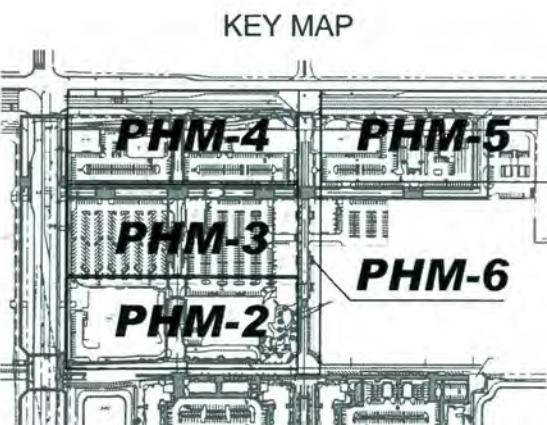


E&C Job # 15-2569				
ISSUE & REVISIONS				
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0	7.10.15	ORIGINAL RELEASE	-----	ESH

E&C
Engineers

Cert. of Auth. # 26558
2755 Vista Parkway Suite 1-3
West Palm Beach, FL 33412
Tel (561) 712 1149
email: ed@eengineers.com

Eduardo (Ed) Samour, P.E.
Registered Electrical Engineer
P.E. # 41186

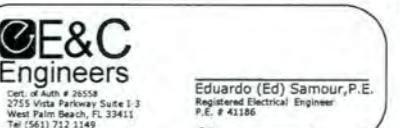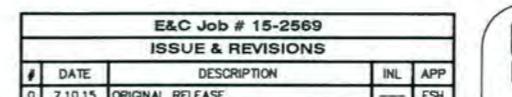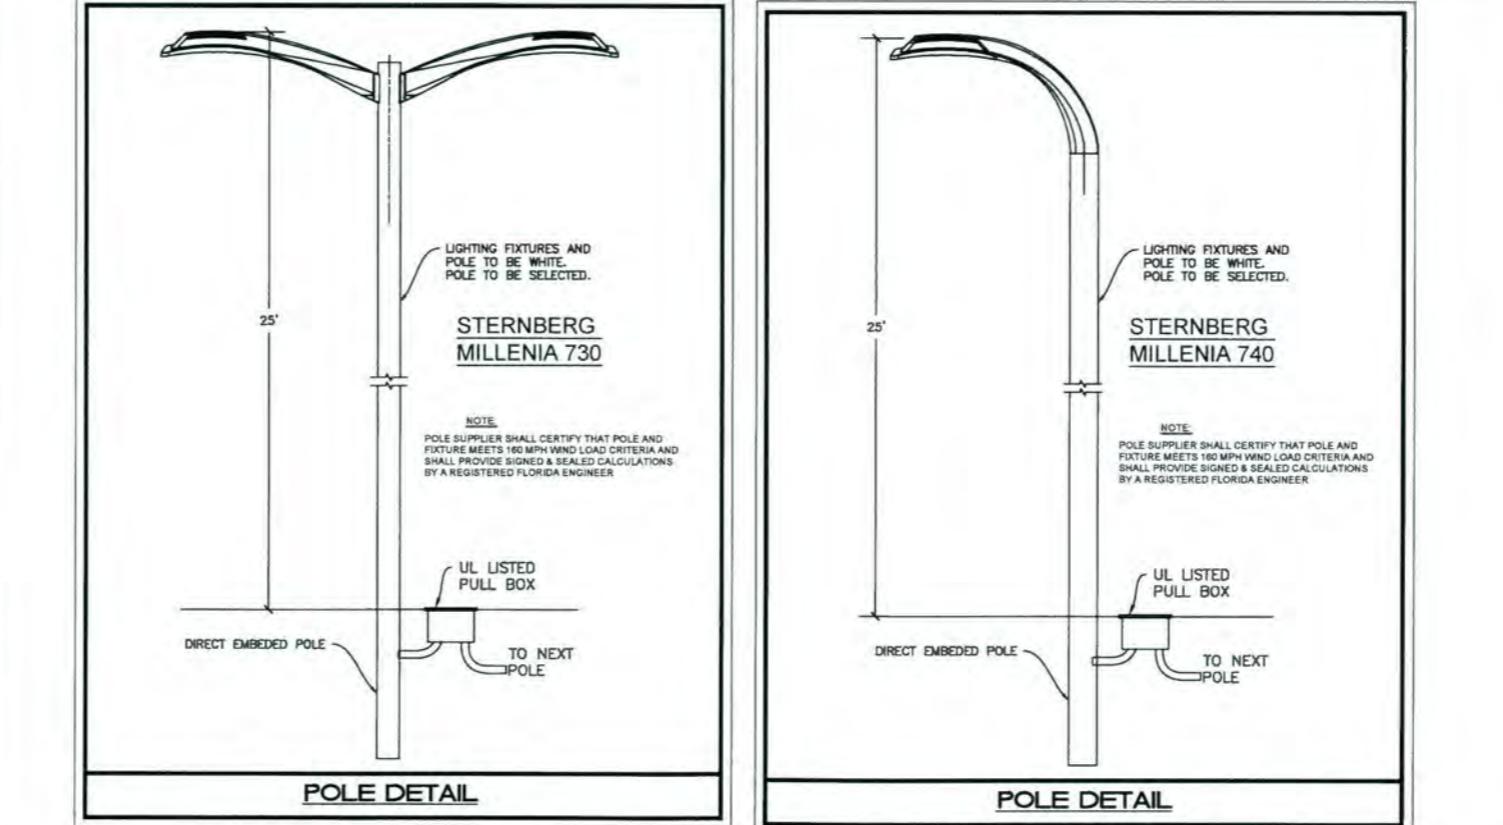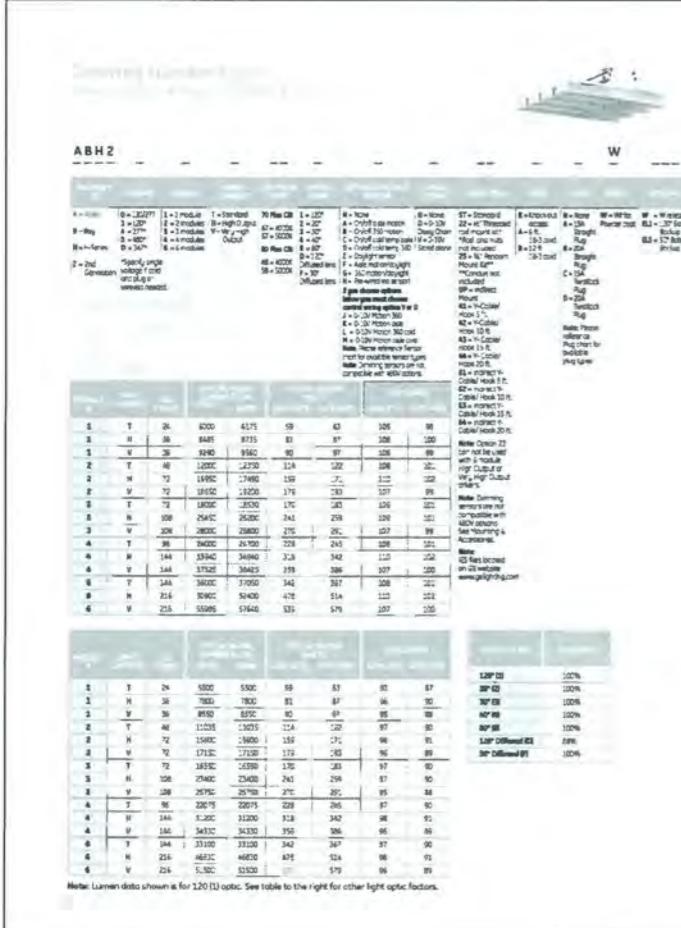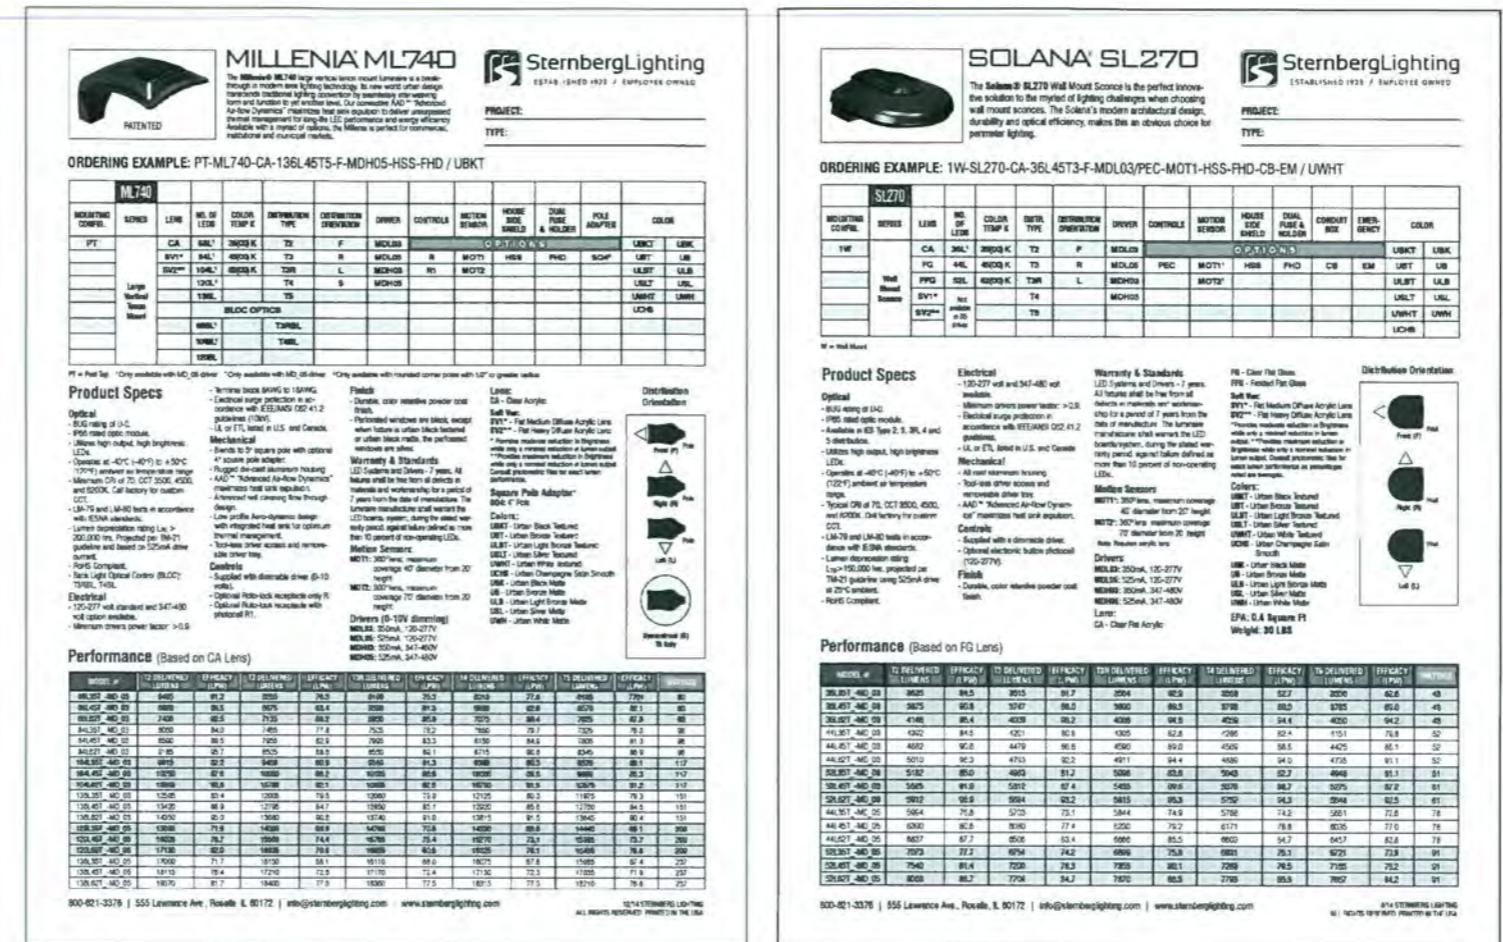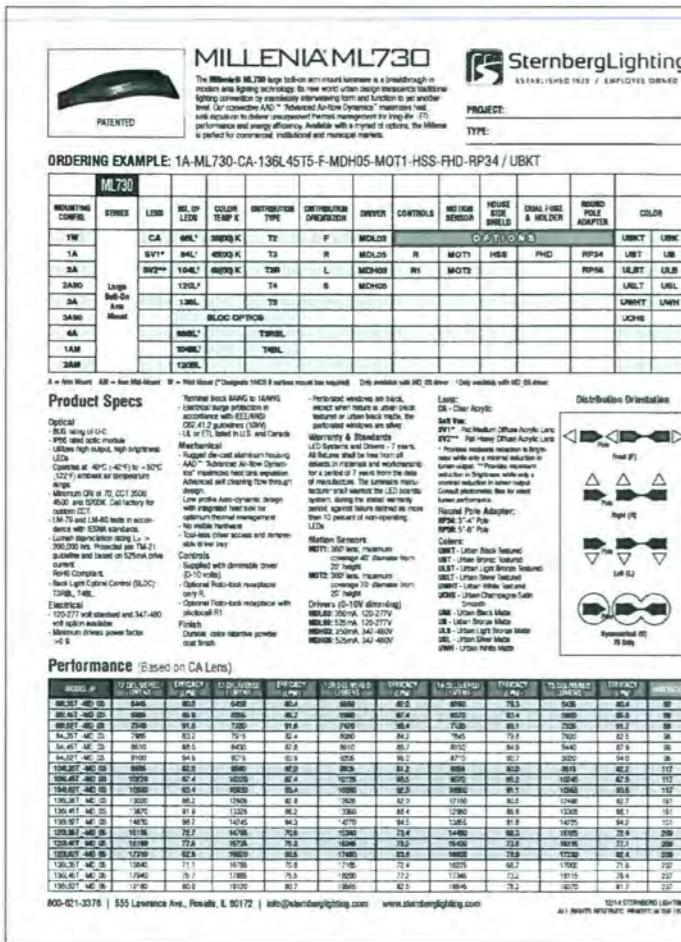

Alton Town Center
Prepared for North American Deve

Palm Beach Gardens, FL
Phase 1 Site Plan



06-26-15
ct No.: 88-039-20
ned By: SCM
By: SCM
ted By: KT

ission Dates:

5 SCM

SCM

— 1 —

[View Details](#)

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Page 1

BUJAR

PHM-7

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of 7

17

Digitized by srujanika@gmail.com

PHM-7
of 7

PHM-7
of 7



PROJECT LOCATION

ALTON TOWN CENTER PRELIMINARY ENGINEERING PLANS FOR NORTH AMERICAN DEVELOPMENT GROUP



PROJECT LOCATION


VICINITY MAP
NOT TO SCALE



SECTION: 26 TOWNSHIP: 41S RANGE: 42E
CITY OF PALM BEACH GARDENS, FLORIDA

SEPT. 2016

THE PRESENCE OF GROUNDWATER SHOULD BE
ANTICIPATED ON THIS PROJECT. CONTRACTOR'S
BID SHALL INCLUDE CONSIDERATION FOR
ADDRESSING THIS ISSUE.

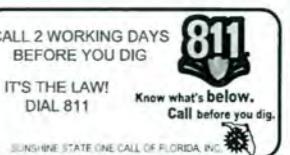

ALL ELEVATIONS SHOWN ON PLANS ARE NORTH
AMERICAN VERTICAL DATUM (N.A.V.D.) '88.
N.A.V.D. '88 + 1.52' = N.G.V.D. '28

SHEET NUMBER
C0.00

No	REVISIONS	DATE	BY
----	-----------	------	----

Kimley»Horn



COVER SHEET
ALTON TOWN CENTER
PREPARED FOR
NORTH AMERICAN
DEVELOPMENT GROUP
PALM BEACH GARDENS
FL

2016 KIMLEY-HORN AND ASSOCIATES, INC. 1580 S. DIAZ MESS AVE., SUITE 100, DELRAY BEACH, FL 33445 PHONE: 561-230-2345 FAX: 561-863-8175 WWW.KIMLEY-HORN.COM CA 00000886	No	REVISIONS	DATE	BY
--	----	-----------	------	----

Planned and designed by Backward Bonds, Inc., Street, St. Alton, IL, and approved by the City of St. Alton, IL, on September 16, 2016, at 02:30 p.m. A record of survey and map of record showing the location of the subject property and the location of the proposed improvements.

—RIGHT-OF-WAY LINE

DONALD ROSS ROAD
(BY OTHERS)

T E.O.P.

This architectural drawing shows a building footprint labeled 'G'. The footprint is a rectangular shape with a small extension on the left side. The drawing includes dimensions and labels such as '15,259 FFE 18'.

15,259 \$
FFE 18.5

13,00 SF
FFE 18.5


5,600 SF
FFE 18' 5"

PREMIER STREET

SECONDARY STREET

M
7,575 SF
FFE 18.5

7,575
FFE

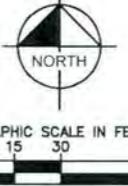

GRAPHIC SCALE IN FEET
0 15 30 60

PAVING, GRADING, AND DRAINAGE NOTES:

1. DRAINAGE STRUCTURES SHALL BE CONSTRUCTED USING U.S. PRECAST (USP), U.S. FOUNDRY (USF), OR FLORIDA DEPARTMENT OF TRANSPORTATION STANDARD (FDOT) PRODUCTS AS SPECIFIED, OR APPROVED EQUAL.
 2. ALL STORM STRUCTURES SHALL HAVE A MINIMUM 18" SUMP.
 3. ALL STORM PIPE SHALL BE REINFORCED CONCRETE PIPE (RCP) OR HIGH DENSITY POLY-ETHYLENE (HDPE) PIPE.
 4. ALL PIPE LENGTHS ARE MEASURED FROM CENTER OF STRUCTURES UNLESS OTHERWISE NOTED.
 5. THE CROSS SLOPE ON ADA ACCESSIBLE ROUTES SHALL NOT EXCEED 2.0%. THE LONGITUDINAL SLOPE ON ADA ACCESSIBLE ROUTES (NOT INCLUDING RAMPS) SHALL NOT EXCEED 5.0%. THE LONGITUDINAL SLOPE FOR RAMPS SHALL NOT EXCEED 12:1 (8.3%).
 6. PROPOSED ELEVATIONS IN ALL PERVIOUS AREAS REPRESENT FINISHED TOP OF SOIL/GRASS OR ANY OTHER LANDSCAPING MATERIAL.
 7. ALL ROOF LEADERS SHALL BE PVC SDR-35 AND SHALL HAVE A MINIMUM OF 1% SLOPE, UNLESS OTHERWISE NOTED.
 8. CONTRACTOR SHALL PROVIDE ALL FITTINGS, COUPLINGS, OR ADAPTERS NECESSARY TO CONNECT TO THE BUILDING PLUMBING AND TO CONNECT ROOF LEADERS TO THE MAIN STORM LINES.
 9. CONTRACTOR SHALL SUPPORT AND PROTECT ALL EXISTING AND PROPOSED UTILITIES WHEN CONSTRUCTING NEW DRAINAGE STRUCTURES AND PIPES.

LEGEND

PROPERTY LINE AND/OR RIGHT-OF-WAY LINE

PROPOSED BUILDING OUTLINE

PROP. ASPHALT PAVEMENT AND DRIVE CONSTRUCTION


PROP. SIDEWALK

EXIST. GRADE ELEVATION (NAVD)

PROP. GRADE ELEVATION (NAVD)

PROP. FLOW/SLOPE ARROW


STRUCTURE NUMBER S-1

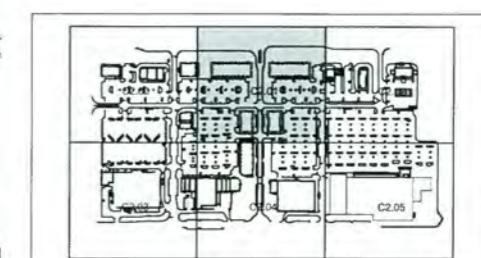

SHEET MAP

PAVING GRADING
AND DRAINAGE
PLAN

FL
ALTON TOWN CENTER
PREPARED FOR
NORTH AMERICAN
DEVELOPMENT GROUP
PALM BEACH
GARDENS
SHEET NUMBER
C2.01

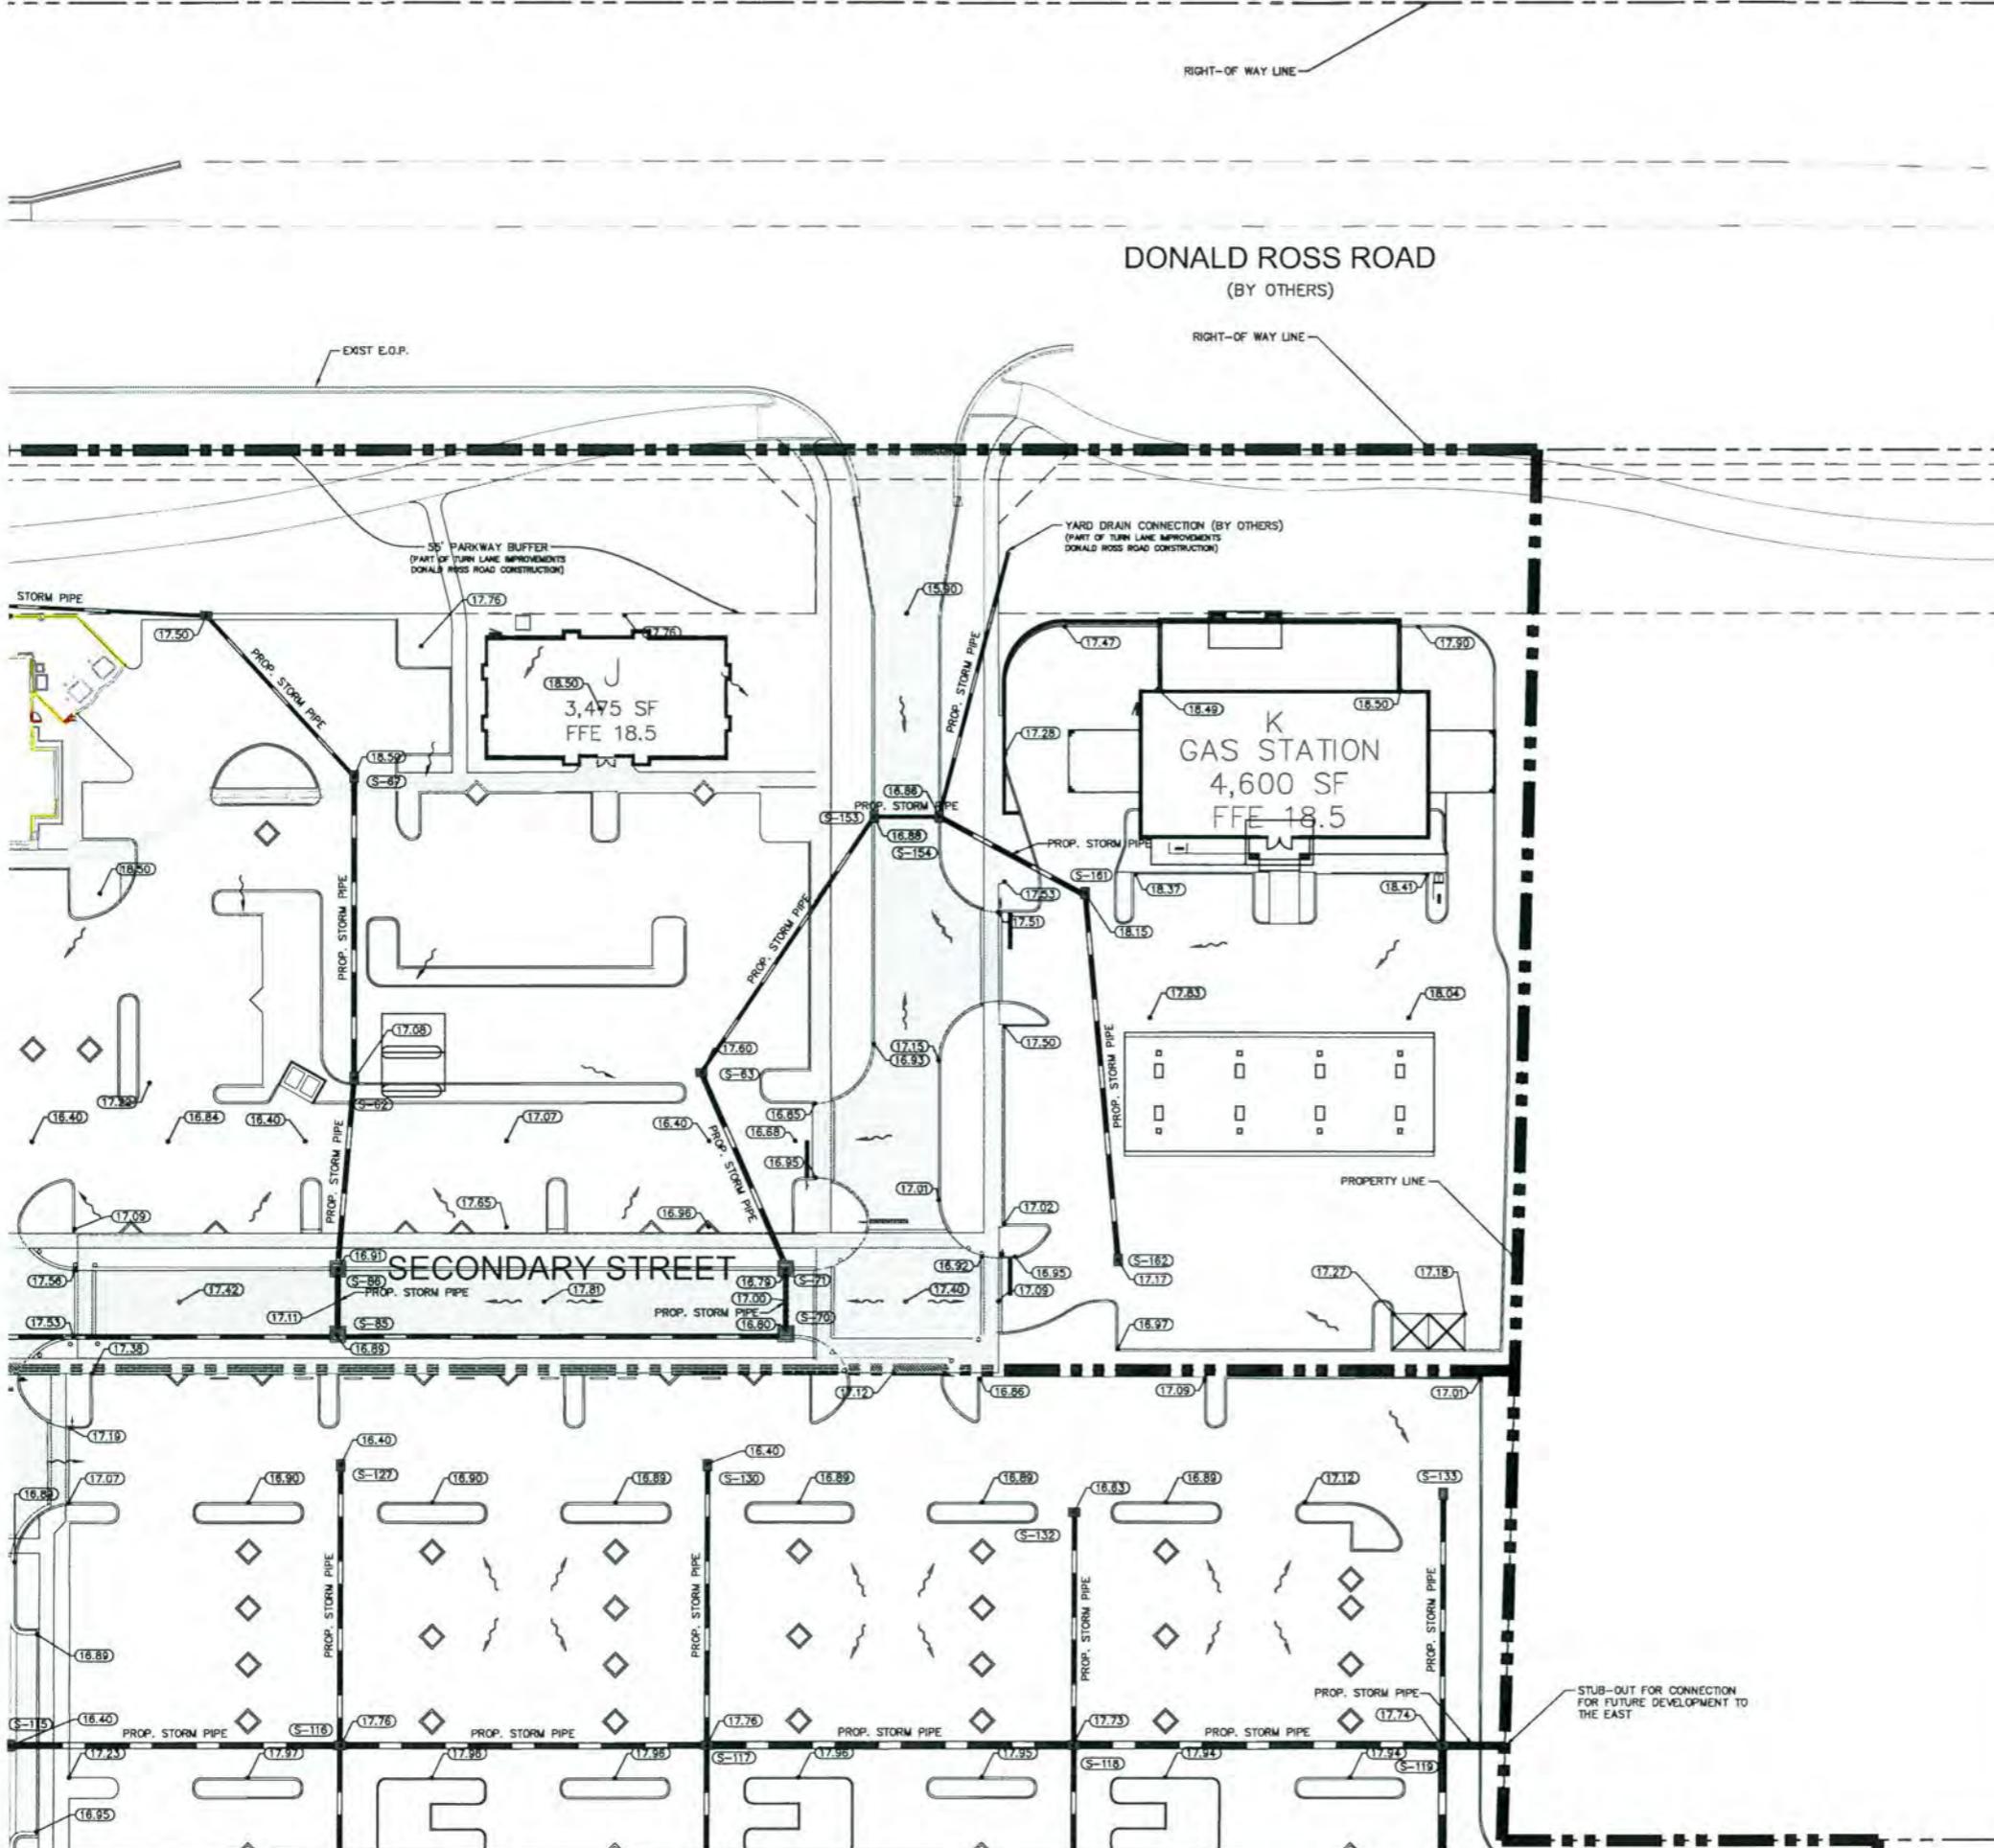


PAVING, GRADING, AND DRAINAGE NOTES:

1. DRAINAGE STRUCTURES SHALL BE CONSTRUCTED USING U.S. PRECAST (UP), U.S. FOUNDRY (USF), OR FLORIDA DEPARTMENT OF TRANSPORTATION STANDARD (FDOT) PRODUCTS AS SPECIFIED, OR APPROVED EQUAL.
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LEGEND

	PROPERTY LINE AND/OR RIGHT-OF-WAY LINE
	PROPOSED BUILDING OUTLINE
	PROP. ASPHALT PAVEMENT AND DRIVE CONSTRUCTION
	PROP. SIDEWALK
	EXIST. GRADE ELEVATION (NAVD)
	PROP. GRADE ELEVATION (NAVD)
	PROP. FLOW/SLOPE ARROW
	STRUCTURE NUMBER

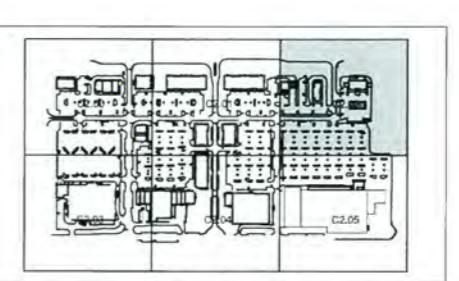

SHEET MAP

N.T.S.

ALTON TOWN CENTER PAVING GRADING AND DRAINAGE PLAN
PREPARED FOR NORTH AMERICAN DEVELOPMENT GROUP
PALM BEACH GARDENS

SHEET NUMBER C2.02



Kimley-Horn

KIMLEY-HORN AND ASSOCIATES, INC.
620 S. COASTAL DRIVE, SUITE 100, DELRAY BEACH, FL 33445
PHONE: 561-234-5700 FAX: 561-865-8175
WWW.KH.COM

REVISIONS	DATE	BY
NO.		
REVISIONS		
DATE		
BY		

KHA PROJECT 144981000	
DATE	SEPT. 2016
SCALE AS SHOWN	1:500
DESIGNED BY	MICHAEL SCHWARTZ, P.E.
DRAWN BY	JESSE JONES
CHECKED BY	MICHAEL SCHWARTZ

PROFESSIONAL ENGINEER
MICHAEL SCHWARTZ, P.E.
FL. LICENSE NUMBER
56200104
PROFESSIONAL ENGINEER
MICHAEL SCHWARTZ, P.E.
FL. LICENSE NUMBER
56200104
9-19-16

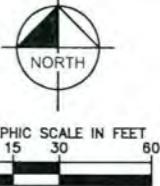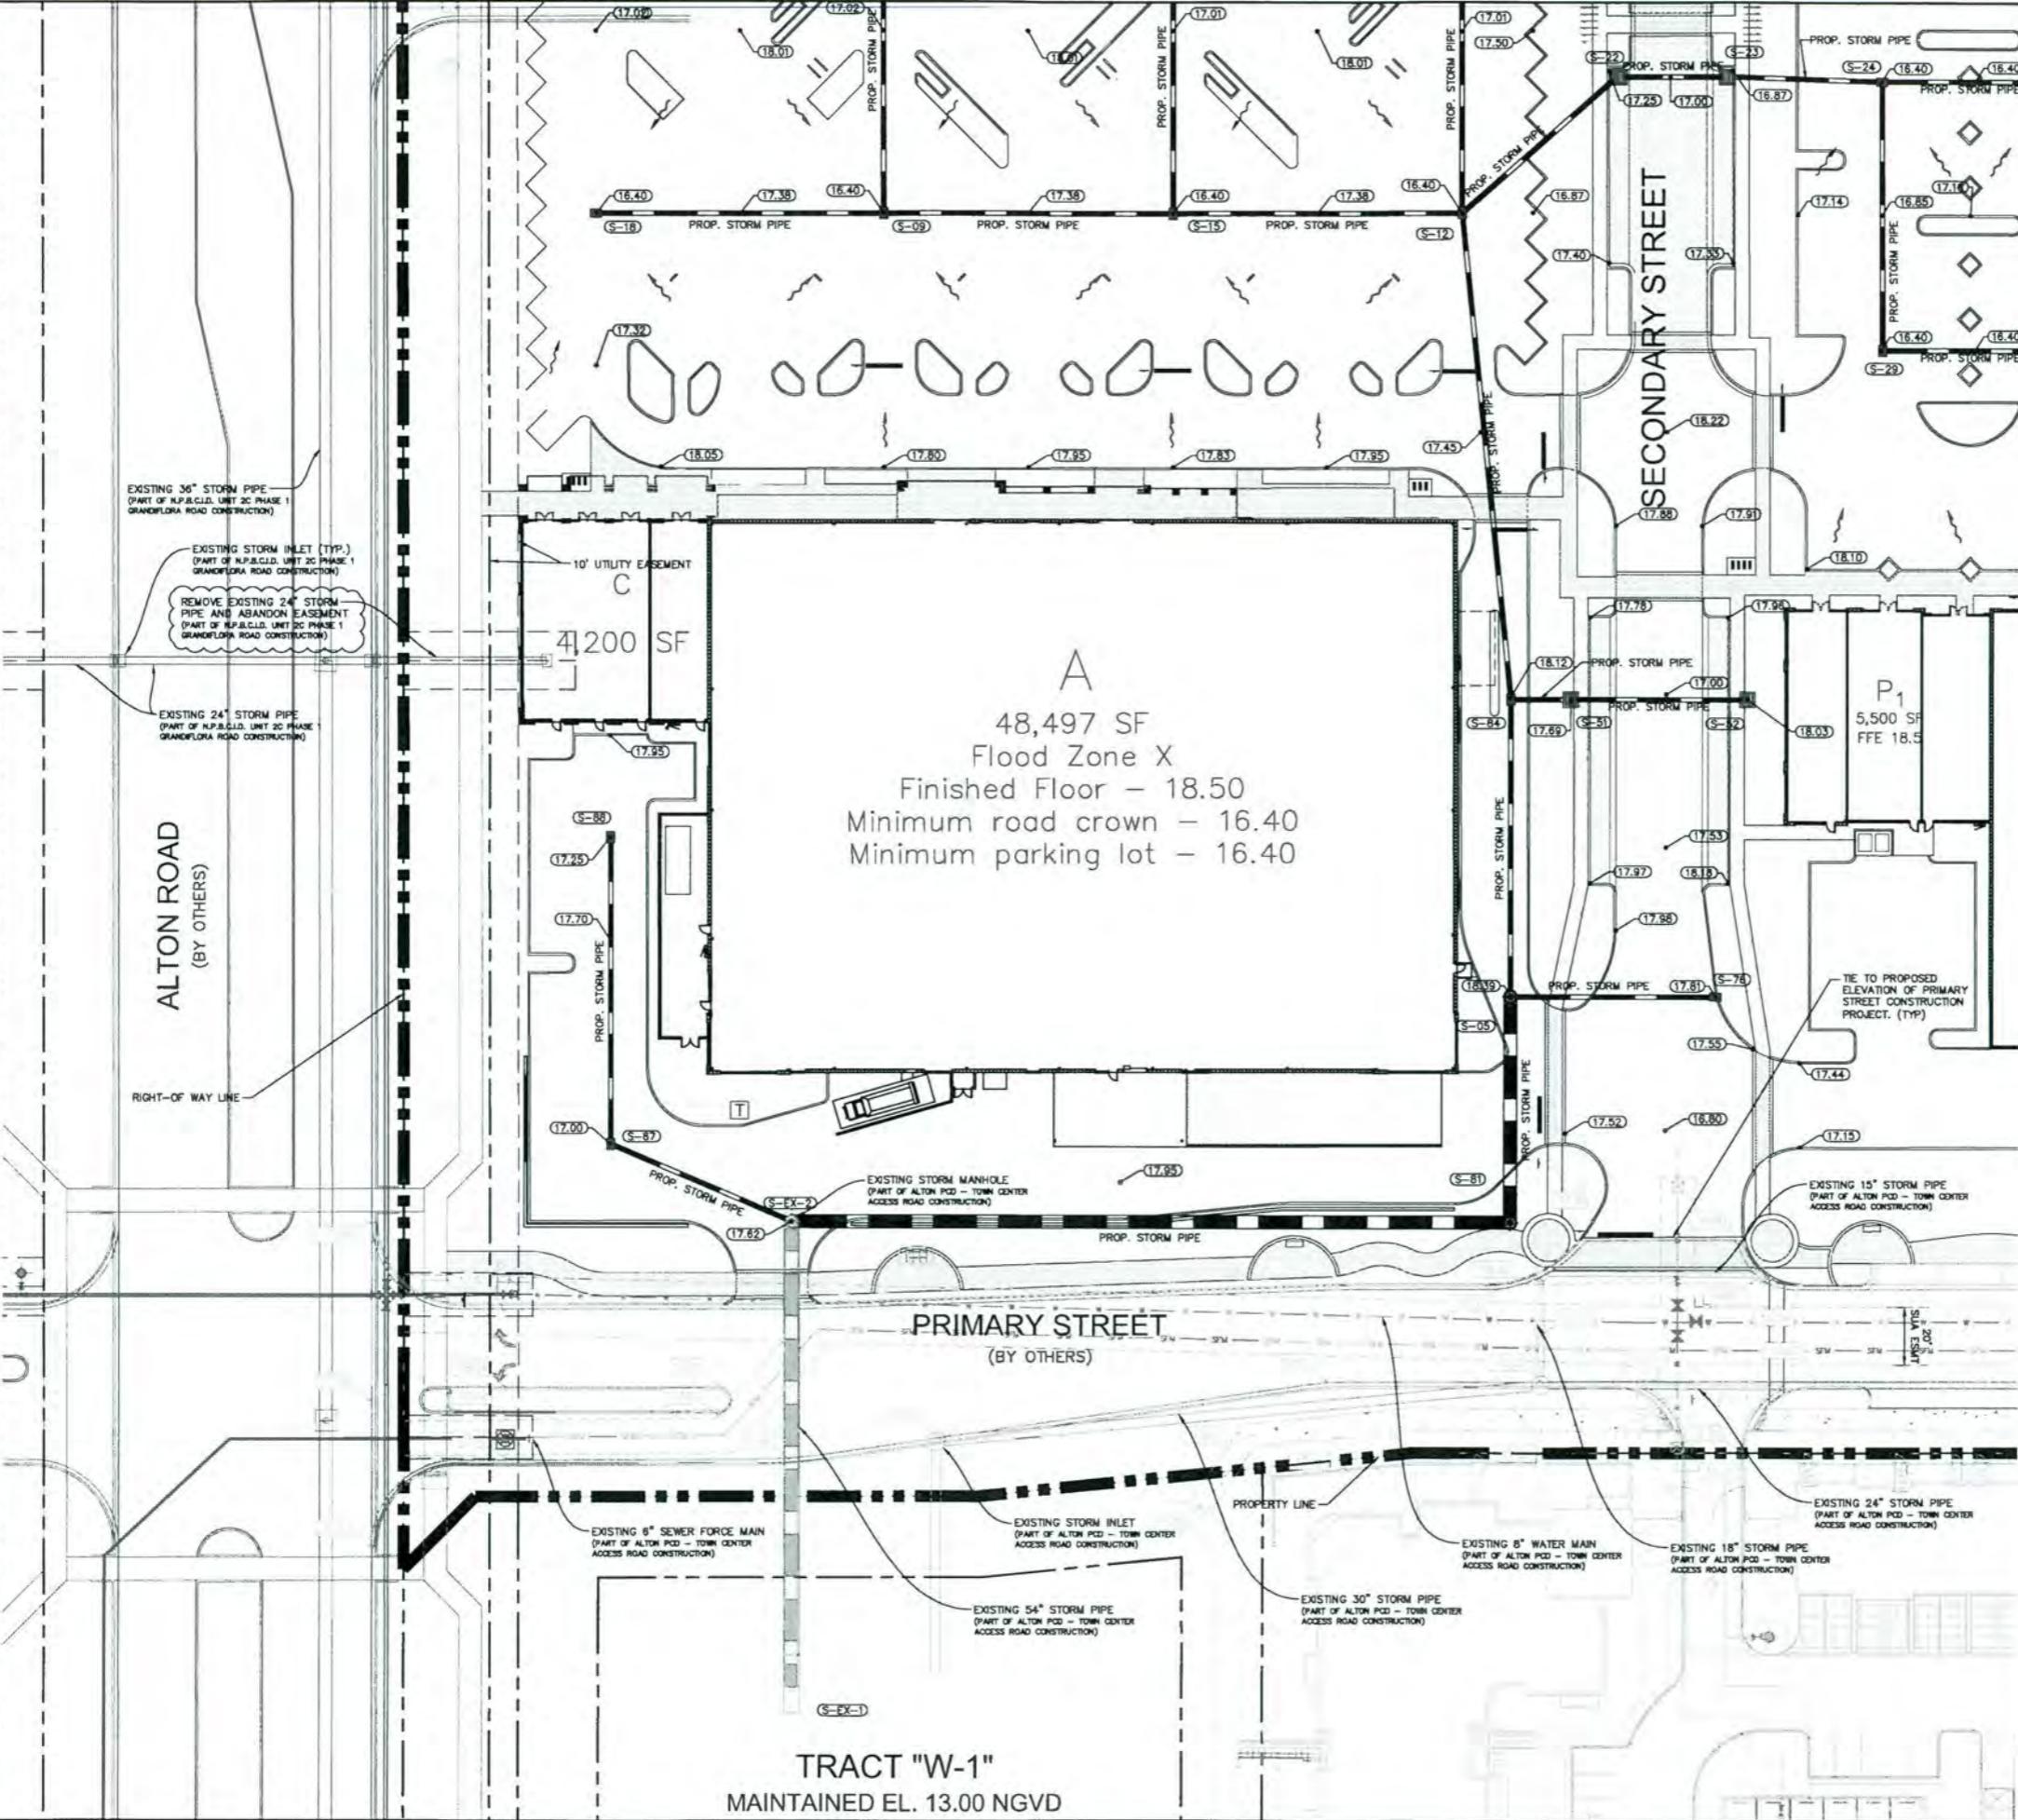

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 2. ALL STORM STRUCTURES SHALL HAVE A MINIMUM 18" SUMP.
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LEGEND

PROPERTY LINE AND/OR RIGHT-OF-WAY LINE

PROPOSED BUILDING OUTLINE

PROP. ASPHALT PAVEMENT AND DRIVE CONSTRUCTION

PROP. SIDEWALK

EXIST. GRADE ELEVATION (NAVD)


PROP. GRADE ELEVATION (NAVD)

PROP. FLOW/SLOPE ARROW

S-1 STRUCTURE NUMBER

PAVING GRADING AND DRAINAGE PLAN


ALTON TOWN CENTER
PREPARED FOR
NORTH AMERICAN
DEVELOPMENT GROUP
PALM BEACH

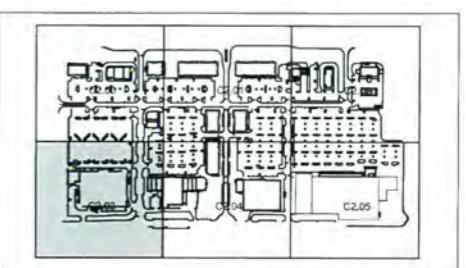

SHEET MAP

SHEET NUMBER
C2.03

RECORDED IN THE OFFICE OF THE CLERK OF THE COUNTY OF DODGE, STATE OF WISCONSIN, ON THE 10th DAY OF NOVEMBER, 2016, BY JEFFREY R. HARRIS, CLERK.

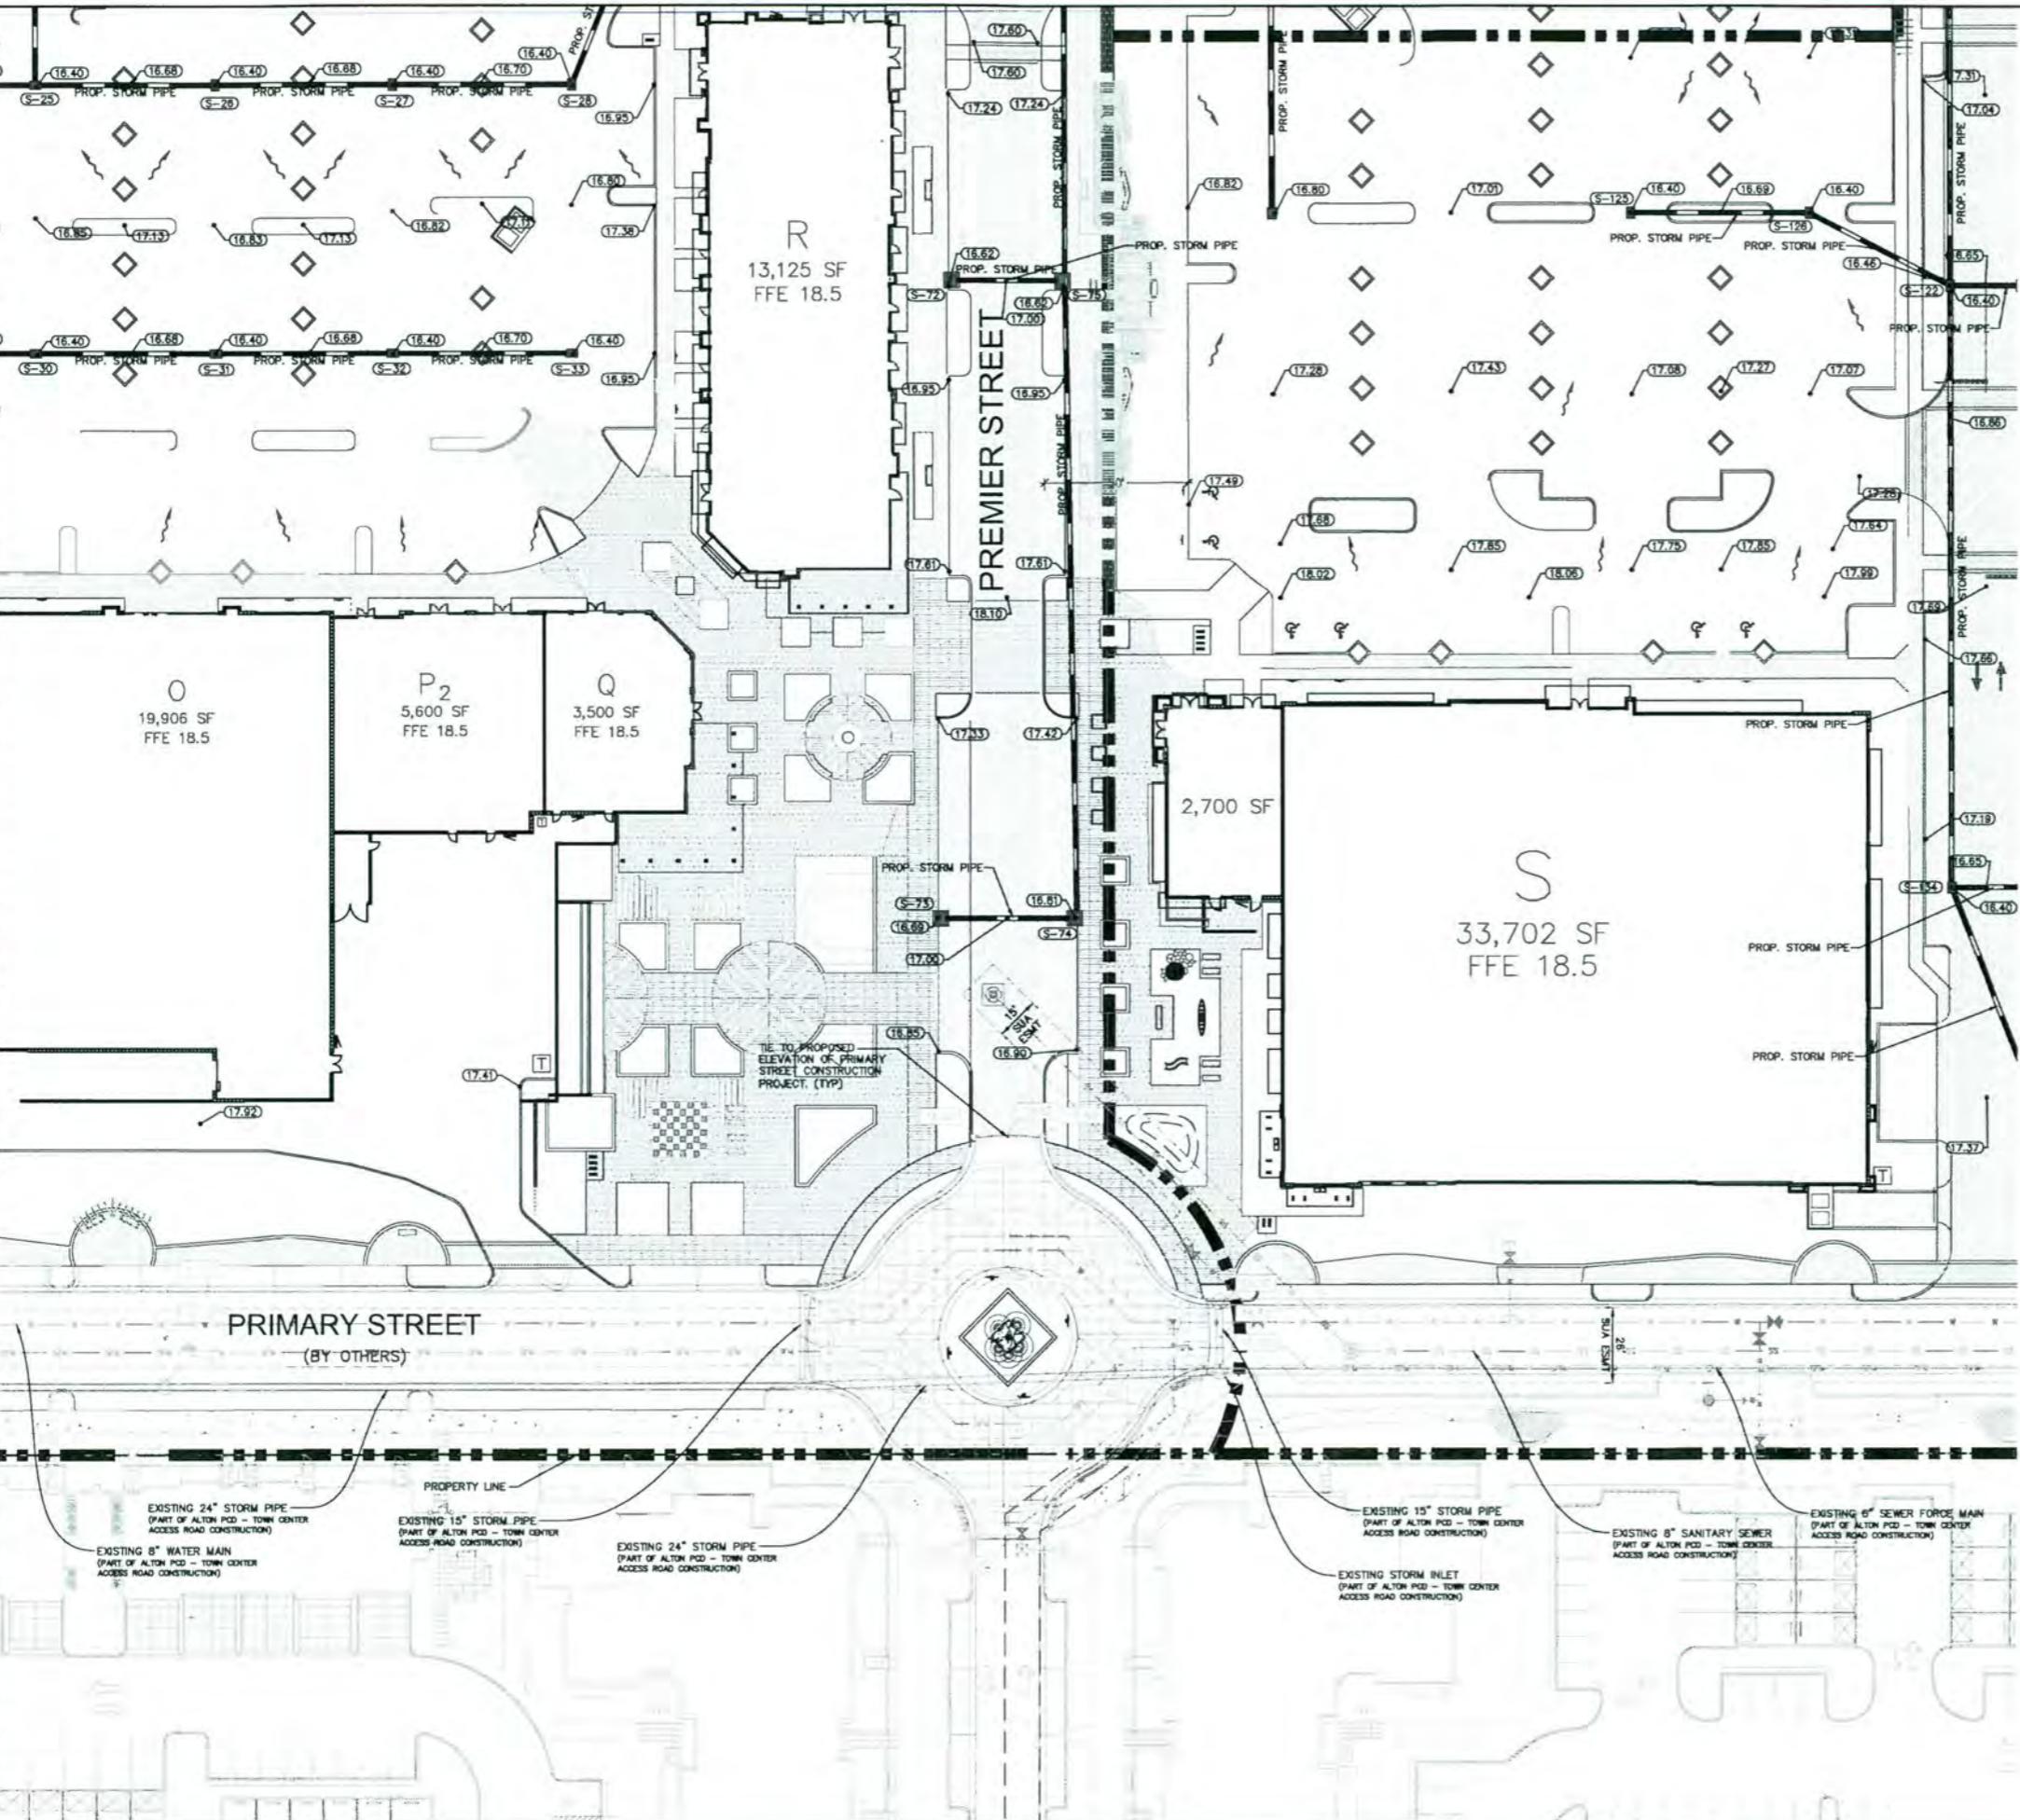

A horizontal graphic scale labeled "GRAPHIC SCALE IN FEET" at the top. Below the label is a horizontal line with tick marks. The first tick mark is labeled "0". The second tick mark is labeled "15". The third tick mark is labeled "30". The fourth tick mark is labeled "60".

PAVING, GRADING, AND DRAINAGE NOTES:

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 3. ALL STORM PIPE SHALL BE REINFORCED CONCRETE PIPE (RCP) OR HIGH DENSITY POLY-ETHYLENE (HDPE) PIPE.
 4. ALL PIPE LENGTHS ARE MEASURED FROM CENTER OF STRUCTURES UNLESS OTHERWISE NOTED.
 5. THE CROSS SLOPE ON ADA ACCESSIBLE ROUTES SHALL NOT EXCEED 2.0%. THE LONGITUDINAL SLOPE ON ADA ACCESSIBLE ROUTES (NOT INCLUDING RAMPS) SHALL NOT EXCEED 5.0%. THE LONGITUDINAL SLOPE FOR RAMPS SHALL NOT EXCEED 12:1 (8.3%).
 6. PROPOSED ELEVATIONS IN ALL PERVIOUS AREAS REPRESENT FINISHED TOP OF SOD/GRASS OR ANY OTHER LANDSCAPING MATERIAL.
 7. ALL ROOF LEADERS SHALL BE PVC SDR-35 AND SHALL HAVE A MINIMUM OF 1% SLOPE, UNLESS OTHERWISE NOTED.
 8. CONTRACTOR SHALL PROVIDE ALL FITTINGS, COUPLINGS, OR ADAPTERS NECESSARY TO CONNECT TO THE BUILDING PLUMBING AND TO CONNECT ROOF LEADERS TO THE MAIN STORM LINES.
 9. CONTRACTOR SHALL SUPPORT AND PROTECT ALL EXISTING AND PROPOSED UTILITIES WHEN CONSTRUCTING NEW DRAINAGE STRUCTURES AND PIPES.

LEGEND

PROPERTY LINE AND/OR RIGHT-OF-WAY LINE
PROPOSED BUILDING OUTLINE

PROP. ASPHALT PAVEMENT AND DRIVE CONSTRUCTION

PROP. SIDEWALK

EXIST. GRADE ELEVATION (NAVD)

PROP. GRADE ELEVATION (NAVD)

PROP. FLOW/SLOPE ARROW

STRUCTURE NUMBER




PAVING GRADING
AND DRAINAGE
PLAN

ALTON TOWN CENTER
PREPARED FOR
NORTH AMERICAN
DEVELOPMENT GROUP
PALM BEACH

SHEET NUMBER
C2.04

This figure is an architectural site plan for the Garden Center area, dated September 19, 2016. The plan includes the following key features:

- Building Footprint:** The "Garden Center" building is shown with a footprint of 19,379 SF and a Fire Factor Equivalent (FFE) of 18.5.
- Stormwater Management:** The plan shows a network of "PROP. STORM PIPE" lines and various storm inlets. A specific inlet is labeled "EXISTING STORM INLET (PART OF ALTON PCD - TOWN CENTER ACCESS ROAD CONSTRUCTION)".
- Utilities:**
 - A "PRIMARY STREET (BY OTHERS)" is shown at the bottom left.
 - An "EXISTING 6" WATER MAIN" and an "EXISTING 6" SEWER FORCE MAIN" are indicated near the bottom center.
 - "PROP. STORM PIPE" lines connect the building to the street network.
- Landmarks:** A "PROPERTY LINE" is marked with a dashed line. A "T" symbol is located near the top right corner.
- Labels and Reference:** Labels include "Garden Center 19,379 SF", "FFE 18.5", "PRIMARY STREET (BY OTHERS)", "EXISTING 6" WATER MAIN (PART OF ALTON PCD - TOWN CENTER ACCESS ROAD CONSTRUCTION)", "EXISTING 6" SEWER FORCE MAIN (PART OF ALTON PCD - TOWN CENTER ACCESS ROAD CONSTRUCTION)", and "PROPERTY LINE".

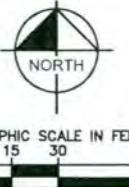

GRAPHIC SCALE IN FEET

PAVING, GRADING, AND DRAINAGE NOTES:

1. DRAINAGE STRUCTURES SHALL BE CONSTRUCTED USING U.S. PRECAST (USP), U.S. FOUNDRY (USF), OR FLORIDA DEPARTMENT OF TRANSPORTATION STANDARD (FDOT) PRODUCTS AS SPECIFIED, OR APPROVED EQUAL.
 2. ALL STORM STRUCTURES SHALL HAVE A MINIMUM 18" SUMP.
 3. ALL STORM PIPE SHALL BE REINFORCED CONCRETE PIPE (RCP) OR HIGH DENSITY POLY-ETHYLENE (HDPE) PIPE.
 4. ALL PIPE LENGTHS ARE MEASURED FROM CENTER OF STRUCTURES UNLESS OTHERWISE NOTED.
 5. THE CROSS SLOPE ON ADA ACCESSIBLE ROUTES SHALL NOT EXCEED 2.0%, THE LONGITUDINAL SLOPE ON ADA ACCESSIBLE ROUTES (NOT INCLUDING RAMPS) SHALL NOT EXCEED 5.0%. THE LONGITUDINAL SLOPE FOR RAMPS SHALL NOT EXCEED 12:1 (8.3%).
 6. PROPOSED ELEVATIONS IN ALL PERVERIOUS AREAS REPRESENT FINISHED TOP OF SOIL/GRASS OR ANY OTHER LANDSCAPING MATERIAL.
 7. ALL ROOF LEADERS SHALL BE PVC SDR-35 AND SHALL HAVE A MINIMUM OF 1% SLOPE, UNLESS OTHERWISE NOTED.
 8. CONTRACTOR SHALL PROVIDE ALL FITTINGS, COUPLINGS, OR ADAPTERS NECESSARY TO CONNECT TO THE BUILDING PLUMBING AND TO CONNECT ROOF LEADERS TO THE MAIN STORM LINES.
 9. CONTRACTOR SHALL SUPPORT AND PROTECT ALL EXISTING AND PROPOSED UTILITIES WHEN CONSTRUCTING NEW DRAINAGE STRUCTURES AND PIPES.

LEGEND

PROPERTY LINE AND/OR RIGHT-OF-WAY LINE
PROPOSED BUILDING OUTLINE

PROP. ASPHALT PAVEMENT AND DRIVE CONSTRUCTION

PROP. SIDEWALK

EXIST. GRADE ELEVATION (NAVD)

PROP. GRADE ELEVATION (NAVD)

PROP. FLOW/SLOPE ARROW


STRUCTURE NUMBER

PAVING GRADING AND DRAINAGE PLAN

ALTON TOWN CENTER
PREPARED FOR
NORTH AMERICAN
DEVELOPMENT GROUP
PALM BEACH

RIGHT-OF WAY LINE

DONALD ROSS ROAD
(BY OTHERS)

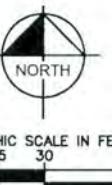

GRAPHIC SCALE IN FEET
0 15 30 60

UTILITY NOTES:

1. CONTRACTOR SHALL VERIFY LOCATION OF ALL EXISTING UTILITIES.
2. IT SHALL BE THE CONTRACTOR'S SOLE RESPONSIBILITY TO TAKE THE NECESSARY PRECAUTIONS TO ENSURE PROPER SAFETY AND WORKMANSHIP WHEN WORKING IN THE VICINITY OF EXISTING UTILITY LINES.
3. CONTRACTOR SHALL BE RESPONSIBLE TO COORDINATE WITH FPL ON ANY WORK IN THE VICINITY OF OVERHEAD OR UNDERGROUND POWER LINES.
4. CONTRACTOR SHALL VERIFY PROPERTY CLEARANCE BELOW EXISTING OVERHEAD POWER LINES PRIOR TO WORKING WITHIN THE VICINITY OF THE POWER LINES.
5. ALL WATER MAIN (WM) SHALL BE DIP UNLESS OTHERWISE NOTED.
6. ALL FIRE MAIN (FM) SHALL BE DIP UNLESS OTHERWISE NOTED. RESTRAIN ALL JOINTS. ALL FIRE MAIN SHALL BE INSTALLED BY A CERTIFIED FIRE SPRINKLER CONTRACTOR.
7. ALL DUCTILE IRON PIPE (DIP) SHALL BE CLASS S1 UNLESS OTHERWISE NOTED. ALL DIP SHALL BE MARKED PER FLORIDA DEPARTMENT OF ENVIRONMENTAL PROTECTION (FDEP) STANDARDS.
8. ALL WATER MAIN, FIRE MAIN, AND FORCE MAIN SHALL HAVE A MINIMUM 30° COVER OVER THE TOP OF THE PIPE UNLESS OTHERWISE NOTED.
9. ALL FITTINGS FOR WATER MAIN AND FIRE MAIN SHALL BE DUCTILE IRON MECHANICAL JOINT FITTINGS UNLESS OTHERWISE NOTED.
10. ALL GRAVITY SEWER MAIN (SS) AND LATERALS SHALL BE PVC SDR-28 UNLESS OTHERWISE NOTED.
11. CONTRACTOR SHALL SUPPORT AND PROTECT ALL EXISTING AND PROPOSED UTILITIES WHEN CONSTRUCTING NEW UTILITIES.
12. CONTRACTOR SHALL FURNISH AND INSTALL NECESSARY PIPE AND FITTINGS TO TRANSITION PIPE MATERIALS WHEN REQUIRED AND TO CONNECT TO BUILDING PLUMBING.
13. ALL MANHOLES, VALVES, CLEANOUTS AND OTHER SUCH BOXES IN PAVEMENT OR SIDEWALKS SHALL BE SET FLUSH WITH PAVEMENT TO MATCH THE PROPOSED SLOPE AND SHALL BE H-20 TRAFFIC RATED.
14. BLUE REFLECTIVE HYDRANT LOCATION MARKERS SHALL BE PLACED ON THE ACCESS ROADS IN FRONT OF ALL FIRE HYDRANTS. MARKERS SHALL BE PLACED IN THE MIDDLE OF THE DRIVE LANE ON THE SIDE OF THE ROAD CLOSEST TO THE FIRE HYDRANTS.

Kimley-Horn

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Phone: 561-2345 Fax: 561-3175
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WATER AND
SEWER PLAN


ALTON TOWN CENTER
PREPARED FOR
NORTH AMERICAN
DEVELOPMENT GROUP
PALM BEACH
GARDENS
FL

REVISIONS DATE BY

KHA PROJECT
144981000
DATE: 2/16
MICHAEL SCHWARTZ
AS SHOWN
JHD
DRAWN BY
HJD
CHECKED BY
HJD
FL LICENSE NUMBER
56200
FL STATE OF
FLORIDA
PROFESSIONAL
ENGINEERING
SHEET MAP
N.T.S.


LEGEND

1	GATE VALVE
2	FIRE HYDRANT ASSEMBLY
3	WATER METER AND RPZ
4	WATER METER BANK
5	DDCV, PIV AND FDC
6	SAN. SEWER MANHOLE
7	1,250 GAL. GREASE TRAP

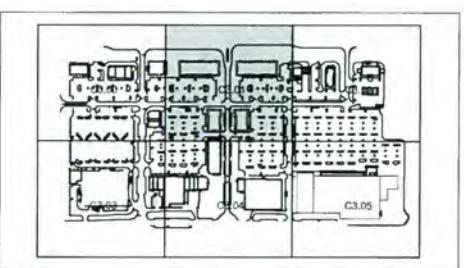

SHEET MAP

N.T.S.
SHEET NUMBER
C3.01

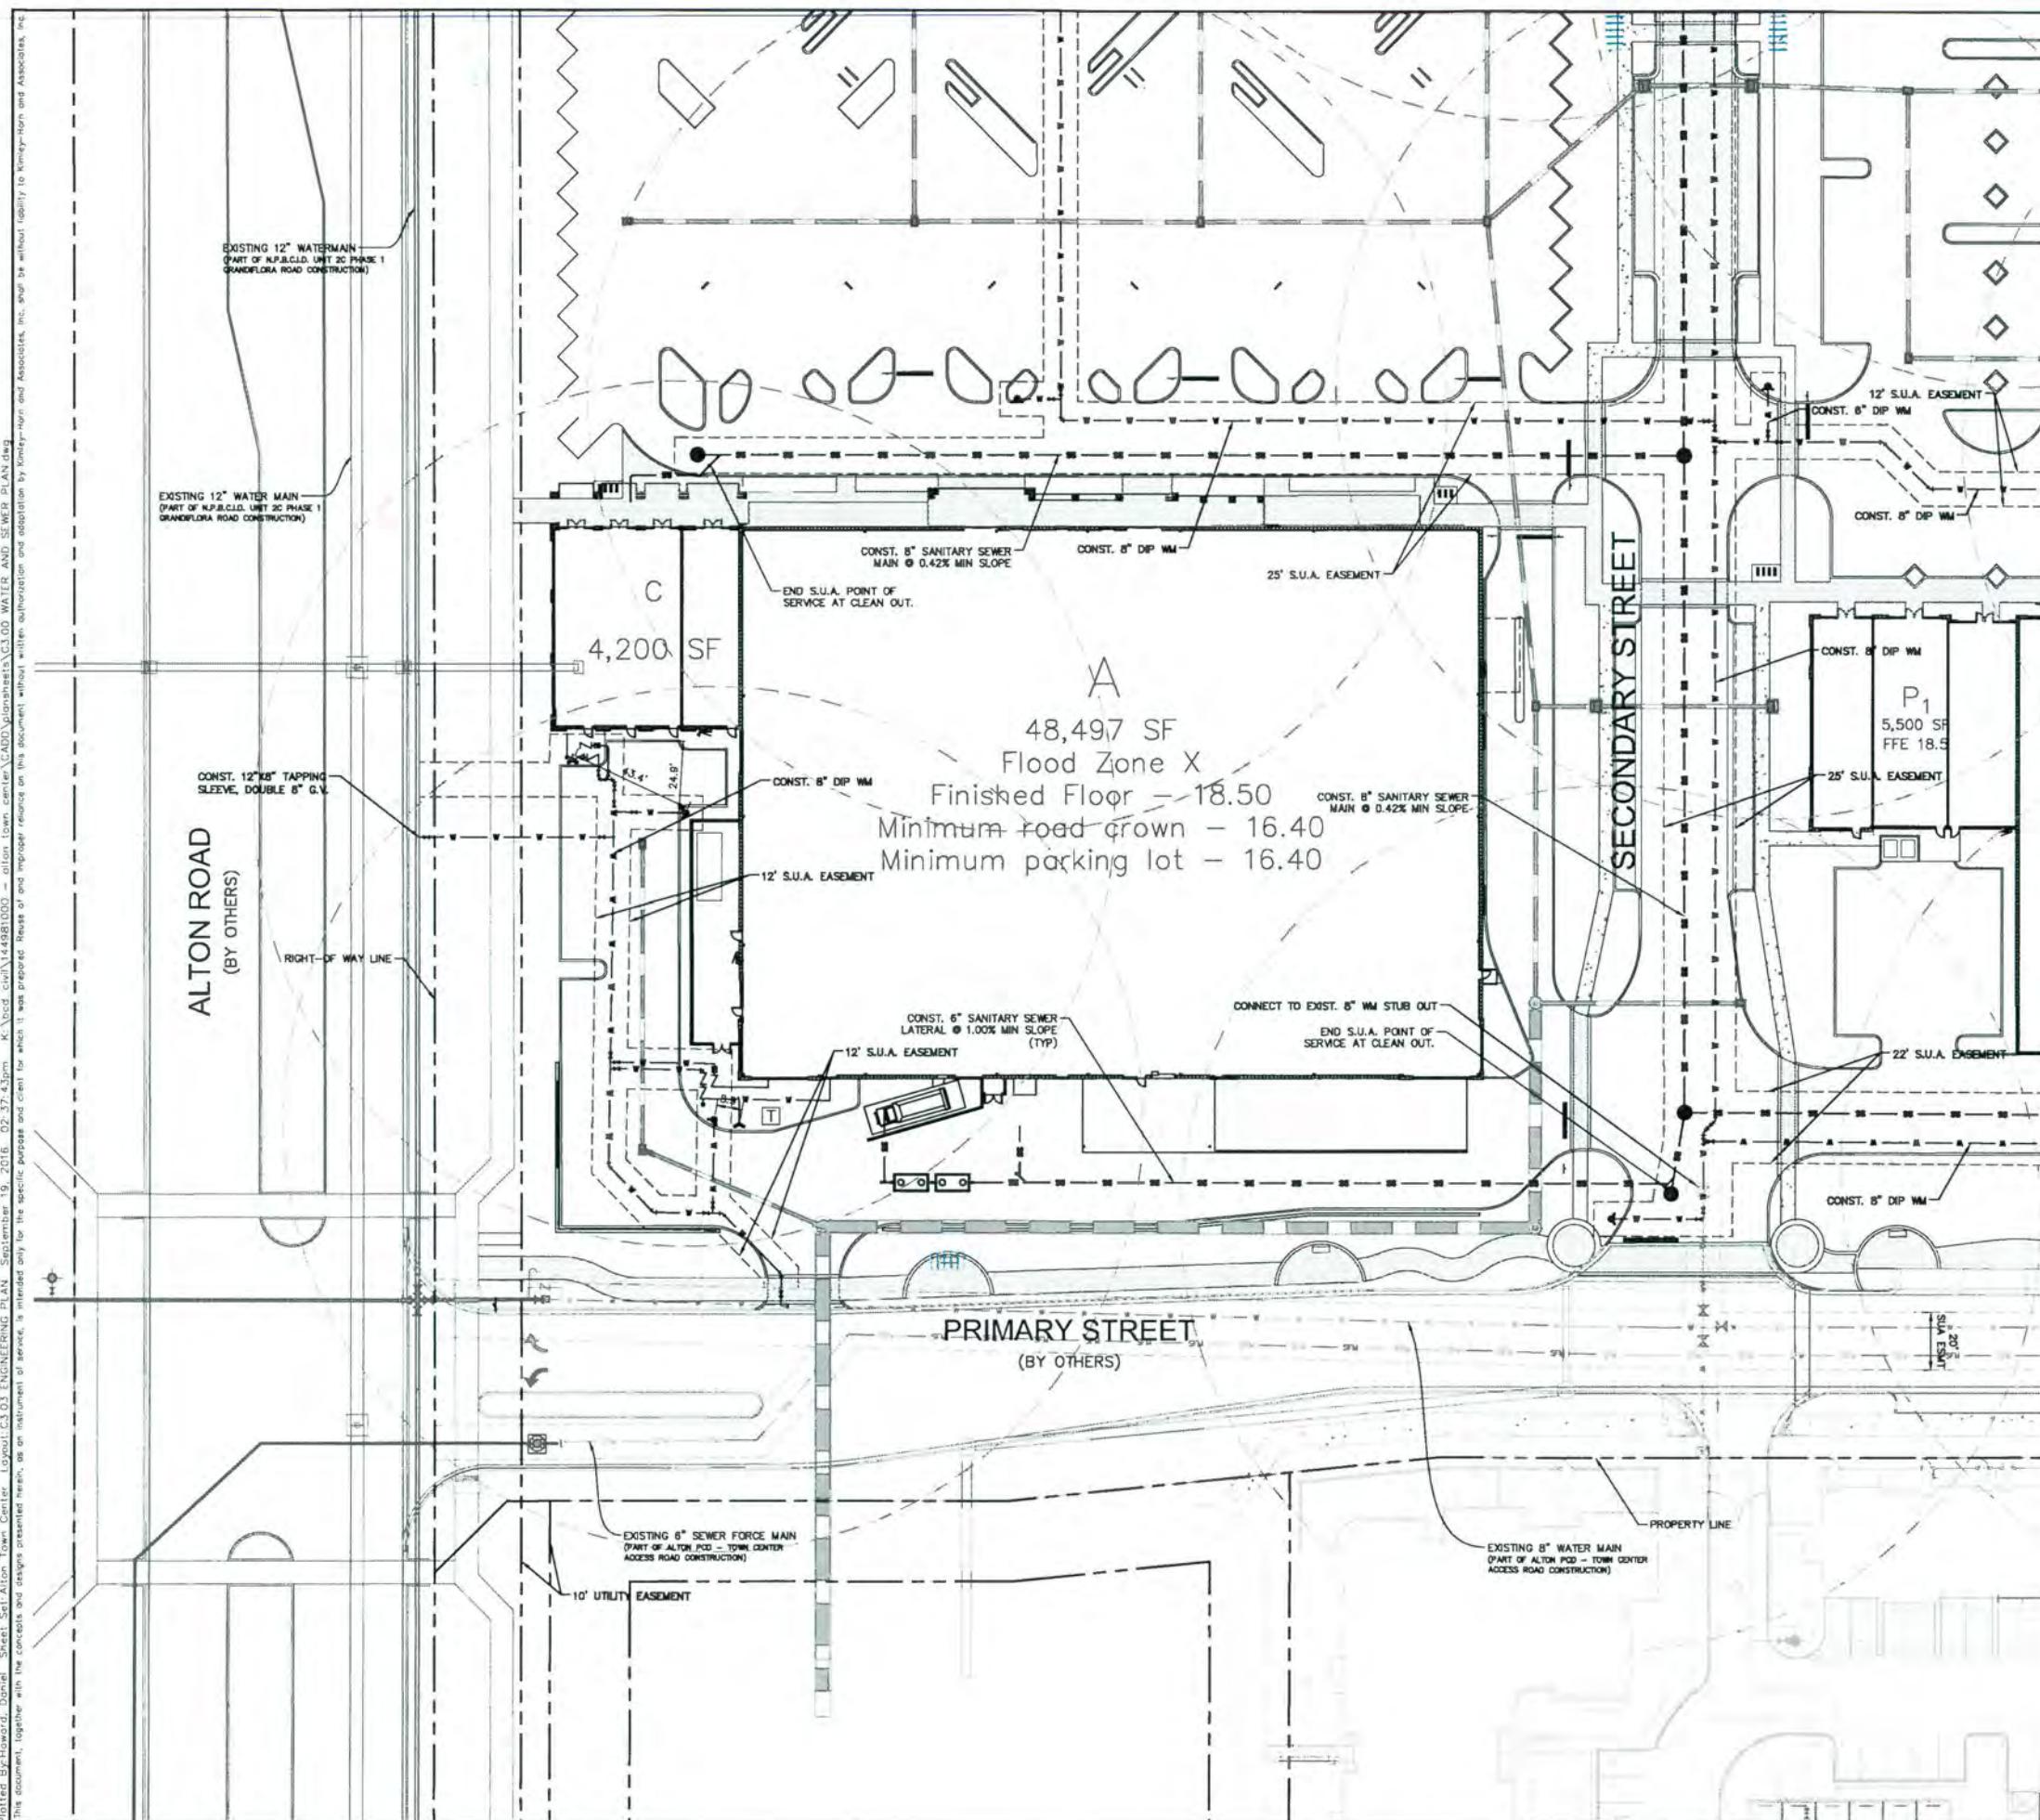

UTILITY NOTES:

1. CONTRACTOR SHALL VERIFY LOCATION OF ALL EXISTING UTILITIES.
2. IT SHALL BE THE CONTRACTOR'S SOLE RESPONSIBILITY TO TAKE THE NECESSARY PRECAUTIONS TO ENSURE PROPER SAFETY AND WORKMANSHIP WHEN WORKING IN THE VICINITY OF EXISTING UTILITY LINES.
3. CONTRACTOR SHALL BE RESPONSIBLE TO COORDINATE WITH FPL ON ANY WORK IN THE VICINITY OF OVERHEAD OR UNDERGROUND POWER LINES.
4. CONTRACTOR SHALL VERIFY PROPERTY CLEARANCE BELOW EXISTING OVERHEAD POWER LINES PRIOR TO WORKING WITHIN THE VICINITY OF THE POWER LINES.
5. ALL WATER MAIN (WM) SHALL BE DIP UNLESS OTHERWISE NOTED.
6. ALL FIRE MAIN (FM) SHALL BE DIP UNLESS OTHERWISE NOTED. RESTRAIN ALL JOINTS. ALL FIRE MAIN SHALL BE INSTALLED BY A CERTIFIED FIRE SPRINKLER CONTRACTOR.
7. ALL DUCTILE IRON PIPE (DIP) SHALL BE CLASS 51 UNLESS OTHERWISE NOTED. ALL DIP SHALL BE MARKED PER FLORIDA DEPARTMENT OF ENVIRONMENTAL PROTECTION (FDEP) STANDARDS.
8. ALL WATER MAIN, FIRE MAIN, AND FORCE MAIN SHALL HAVE A MINIMUM 30" COVER OVER THE TOP OF THE PIPE UNLESS OTHERWISE NOTED.
9. ALL FITTINGS FOR WATER MAIN AND FIRE MAIN SHALL BE DUCTILE IRON MECHANICAL JOINT FITTINGS UNLESS OTHERWISE NOTED.
10. ALL GRAVITY SEWER MAIN (SS) AND LATERALS SHALL BE PVC SDR-26 UNLESS OTHERWISE NOTED.
11. CONTRACTOR SHALL SUPPORT AND PROTECT ALL EXISTING AND PROPOSED UTILITIES WHEN CONSTRUCTING NEW UTILITIES.
12. CONTRACTOR SHALL FURNISH AND INSTALL NECESSARY PIPE AND FITTINGS TO TRANSITION PIPE MATERIALS WHEN REQUIRED AND TO CONNECT TO BUILDING PLUMBING.
13. ALL MANHOLES, VALVES, CLEANOUTS AND OTHER SUCH BOXES IN PAVEMENT OR SIDEWALKS SHALL BE SET FLUSH WITH PAVEMENT TO MATCH THE PROPOSED SLOPE AND SHALL BE H-20 TRAFFIC RATED.
14. BLUE REFLECTIVE HYDRANT LOCATION MARKERS SHALL BE PLACED ON THE ACCESS ROADS IN FRONT OF ALL FIRE HYDRANTS. MARKERS SHALL BE PLACED IN THE MIDDLE OF THE DRIVE LANE ON THE SIDE OF THE ROAD CLOSEST TO THE FIRE HYDRANTS.

KHA PROJECT NO. 144981000		DATE 09/16
SCALE AS SHOWN		FLUID NUMBER JRH
DESIGNED BY JRH		DRAWN BY JRH
CHECKED BY JRH		FL

WATER AND SEWER PLAN

ALTON TOWN CENTER
PREPARED FOR
NORTH AMERICAN
DEVELOPMENT GROUP
PALM BEACH
GARDENS

SHEET MAP
N.T.S.
SHEET NUMBER C3.03


Kimley Horn
2015 KIMLEY-HORN AND ASSOCIATES, INC., SUITE 100, DELRAY BEACH, FL 33445
PHONE: 561-330-2345 FAX: 561-863-8175
WWW.KIMLEY-HORN.COM CA 0000098

PROFESSIONAL ENGINEER
MICHAEL F. SCHWARTZ
FL. LICENSE NUMBER 56200
9/16/16
PROFESSIONAL

LEGEND

- GATE VALVE
- FIRE HYDRANT ASSEMBLY
- WATER METER AND RPZ
- WATER METER BANK
- DOCV, PIV AND FDC
- SAN. SEWER MANHOLE
- 1,250 GAL. GREASE TRAP

SHEET MAP
N.T.S.

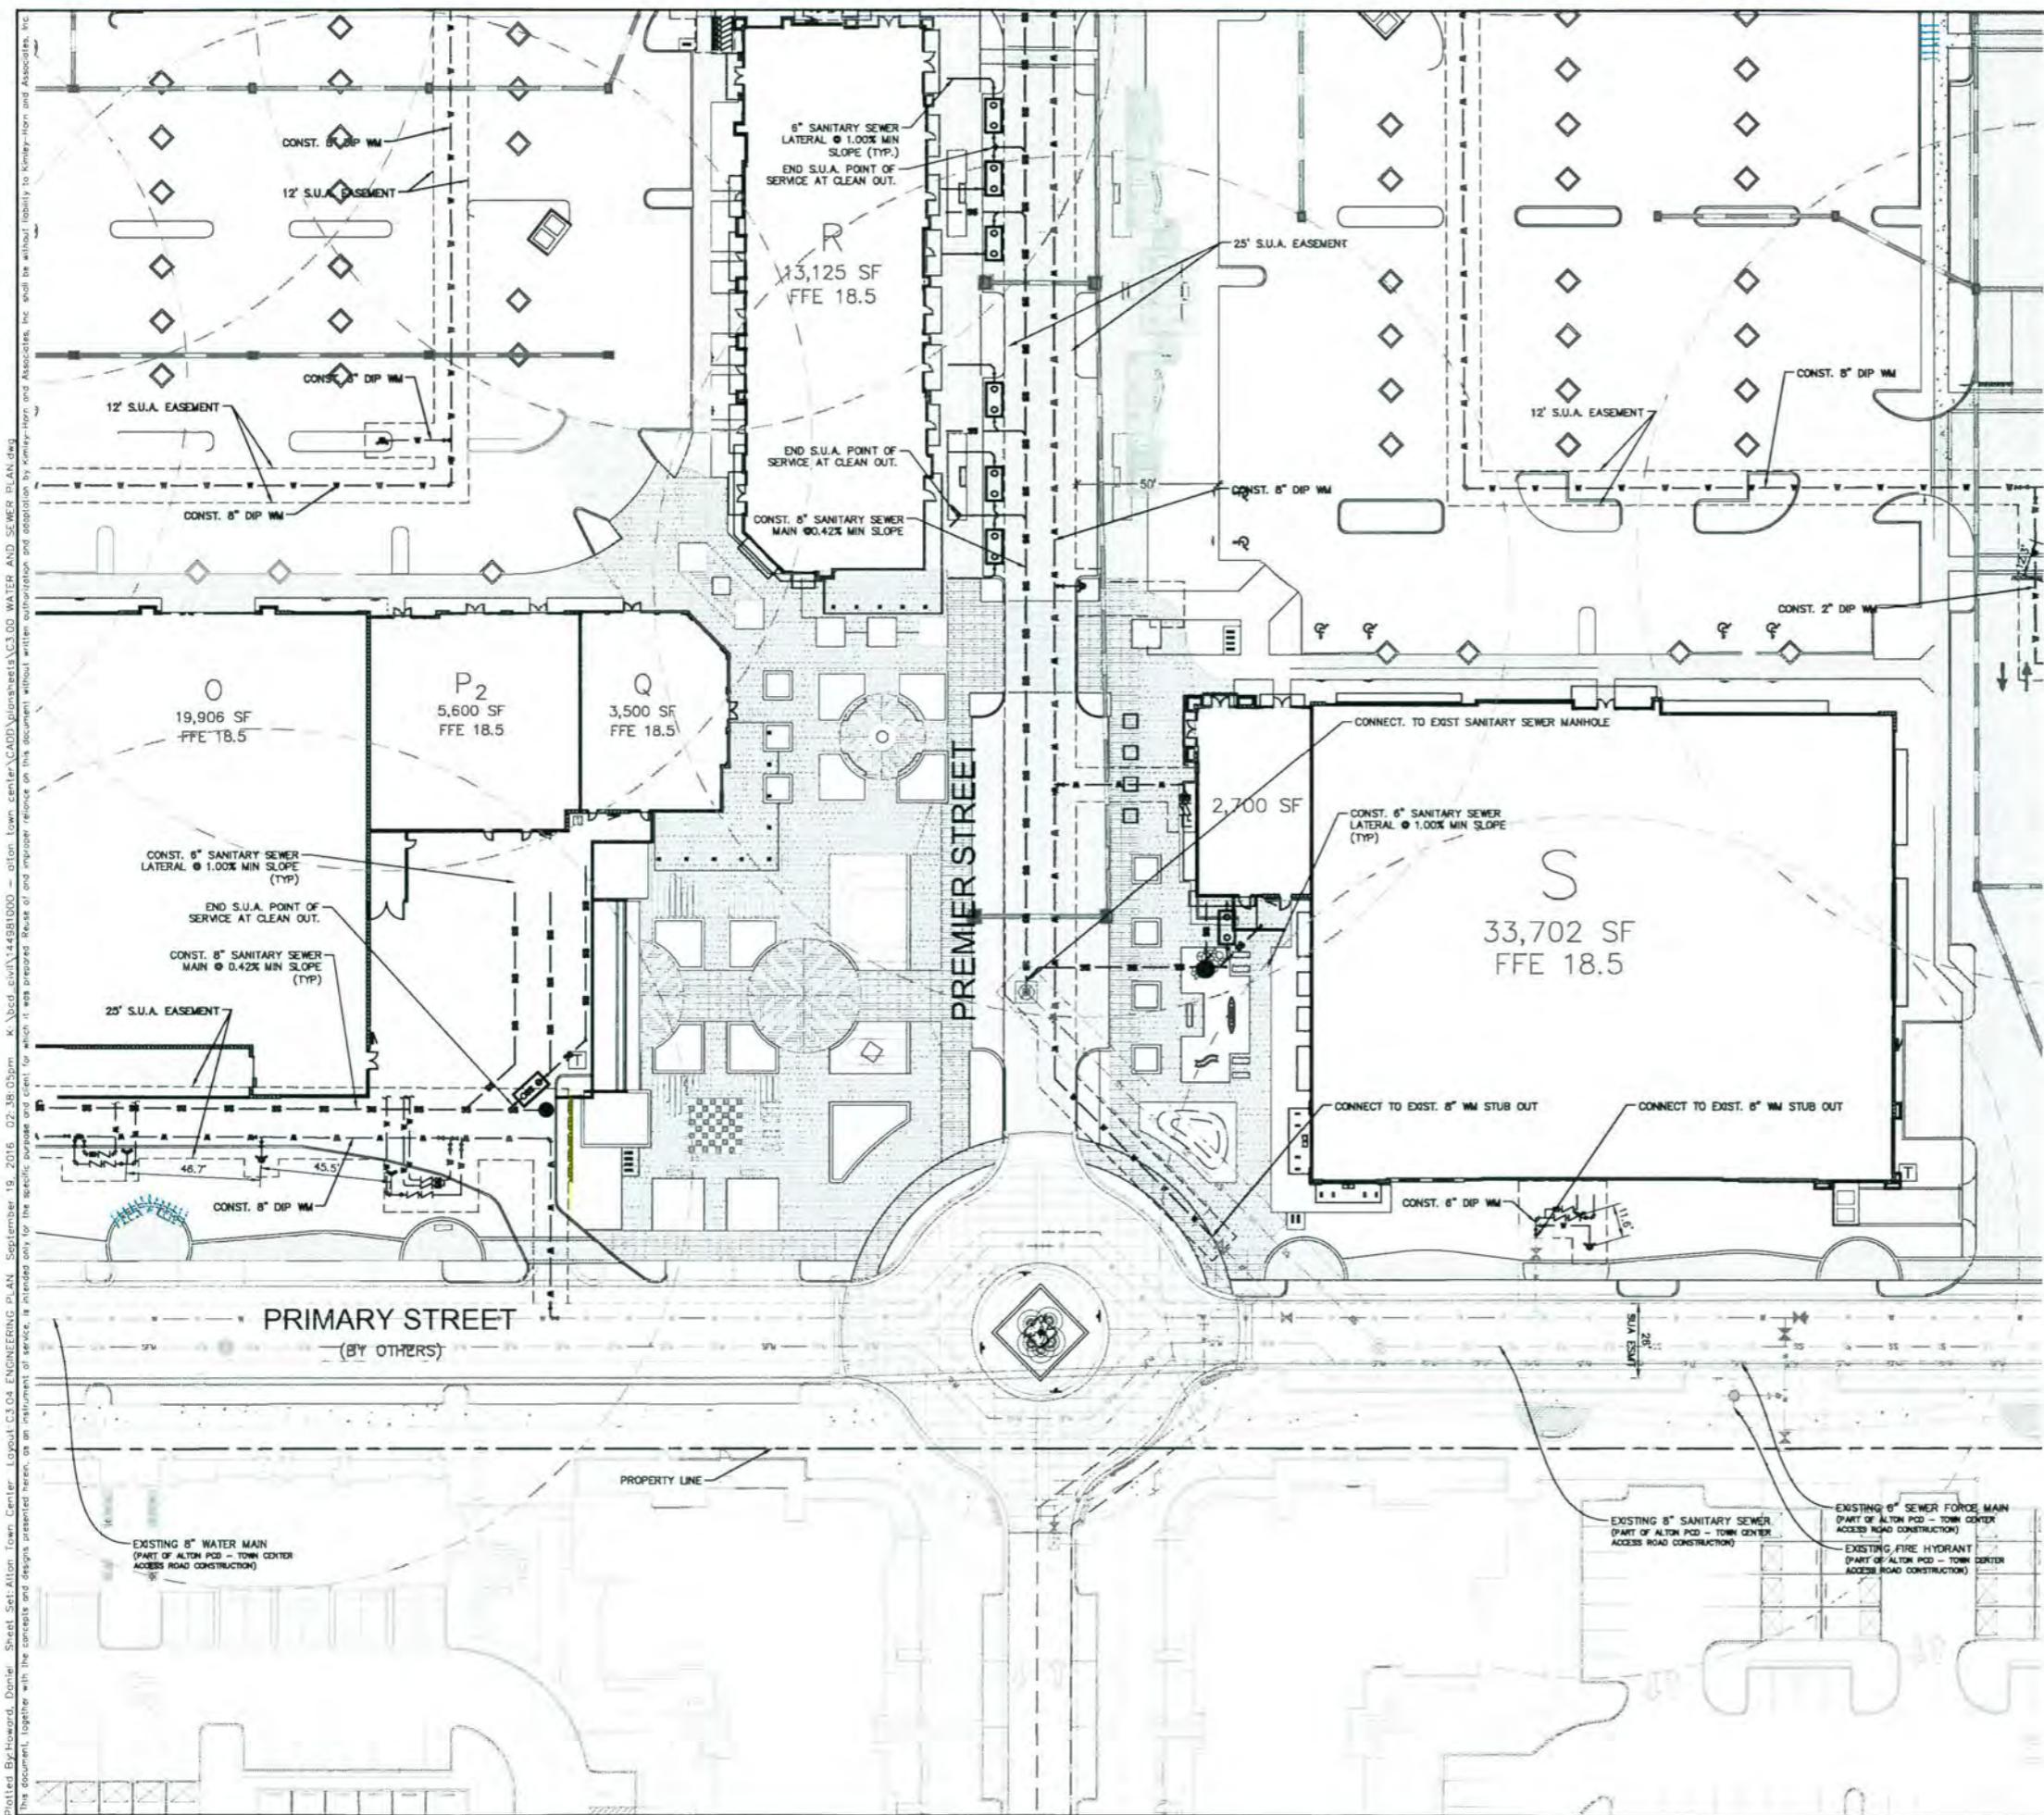

UTILITY NOTES:


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ALTON TOWN CENTER
PREPARED FOR
NORTH AMERICAN
DEVELOPMENT GROUP
PALM BEACH
GARDENS

Kinney & Horn


ENGINNEERS AND ASSOCIATES, INC.
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SHEET MAP		N.T.S.	
SHEET NUMBER		C3.04	
DATE		BY	
REVISIONS			
<p style="text-align: center;">KHA PROJECT 14481000 Date SEPT. 2016 Scale As Shown DESIGNED BY JHM DRAWN BY JHM CHECKED BY MJS</p> <p style="text-align: center;">MICHAEL FARNWORTH PE #56200 FL LICENSE NUMBER #0313000 56200 S-19-JHM 9-19-JHM E OF MISSISSIPPI RIVER</p>			



LEGEND

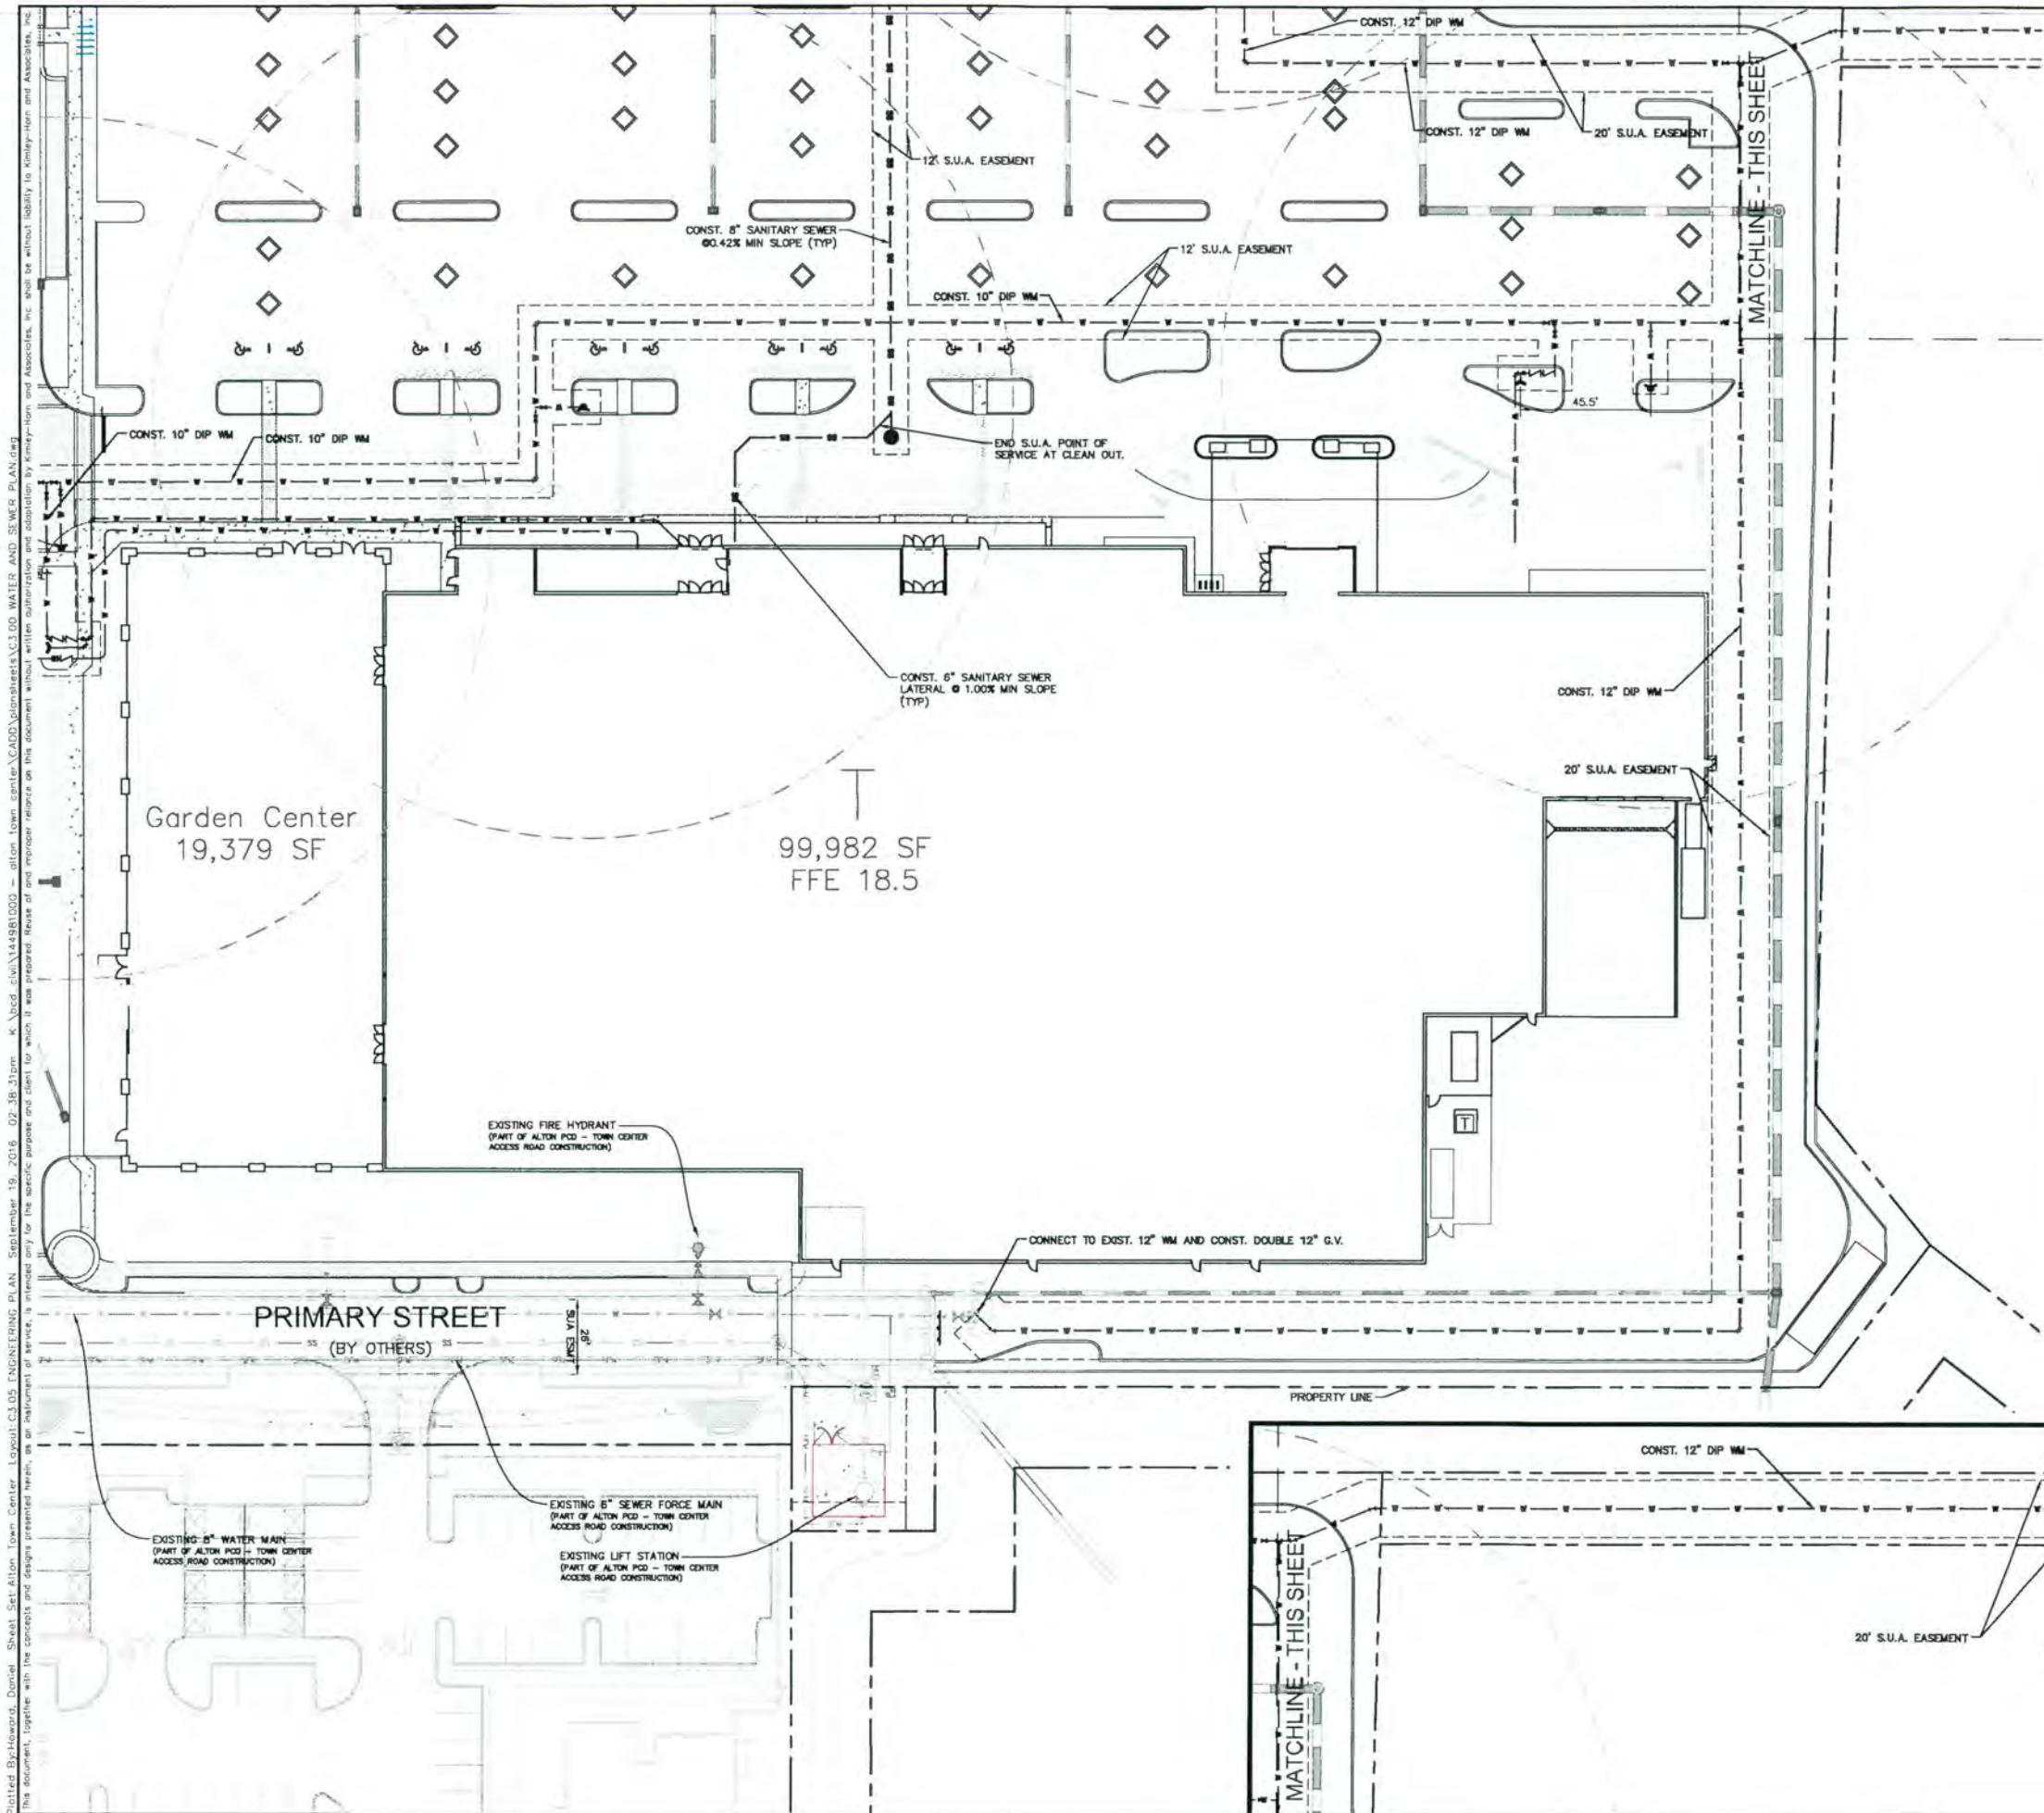▲	GATE VALVE
▲	FIRE HYDRANT ASSEMBLY
■	WATER METER AND RPZ
▨	WATER METER BANK
▢	DDCV, PIV AND FDC
●	SAN. SEWER MANHOLE
□	1,250 GAL. GREASE TRAP

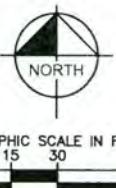

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Kimley » Horn

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FLORIDA
LICENSE #56200
MICHAEL F. SCHWARTZ,
AIA, NCARB
FL. LICENSE NUMBER 56200
SP-749-16

KHA PROJECT
144981000
DATE
SEPT. 2016
SCALE AS SHOWN
DESIGNED BY JRH
DRAWN BY JRH
CHECKED BY JRH
DATE

WATER AND
SEWER PLAN
SHEET MAP
N.T.S.

ALTON TOWN CENTER
PREPARED FOR
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PALM BEACH
GARDENS
SHEET NUMBER
C3.05